

# DISCRETIONARY APPLICATION For Public Display

#### **Applicant:**

**Smeekes Drafting** 

**Location:** 

1910 Tunbridge Tier Road, Interlaken

Proposal:

**Dwelling and Outbuilding** 

**DA Number:** 

DA 2022 / 00002

**Date Advertised:** 

28 March 2022

**Date Representation Period Closes:** 

11 April 2022

**Responsible Officer:** 

Louisa Brown (Planning Officer)

#### **Viewing Documents:**


The relevant documents may be viewed at Council's website <a href="https://www.centralhighlands.tas.gov.au">www.centralhighlands.tas.gov.au</a> or at Council's Offices 19 Alexander Street, Bothwell & 6 Tarleton Street, Hamilton during normal office hours.

**Representations to:** General Manager

19 Alexander Street BOTHWELL TAS 7030

**Email:** 

development@centralhighlands.tas.gov.au

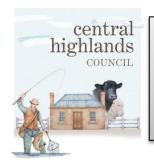

Development & Environmental Services 19 Alexander Street BOTHWELL TAS 7030

Phone: (03) 6259 5503 Fax: (03) 6259 5722

www.central highlands.tas.gov.au

OFFICE USE ONLY	
Application No.:	
Property ID No.:	
Date Received:	

# Application for Planning Approval Use and Development

Use this form to apply for planning approval in accordance with section 57 and 58 of the Land Use Planning and Approvals Act 1993

,						.,
Applicant / Ow	ner Details:					
Applicant Name	Smeekes Drafting	- Marcus Walters				
Postal Address	17 Bayfield Street			Phone No:	6234618	35
	Rosny Park		7018	Fax No:		
Email address	marcus.walters@sr	neekesdrafting.com				
Owner/s Name (if not Applicant)	Nicole Dagmar Ruf	f & David Charles Ad	cheson			
Postal Address	30 Brady Street			Phone No:	0405 61	2 070
	Midway Point		7171	Fax No:		
Email address:	nicole.ruff@skretting	g.com				
Description of	proposed use and/	or development:				
Address of new use and development:	Lot 1 Tunbridge Tie	er Road, Interlaken.	TAS 7030	)		
Certificate of Title No:	Volume No 168930	Lot	No: 1			
Description of proposed use or development:	New Dwelling and	Shed			/ /Shed / F	velling /Additions/ Demolition arm Building / Carport / Pool or detail other etc.
Current use of land and buildings:	Vacant land. No b	uildings			on this t	hat is the main building
Proposed Material	What are the proposed external wall colours	Natural Timber & Colorbond 'Monur	nent'	at is the proposed	roof colour	Colorbond 'Monument
	What is the proposed new floor area m <sup>2</sup> .	DWELLING 127m SHED 94.5m2		at is the estimated he new work prop		\$ 580,000

Is proposed development to be staged:	Yes	Ш	No	М	Tick 🗸
Is the proposed development located on land previously used as a tip site?	Yes		No	$\square$	
Is the place on the Tasmanian Heritage Register?	Yes	$\square$	No		
Have you sought advice from Heritage Tasmania?	Yes		No	$\square$	
Has a Certificate of Exemption been sought for these works?	Yes		No	<b>□</b> ′	
Signed Declaration					

I/we hereby apply for a planning approval to carry out the use or development described in this application and in the accompanying plans and documents, accordingly I declare that:

- 1. The information given is a true and accurate representation of the proposed development. I understand that the information and materials provided with this development application may be made available to the public. I understand that the Council may make such copies of the information and materials as, in its opinion, are necessary to facilitate a thorough consideration of the Development Application. I have obtained the relevant permission of the copyright owner for the communication and reproduction of the plans accompanying the development application, for the purposes of assessment of that application. I indemnify the Central Highlands Council for any claim or action taken against it in respect of breach of copyright in respect of any of the information or material provided.
- 2. In relation to this application, I/we agree to allow Council employees or consultants to enter the site in order to assess the application.
- 3. I am the applicant for the planning permit and I have notified the owner/s of the land in writing of the intention to make this application in accordance with Section 52(1) of the Land Use Planning Approvals Act 1993 (or the land owner has signed this form in the box below in "Land Owner(s) signature); Applies where the applicant is not the Owner and the land is not Crown land or owned by a council, and is not land administered by the Crown or a council.

Applicant Name (Please print)	Date
Marcus Walters	24-12-2021
Land Owners Name (nlease print)	Date
Earld & Wileis Name (please print)	Date
Land Owners Name (please print)	Date
	Marcus Walters  Land Owners Name (please print)

#### Information & Checklist sheet 1. A completed Application for Planning Approval – Use and Development form. Please ensure that the information provides an accurate description of the proposal, has the correct address and contact details and is signed and dated by the applicant. A current copy of the Certificate of Title for all lots involved in the proposal. The title details must include, where available, a copy of the search page, title plan, sealed plan or diagram and any schedule of easements (if any), or other restrictions, including covenants, Council notification or conditions of transfer. 3. Two (2) copies of the following information -An analysis of the site and surrounding area setting out accurate descriptions of the following topography and major site features including an indication of the type and extent of native vegetation present, natural drainage lines, water courses and wetlands, trees greater than 5 metres in height in areas of skyline or landscape importance and identification of any natural hazards including flood prone areas, high fire risk areas and land subject to instability; (ii) soil conditions (depth, description of type, land capability etc); (iii) the location and capacity of any existing services or easements on the site or connected to the site; (iv) existing pedestrian and vehicle access to the site; (v) any existing buildings on the site; (vi) adjoining properties and their uses; and soil and water management plans. (vii) b) A site plan for the proposed use or development drawn, unless otherwise approved, at a scale of not less than 1:200 or 1:1000 for sites in excess of 1 hectare, showing -(i) a north point; the boundaries and dimensions of the site; (ii) (iii) Australian Height Datum (AHD) levels; (iv) natural drainage lines, watercourses and wetlands; (v) soil depth and type; (vi) the location and capacity of any existing services or easements on the site or connected to the (vii) the location of any existing buildings on the site, indicating those to be retained or demolished, and their relationship to buildings on adjacent sites, streets and access ways; (viii) the use of adjoining properties; shadow diagrams of the proposed buildings where development has the potential to cause overshadowing; (x) the dimensions, layout and surfacing materials of all access roads, turning areas, parking areas and footpaths within and at the site entrance; any proposed private or public open space or communal space or facilities; proposed landscaping, indicating vegetation to be removed or retained and species and mature heights of plantings; and (xiii) methods of minimizing erosion and run-off during and after construction and preventing contamination of storm water discharged from the site. c) Plans and elevations of proposed and existing buildings, drawn at a scale of not less than 1:100, showing internal layout and materials to be used on external walls and roofs and the relationship of the elevations to natural ground level, including any proposed cut or fill. A written submission supporting the application that demonstrates compliance with the relevant parts of the Act, State Polices and the Central Highlands Interim Planning Scheme 2015, including for industrial and commercial uses, the hours of operation, number of employees, details of any point source discharges or emissions, traffic volumes generated by the use and a Traffic Impact Statement where the development is likely to create more than 100 vehicle movements per day. Prescribed fees payable to Council. An invoice for the fees payable will be issued once application has

been received.

Information	
If you provide an email address in this form then the Central Highlands Council ("the Council") will treat the provision of the email address as consent to the Council, pursuant to Section 6 of the Electronic Transactions Act 2000, to using that email address for the purposes of assessing the Application under the Land Use Planning and Approvals Act 1993 ("the Act").	
If you provide an email address, the Council will not provide hard copy documentation unless specifically requested.	
It is your responsibility to provide the Council with the correct email address and to check your email for communications from the Council.	
If you do not wish for the Council to use your email address as the method of contact and for the giving of information, please tick ✓ the box	
Heritage Tasmania	
If the Property is listed on the Tasmanian Heritage Register then the Application will be referred to Heritage Tasmania unless an Exemption Certificate has been provided with this Application.  (Phone 1300 850 332 or email enquires@heritage.tas.gov.au)	
TasWater	
Depending on the works proposed Council may be required to refer the Application to TasWater for assessment (Phone 136992)	



# Department of Natural Resources and Environment Tasmania



GPO Box 1751, Hobart, TAS 7001 Australia Ph (03) 6165 4678 www.parks.tas.gov.au

File Reference: 22/1050

Dear Nicole and David,

#### Access licence - 1910 Tunbridge Tier Road Interlaken - Approved

I am pleased to inform you, your application for an access licence to 1910 Tunbridge Tier Road, Interlaken has been approved by the Manager of Property Services on 8 March 2022.

The assessment of the application indicated there is Aboriginal heritage present within the reserved road and surrounding areas. Should you wish to upgrade the road you will need to contact Aboriginal Heritage Tasmania for advice.

#### The next steps are:

- · Crown Law will post the invoice and the agreement to you for signing.
- Once the documents are signed, they are returned to Crown Law and then I can finalise the agreement.

#### Once finalised the access licence allows for:

• Construction or maintenance along the reserved road corridor to a standard that allows for access to the private property.

If you wish to upgrade or widen the existing track, only a minimal amount of vegetation should be removed and you should check with council whether they have any requirements, including as to whether there are any threatened species present.

Should you have any further queries about this matter, please contact me on 6165 4678 or alexandra.ford@nre.tas.gov.au

Yours sincerely Alex Ford

Acting Senior Crown Land Officer Property Services
Parks and Wildlife Service



## Department of Natural Resources and Environment Tasmania



GPO Box 1751, Hobart, TAS 7001 Australia
Ph 1300 TAS PARKS / 1300 827 727 Fax 03) 6223 8308
www.parks.tas.gov.au

Enquiries: Gerry Murrell Phone: (03) 6165 3065

Email: propertyservices@parks.tas.gov.au

Our ref: 22/1274

18 February 2022

Smeekes Drafting Attn: Marcus Walters 17 Bayfield Street ROSNY PARK TAS 7018

E: marcus.walters@smeekesdrafting.com nicoledruff@gmail.com

Dear Mr Walters,

#### LODGEMENT OF PLANNING APPLICATION NICOLE RUFF AND DAVID ACHESON NEW DWELLING AND SHED LOT 1, TUNBRIDGE ROAD, INTERLAKEN

This letter, issued pursuant to section 52(1B) of the *Land Use Planning and Approvals Act 1993* (LUPAA) is to confirm that the Crown consents to the making of the enclosed Planning Permit Application, insofar as the proposed development relates to Crown land managed by the Department Natural Resources and Environment Tasmania.

Crown consent is only given to the lodgement of this application. Any variation will require further consent from the Crown.

This letter does not constitute, nor imply, any approval to undertake works, or that any other approvals required under the *Crown Lands Act 1976* have been granted. If planning approval is given for the proposed development, the applicant will be required to obtain separate and distinct consent from the Crown before commencing any works on Crown land.

If you need more information regarding the above, please contact the officer nominated at the head of this correspondence.

Yours sincerely,

Tanya Simm **Acting Team Leader (Assessments)** 

# Notice of Termination of Authority and Instrument of Delegation

## DELEGATION OF THE DIRECTOR-GENERAL OF LANDS' FUNCTIONS UNDER THE LAND USE PLANNING AND APPROVALS ACT 1993

I, TIMOTHY WILLIAM BAKER, being and as the Director-General of Lands appointed under section 7 of the *Crown Lands Act 1976* ("the Act"), acting pursuant to section 23AA(5A) of the *Acts Interpretation Act*, hereby give notice that the authority of the holders of the offices of Deputy Secretary (Parks & Wildlife Service) (position number 700451), Manager - Crown Land Services (position number 707556), Team Leader - Crown Land Services (Unit Manager, Leases & Licences) (position number 340697) and Team Leader - Crown Land Services (Unit Manager, Policy & Projects) (position number 334958) to perform the functions conferred on the Director-General of Lands, as delegated on 20 December 2020 by Deidre Wilson, then Acting Director-General of Lands, is terminated with immediate effect.

Further, acting pursuant to section 52(1E) of the Land Use Planning and Approvals Act 1993 ("the Act"), I hereby delegate the functions described (by reference to the relevant provision of the Act and generally) in Schedule I, to the persons respectively holding the offices of Deputy Secretary (Parks & Wildlife Service) (position number 700451), General Manager (Park Operations and Business Services) (position number 708581), Director (Operations) (position number 708050), Manager (Property Services) (position number 707556), Unit Manager (Operations) (position number 702124), and Team Leader (Assessments) (position number 334958) in accordance with the functions delegated to me by the Minister for Parks, being and as the Minister administering the Crown Lands Act 1976, by instrument dated 30 November 2021.


#### SCHEDULE I

Provision	Description of Functions
Section	Signing, and providing written permission for, applications for
52(IB)	permits in relation to Crown land.

Dated at HOBART this 7th day of December 2021

Tim Baker

**DIRECTOR-GENERAL OF LANDS** 

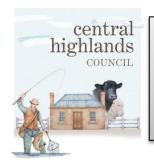

Development & Environmental Services 19 Alexander Street BOTHWELL TAS 7030

Phone: (03) 6259 5503 Fax: (03) 6259 5722

www.central highlands.tas.gov.au

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Applicant Name	Smeekes Drafting	- Marcus Walters				
Postal Address	17 Bayfield Street			Phone No:	6234618	35
	Rosny Park		7018	Fax No:		
Email address	marcus.walters@sr	neekesdrafting.com				
Owner/s Name (if not Applicant)	Nicole Dagmar Ruf	f & David Charles Ad	cheson			
Postal Address	30 Brady Street			Phone No:	0405 61	2 070
	Midway Point		7171	Fax No:		
Email address:	nicole.ruff@skretting	g.com				
Description of	proposed use and/	or development:				
Address of new use and development:	Lot 1 Tunbridge Tie	er Road, Interlaken.	TAS 7030	)		
Certificate of Title No:	Volume No 168930	Lot	No: 1			
Description of proposed use or development:	New Dwelling and	Shed			/ /Shed / F	velling /Additions/ Demolition arm Building / Carport / Pool or detail other etc.
Current use of land and buildings:	Vacant land. No b	uildings			on this t	hat is the main building
Proposed Material	What are the proposed external wall colours	Natural Timber & Colorbond 'Monur	nent'	at is the proposed	roof colour	Colorbond 'Monument
	What is the proposed new floor area m <sup>2</sup> .	DWELLING 127m SHED 94.5m2		at is the estimated he new work prop		\$ 580,000

Is proposed development to be staged:	Yes	ш	No	М	Tick 🗸
Is the proposed development located on land previously used as a tip site?	Yes		No	$\square$	
Is the place on the Tasmanian Heritage Register?	Yes	$\square$	No		
Have you sought advice from Heritage Tasmania?	Yes		No	$\square$	
Has a Certificate of Exemption been sought for these works?	Yes		No	<b>□</b> ′	
Signed Declaration					

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- 2. In relation to this application, I/we agree to allow Council employees or consultants to enter the site in order to assess the application.
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Applicant Signature	Applicant Name (Please print)	Date
mPW alters	Marcus Walters	24-12-2021
(if not the Owner)		
Land Owner(s) Delegated Officer Signature	Land Owners Delegated OfficerName (please print)	Date
	Jesse Walker The Crown In Right of Tasmania	17/03/2022
Xvln		
Land Owner(s) Signature	Land Owners Name (please print)	Date

#### Information & Checklist sheet 1. A completed Application for Planning Approval – Use and Development form. Please ensure that the information provides an accurate description of the proposal, has the correct address and contact details and is signed and dated by the applicant. A current copy of the Certificate of Title for all lots involved in the proposal. The title details must include, where available, a copy of the search page, title plan, sealed plan or diagram and any schedule of easements (if any), or other restrictions, including covenants, Council notification or conditions of transfer. 3. Two (2) copies of the following information -An analysis of the site and surrounding area setting out accurate descriptions of the following topography and major site features including an indication of the type and extent of native vegetation present, natural drainage lines, water courses and wetlands, trees greater than 5 metres in height in areas of skyline or landscape importance and identification of any natural hazards including flood prone areas, high fire risk areas and land subject to instability; (ii) soil conditions (depth, description of type, land capability etc); (iii) the location and capacity of any existing services or easements on the site or connected to the site; (iv) existing pedestrian and vehicle access to the site; (v) any existing buildings on the site; (vi) adjoining properties and their uses; and soil and water management plans. (vii) b) A site plan for the proposed use or development drawn, unless otherwise approved, at a scale of not less than 1:200 or 1:1000 for sites in excess of 1 hectare, showing -(i) a north point; the boundaries and dimensions of the site; (ii) (iii) Australian Height Datum (AHD) levels; (iv) natural drainage lines, watercourses and wetlands; (v) soil depth and type; (vi) the location and capacity of any existing services or easements on the site or connected to the (vii) the location of any existing buildings on the site, indicating those to be retained or demolished, and their relationship to buildings on adjacent sites, streets and access ways; (viii) the use of adjoining properties; shadow diagrams of the proposed buildings where development has the potential to cause overshadowing; (x) the dimensions, layout and surfacing materials of all access roads, turning areas, parking areas and footpaths within and at the site entrance; any proposed private or public open space or communal space or facilities; proposed landscaping, indicating vegetation to be removed or retained and species and mature heights of plantings; and (xiii) methods of minimizing erosion and run-off during and after construction and preventing contamination of storm water discharged from the site. c) Plans and elevations of proposed and existing buildings, drawn at a scale of not less than 1:100, showing internal layout and materials to be used on external walls and roofs and the relationship of the elevations to natural ground level, including any proposed cut or fill. A written submission supporting the application that demonstrates compliance with the relevant parts of the Act, State Polices and the Central Highlands Interim Planning Scheme 2015, including for industrial and commercial uses, the hours of operation, number of employees, details of any point source discharges or emissions, traffic volumes generated by the use and a Traffic Impact Statement where the development is likely to create more than 100 vehicle movements per day. Prescribed fees payable to Council. An invoice for the fees payable will be issued once application has

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If you provide an email address, the Council will not provide hard copy documentation unless specifically requested.	
It is your responsibility to provide the Council with the correct email address and to check your email for communications from the Council.	
If you do not wish for the Council to use your email address as the method of contact and for the giving of information, please tick ✓ the box	
Heritage Tasmania	
If the Property is listed on the Tasmanian Heritage Register then the Application will be referred to Heritage Tasmania unless an Exemption Certificate has been provided with this Application.  (Phone 1300 850 332 or email enquires@heritage.tas.gov.au)	
TasWater	
Depending on the works proposed Council may be required to refer the Application to TasWater for assessment (Phone 136992)	

Trim Reference: 62552

Permit #: 2172

21 July 2021

# Forest Activity Permit

Subject to signing Schedule 1, this permit grants access to Permanent Timber Production Zone land on the following terms and conditions:

#### **General Conditions**

- This permit is valid from 02/08/2021 to 02/08/2024;
- This permit allows for the Access Licence at locations specified in Schedule 2 of this permit ('Permit Locations');
- The person/s approved to undertake the activity which is the subject of this permit, are set out at Schedule 1 of this permit ('Permit Holders');
- The Permit Holders acknowledge and agree that their access and use of Permanent Timber Production Zone land is at their own risk, and they indemnify Sustainable Timber Tasmania from any liability for injury or damage arising out of their access and use of Permanent Timber Production Zone land under this permit;
- The Permit Holders must abide by any other direction, policy or guideline given to them by Sustainable Timber Tasmania relating to their access and use of Permanent Timber Production Zone land, including without limitation, those relating safety, fire prevention, and emergency procedures;
- Vehicle use is restricted to formed roads and tracks;
- Sustainable Timber Tasmania may revoke this permit at its discretion at any time upon notice to the Permit Holders;
- This permit does not authorise permission to enter private property;
- The Permit Holders must not approach, interfere or cause a nuisance to any active forest operation or other users of Permanent Timber Production Zone land, or collect within 1km of active operations;
- It is the responsibility of the Permit Holder to be aware of any fire hazards including wildfires
  and planned burns within the vicinity of the Permit Location(s). Wildfire information can be
  checked on the Tasmanian Fire Service website (<a href="www.fire.tas.gov.au">www.fire.tas.gov.au</a>). Information pertaining
  to planned burns can be checked on the Sustainable Timber Tasmania website
  (<a href="www.sttas.com.au/planned-burns">www.sttas.com.au/planned-burns</a>);
- Permit Holders must be aware of eagle activity. Eagles displaying stress, such as being vocal (screeching) or flushing from the nest should be reported to Sustainable Timber Tasmania and all activity within 500 m of the nest ceased immediately;

- The Permit Holders must abide by the guidelines outlined in Unsupervised visitor safety and environment information;
- The Permit Holders should carry a copy of this letter while on Permanent Timber Production Zone land and produce it to a Forest Officer if requested.

#### **Specific Conditions**

- An Access Licence must be issued to obtain right of way over PTPZL
- If access is required over private property, it is up to the permit holder to negotiate this with the private landowner
- The permit holder must provide a copy of the FPP plan of the proposed new track section from 519150E,5338770N to 519140,5338620N to the Land Manager Regional Officer
- The FPP must be signed off by STT Forest Operations Manager (North East) as Landowner
- A gate can be erected ( at the permit holder's expense) only at the boundary between PTPZL and Nicole Ruff property.
- The permit holder will not interfere with STT use of the road
- The permit holder is responsible of maintaining the road unless is damaged by STT carting operations
- Annual fees for this access are \$250 + GST per annum payable to STT
- Access Licence application fee is \$267.30 + GST payable to STT
- Forest Activity Assessment fee is \$750 + GST payable to STT
- A document preparation fee is \$200+GST

e text here

The Road Access covers from 519140E,5338620N to 519665E,5338282N

To signify your agreement to the terms of this permit, please sign Schedule 1 where indicated alongside your name. By doing so you agree to be legally bound by the terms and conditions of this permit set out above. Please note that costs of up to \$1500, sometimes more, are incurred in preparing a Forest Activity Assessment. This cost is recovered from commercial businesses, but in the case of non-profit groups the fee is waived with the understanding that Sustainable Timber Tasmania is given sponsor-status in any communications and publicity about your activity.

Should you have any questions regarding this permit, or wish to discuss changes to the permit, please contact Ariana laconis Ariana.iaconis@sttas.com.au or 0427 398 198

Stephen Rymer

Forest Manager (North)

### **SCHEDULE 1 Permit Holders**

The person/s which are authorised by this permit are set out below. Please sign next to your name to show your acceptance of the terms and conditions of this permit.

	FULL NAME	ADDRESS	SIGNATURE	DATE
1.	Nicole Ruff	30 Brady Street, Midway Point, Tasmania 7171	W-Ruff	09 August 2021
2.	David Acheson	30 Brady Street, Midway Point, Tasmania 7171	D. Achanes	09 August 2021
3.				
4.				

## SCHEDULE 2 Permit Location(s)

The locations authorised by this permit are defined below:


	LOCATION
1.	519140E;5338620N to 519665E;5338282N
2.	
3.	
4.	



### **CERTIFICATE OF TITLE**


LAND TITLES ACT 1980



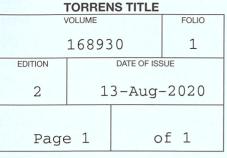

I certify that the person described in Schedule 1 is the registered proprietor of an estate in fee simple (or such other estate or interest as is set forth in that Schedule) in the land within described subject to such exceptions, encumbrances, interests and entries specified in Schedule 2 and to any additional entries in the Folio of the Register.



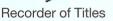



#### DESCRIPTION OF LAND

Parish of ANSTEY Land District of SOMERSET Lot 1 on Plan 168930 Derivation: Whole of 470A-OR-OP, (1000A-OA-OP) and Lot 1503 (640A-OR-OP) Granted George Carr Clarke, Whole of (1000A-0R-0P) and Part of (840A-0R-0P) Granted to John Franks Prior CT 149692/1

#### SCHEDULE 1

TRANSFER to NICOLE DAGMAR RUFF and DAVID CHARLES M834230 Registered 13-Aug-2020 at noon ACHESON


#### SCHEDULE 2

Reservations and conditions in the Crown Grant if any



### **RESULT OF SEARCH**

RECORDER OF TITLES

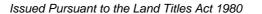



#### SEARCH OF TORRENS TITLE

VOLUME 168930	FOLIO 1
EDITION 1	DATE OF ISSUE 07-Jan-2015

SEARCH DATE: 07-Jul-2020 SEARCH TIME: 04.56 PM

#### DESCRIPTION OF LAND

Parish of ANSTEY Land District of SOMERSET

Lot 1 on Plan 168930

Derivation: Whole of 470A-0R-0P, (1000A-0A-0P) and Lot 1503 (640A-OR-OP) Granted George Carr Clarke, Whole of (1000A-0R-0P) and Part of (840A-0R-0P) Granted to John Franks Prior CT 149692/1

#### SCHEDULE 1

D126255 & D144171 P P WOODLAND COMPANY PTY LTD Registered 07-Jan-2015 at noon

#### SCHEDULE 2

Reservations and conditions in the Crown Grant if any

D120616 PRIVATE TIMBER RESERVE pursuant to Section 15(1) of the Forest Practices Act 1985 (affecting part of the said land within described as shown hatched on the plan annexed therto Registered 13-Oct-2015 at noon

#### UNREGISTERED DEALINGS AND NOTATIONS

No unregistered dealings or other notations



FOLIO REFERENCE CT 149692/1

OWNER

### **FOLIO PLAN**

RECORDER OF TITLES



Issued Pursuant to the Land Titles Act 1980

PLAN OF TITLE

LOCATION

SOMERSET-ANSTEY

P.168930

CONVERTED BY PLAN No. 2/908 LO 2/596 LO

APPROVED 15 DEC 2014

GRANTEE WHOLE OF (470A OR OP), (1000A OR OP) AND LOT 1503 (640A OR OP) GTD. TO GEORGE CARR CLARKE WHOLE OF (1000A OR OP) AND PART OF (840A OR OP) GTD. TO JOHN FRANKS. APPROVED 15 DEC 2014 COMPILED BY LTO Alice Kawa NOT TO SCALE LENGTHS IN METRES Recorder of Titles ALL EXISTING SURVEY NUMBERS TO BE CROSS REFERENCED ON THIS PLAN MAPSHEET MUNICIPAL CODE No. 105 (5033) LAST PLAN No. PI49692 SKETCH BY WAY OF ILLUSTRATION ONLY "EXCEPTED LANDS" P.5493 LO. NOTN 55/6324, 3:128ha LOT I. P·123332, I·417ha LOT 2. P.123332, 194m<sup>2</sup> SHETCH 'A' 100.58 -2.(PI23332) /ROAD (P5493 L0) -I.PI23332) 406-36 LOTI 190·2ha (P223034) 2935.04 3371.58 1161.54 LOT 2 404·7ha 3480·21 2200·78 LAKE LOT 3 259.0ha SORELL 2140.43 2019.73 LOT 4 404·7ha ROAD (P229190) 804-67 (PI25866) 1528.88 TUNBRIDGE TIER (PI33755) 108.58 LOT 5 SEE SKETCH 336.4ha
(NOT INC. HATCHED PORTIONS) INTERLAKEN 1025.96 ROAD 1860-80 (D52866) 105/684) LAKE CRESCENT  $\mathsf{MG}$ 

Search Date: 07 Jul 2020 Search Time: 04:56 PM Volume Number: 168930 Revision Number: 01 Page 1 of 1

## TASMANIAN LAND TITLES OFFICE

### Blank Instrument Form





Land Titles Act 1980

	DESCRIPTIO	N OF LAND	
	Folio of th	e Register	
Volume	Folio	Volume	Folio
169020	4	1/hath a	· .
168930	1	\$6893 <i>0</i> 7	₹.
168930	2	<b>¥6893.0,</b> 16970 <sup>5</sup> 7	
168930	3	107 10 1	)
168930	. 4		

	168930 168930	3 4		,	
1.		of the land as shown hat ne abovementioned Folio		annexed here	to and comprised
2.	Name of Registered	<u>Proprietor</u> :	PP WOODLANI	D COMPANY	Y PTY LTD
3.	Date and page of gaz	zette notice (attached): da	ated 30 <sup>th</sup> Septemb	per, 2015, Pag	ee 1422
4.	This is a notification Practices Act 1985.	of a Private Timber Res	erve, made pursu	ant to Section	15 (1) of the Forest
Dated	this	day o	f	201	5
Signe	d on behalf of Private	Forests )	C	$\int \Omega \int d\Omega$	

Signed on behalf of Private Forests )
Tasmania in the presence: )

(Officer)

Land Titles OffiSelUse Only

1 3 OCT 2015


Version 1

R OF TITLES
THE BACK OF THIS FORM MUST NOT BE USED

Stamp Duty

Part title description

Label	PTR Internal Angle (degrees)	Distance (metres)
A to Point 1 A to Point 6 Point 1 to Point 2 Point 2 to Point 3 Point 4 to Point 5 A to Point 4	199	1152 1574 770 To title boundary 570 2 617

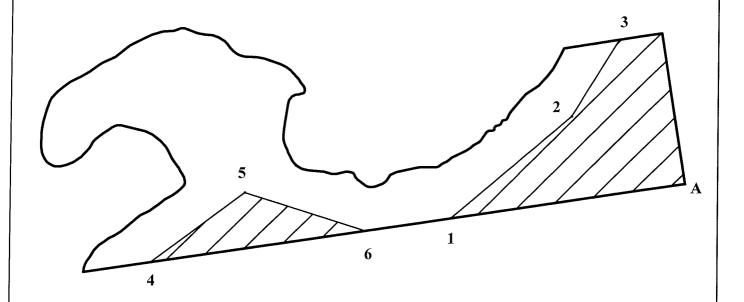

N Scale 1:17 500 Approximate

Title Reference Volume 168930 Folio 1

Title area depicted by thick black line. PTR area hatched only.

The Private Timber Reserve does not include roads and railways excluded from the title.

This diagram was prepared by Rob Smith an Officer with Private Forests Tasmania (PFT), for the purposes of the Forest Practices Act 1985 to depict a Private Timber Reserve.


Signature of PFT Officer

Date 23-3-15.

THE BACK OF THIS PAGE MUST NOT BE USED

Part title description

Label	PTR Internal Angle (degrees)	Distance (metres)
A to Point 1	Along title boundary	3121
B to Point 2	Along title boundary	3277
Point 2 to Point 3	95	584

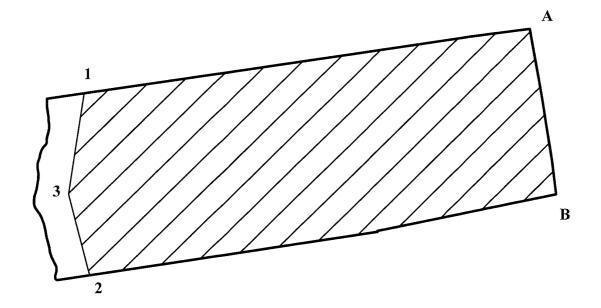



Title Reference Volume 168930 Folio 2


Title area depicted by thick black line. PTR area hatched only.
The Private Timber Reserve does not include roads and railways excluded from the title.

This diagram was prepared by Rob Smith an Officer with Private Forests Tasmania (PFT), for the purposes of the Forest Practices Act 1985 to depict a Private Timber Reserve.

Signature of PFT Officer

Part title description

Label	PTR Internal Angle (degrees)	Distance (metres)
A to Point 1 B to Point 5 Point 1 to Point 2 Point 2 to Point 3 Point 3 to Point 4 Point 5 to Point 4 Point 6 to Point 7 Point 7 to Point 8 Point 8 to Point 9	Along title boundary Along title boundary 76 190 151 114 220 215	82 1995 411 160 To title boundary 314 313 378 To title boundary

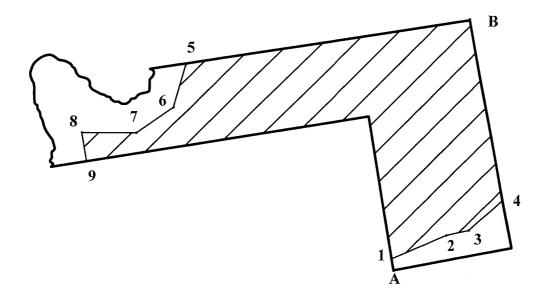



Title Reference Volume 168930 Folio 3

Title area depicted by thick black line. PTR area hatched only.

The Private Timber Reserve does not include roads and railways excluded from the title.


This diagram was prepared by Rob Smith an Officer with Private Forests Tasmania (PFT), for the purposes of the Forest Practices Act 1985 to depict a Private Timber Reserve.

**Signature of PFT Officer** 

THE BACK OF THIS PAGE MUST NOT BE USED

Part title description

Label	PTR Internal Angle (degrees)	Distance (metres)
A to Point 1 B to Point 4 Point 1 to Point 2 Point 2 to Point 3 Point 4 to Point 5 Point 5 to Point 6	194 120	1450 1998 705 To title boundary 763 To title boundary

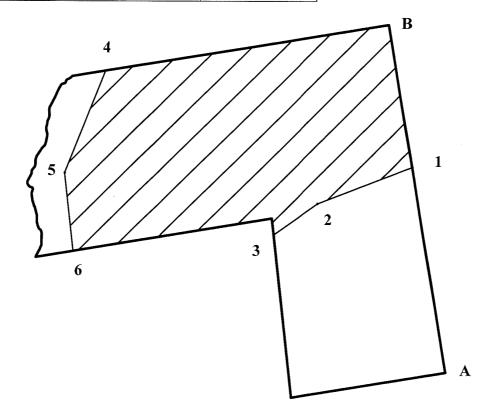



Title Reference Volume 168930 Folio 4

Title area depicted by thick black line. PTR area hatched only.

The Private Timber Reserve does not include roads and railways excluded from the title.

This diagram was prepared by Rob Smith an Officer with Private Forests Tasmania (PFT), for the purposes of the Forest Practices Act 1985 to depict a Private Timber Reserve.


Signature of PFT Officer

Date 23-3-15

169707/5

Part title description

Label	PTR Internal Angle (degrees)	Distance (metres)
A to Point 1	Along title boundary	94
Point 1 to Point 2		560
Point 2 to Point 3		336
Point 3 to Point 4		696
Point 4 to Point 5	49	To title boundary

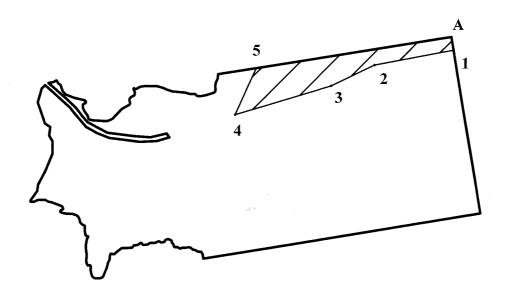

Scale 1:25 000 Approximate

169707

Title Reference Volume 168930/Folio 5

Title area depicted by thick black line. PTR area hatched only.

The Private Timber Reserve does not include roads and railways excluded from the title.

This diagram was prepared by Rob Smith an Officer with Private Forests Tasmania (PFT), for the purposes of the Forest Practices Act 1985 to depict a Private Timber Reserve.

Signature of PFT Officer \_

Date 27-3-15

THE BACK OF THIS PAGE MUST NOT BE USED

#### PIN OR STAPLE HERE DO NOT GUM THIS FORM TO THE INSTRUMENT

#### ANNEXURE PAGE

PAGE ....6 ..... OF ....... PAGES Vol. 1689.30 ... Fol. ....

1422 TASMANIAN GOVERNMENT GAZETTE 30 SEPTEMBER 2015

Forest Practices

Forest Practices Authority 24th August, 2015

#### FOREST PRACTICES ACT 1985

#### NOTIFICATION

IN ACCORDANCE with the provision of Section 11 of the Forest Practices Act 1985, and on the recommendation of the Forest Practices Authority, Her Excellency, the Governor-in-Council has declared part of each of the lands listed in the following schedule to be Private Timber Reserves.

#### SCHEDULE

#### PRIVATE TIMBER RESERVE

#### PART TITLE

Application No.	Owner	Land Title Reference	Location	Municipal Area
2212	Flowers, CR	C/T Vol 238259 Fol 1 C/T Vol 238260 Fol 1	Mayberry	Meander Valley Council
2210	PP Woodland Company Pty Ltd	C/T Vol 168930 Fol 1 C/T Vol 168930 Fol 2 C/T Vol 168930 Fol 3 C/T Vol 168930 Fol 4 C/T Vol 168930 Fol 5	Interlaken	Central Highlands Council

Given under my hand at Hobart in Tasmania on 24th August, 2015.

By Her Excellency's Command

C. WARNER, Governor.

PAUL HARRISS, Minister for Resources.

Forest Practices Authority 24th August, 2015

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#### NOTIFICATION

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#### SCHEDULE

#### PRIVATE TIMBER RESERVE

#### WHOLE TITLE

Application No.	Owner	Land Title Reference	Location	Municipal Area
2211	PP Woodland Company Pty Ltd	C/T Vol 241819 Fol 1	Arthurs Lake	Central Highlands Council

Given under my hand at Hobart in Tasmania on 24th August, 2015.

By Her Excellency's Command

C. WARNER, Governor.

PAUL HARRISS, Minister for Resources.

**NOTE:-** Every annexed page shall be signed by the parties to the dealing, or where the party is a corporate body, be signed by the persons who have attested the affixing of the seal of that body to the dealing.

Version 1

# PIN OR STAPLE HERE DO NOT GUM THIS FORM TO THE INSTRUMENT

#### **ANNEXURE PAGE**

PAGE 7 OF 7 PAGES Vol. 16.89.30 Fol. 1

1422 TASMANIAN GOVERNMENT GAZETTE 30 SEPTEMBER 2015

Forest Practices

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#### PRIVATE TIMBER RESERVE

#### PART TITLE

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2212	Flowers, CR	C/T Vol 238259 Fol 1 C/T Vol 238260 Fol 1	Мауветту	Meander Valley Council
2210	PP Woodland Company Pty Ltd	C/T Vol 168930 Fol 1 C/T Vol 168930 Fol 2 C/T Vol 168930 Fol 3 C/T Vol 168930 Fol 4 C/T Vol 168930 Fol 5	Interlaken	Central Highlands Council

169707

Given under my hand at Hobart in Tasmania on 24th August, 2015.

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PAUL HARRISS, Minister for Resources.

Forest Practices Authority 24th August, 2015

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Version 1

#### **GENERAL NOTES:**

- . THESE DRAWINGS ARE TO BE READ IN CONJUNCTION WITH SMEEKES DRAFTING PTY LTD STANDARD BUILDING NOTES, SHEETS STANDARD-001 TO 014
- 2. WRITTEN DIMENSIONS TO TAKE PRECEDENCE OVER SCALE.
- BUILDER TO VERIFY ALL BOUNDARY CLEARANCES AND SITE SET- 8.
   OUT DIMENSIONS PRIOR TO COMMENCEMENT
   OF CONSTRUCTION.
- ALL CONSTRUCTION WORK SHALL BE UNDERTAKEN IN ACCORDANCE WITH THE BUILDING CODE OF AUSTRALIA AND RELEVANT AUSTRALIAN STANDARDS.
- . TIMBER FRAMING SHALL BE IN ACCORDANCE WITH THE
  REQUIREMENTS OF AS 1684.2 "TIMBER FRAMED CONSTRUCTION". 10.
  T.P. DECK SHALL BE CONSTRUCTED IN ACCORDANCE WITH THE
  REQUIREMENTS OF THE PUBLICATION FROM THE TIMBER
  PROMOTION COUNCIL "TIMBER DECKS DESIGN AND
  CONSTRUCTION MANUAL"
- . FOOTINGS AND SLABS SHALL BE IN ACCORDANCE WITH THE REQUIREMENTS OF AS 2870 "RESIDENTIAL SLABS AND FOOTINGS"

- 7. PLUMBING AND DRAINAGE SHALL BE IN ACCORDANCE WITH AS 3500.2 AND AS 3500.3 "THE NATIONAL PLUMBING AND DRAINAGE CODE". FIT ADJUSTABLE TEMPERING VALVES TO ALL ABLUTIONS IN ACCORDANCE WITH AS 1529 "CODE OF PRACTICE OF HOUSEHOLD TYPE HOT WATER SUPPLY SYSTEMS".
- WATER PROOFING OF WET AREAS SHALL BE IN ACCORDANCE WITH THE REQUIREMENTS OF AS 3740 "WATERPROOFING OF WET AREAS IN RESIDENTIAL BUILDINGS".
- ELECTRICAL INSTALLATION SHALL BE IN ACCORDANCE WITH THE REQUIREMENTS OF ASINZS 3000 "WIRING RULES". SMOKE ALARMS SHALL BE INSTALLED IN ACCORDANCE WITH TASMANIAN FIRE SERVICE AND AS 3786 "SMOKE ALARMS".
- GLAZING SHALL BE IN ACCORDANCE WITH AS 1288 "GLASS IN BUILDINGS - SELECTION AND INSTALLATION", WINDOWS TO COMPLY WITH AS 2047 "WINDOWS IN BUILDINGS -SELECTION AND INSTALLATION".
- MIN. R5.1 INSULATION TO CEILING. MIN. R2.5 INSULATION TO ALL EXTERNAL WALLS.

REFERENCE

RUFF-001

RUFF-002

RUFF-003

RUFF-004

RUFF-005

RUFF-006

PROPOSED ORTHOGRAPHIC VIEWS

2

 ALL STEELWORK SHALL BE IN ACCORDANCE WITH AS 4100 "STEEL STRUCTURES".

DOGS HEAD

#### SITE DATA:

LAND TITLE REF. No. : LOT 1 ON SEALED PLAN 168930

CLIMATE ZONE : ZONE 8
DESIGN WIND SPEED : 'N3'
SOIL CLASSIFICATION : CLASS 'M'
BAL RATING : BAL-12.5

BUSHFIRE HAZARD SITE ASSESSMENT COMPLETED BY MARCUS WALTERS (BFP-155) FOR PREPARATION OF BHMP REPORT FOR BUILDING BUILDING APPROVAL




500 m

SCALE

. 10000

NOTE: ALL DIMENSIONS IN MILLIMETRES UNLESS OTHERWISE NOTED

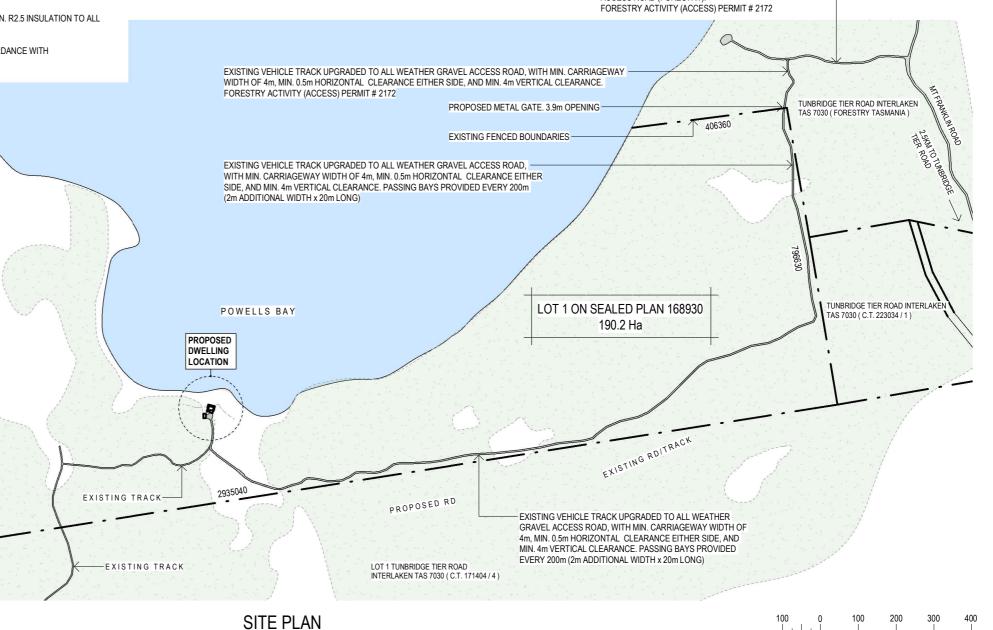

EXISTING VEHICLE ALL WEATHER GRAVEL

SCALE 1:10000

**RUFF** 

NICOLE RUFF

PROPOSED DWELLING

LOT 1 TUNBRIDGE TIER ROAD, INTERLAKEN, TAS. 7030

SITE PLAN

ACCESS ROAD (FORESTRY).

PROPOSED ELEVATIONS 2 OF 2 RUFF-008

SITE PLAN

PROPOSED PART SITE PLAN

SOIL & WATER MANAGEMENT PLAN

VEGETATION MANAGEMENT PLAN

PROPOSED GROUND FLOOR PLAN

PROPOSED ELEVATIONS 1 OF 2

PROPOSED MEZZANINE FLOOR PLAN

DESCRIPTION

ISSUED FOR COUNCIL FOR PLANNING APPROVAL, 24-12-2021

ISSUED FOR CLIENT FOR REVIEW. 23-12-2021

MEAGHERS BAY

SMEEKES DRAFTING PTY LTD

Building Designer Licence Nos. 723026951, 861284073 & CC6621

Office Phone: (03) 6234 6185

Email: admin@smeekesdrafting.com

Website: www.smeekesdrafting.com

17 Bayfield Street, Rosny Park, TAS 7018

SCALE 1: 10000 @ A3

M. WALTERS

.. RAGUS

M WAITERS

**BUILDING DESIGNERS** 


ASSOCIATION OF AUSTRALIA

ESIGNED

HECKED

RAWN

RUFF-009

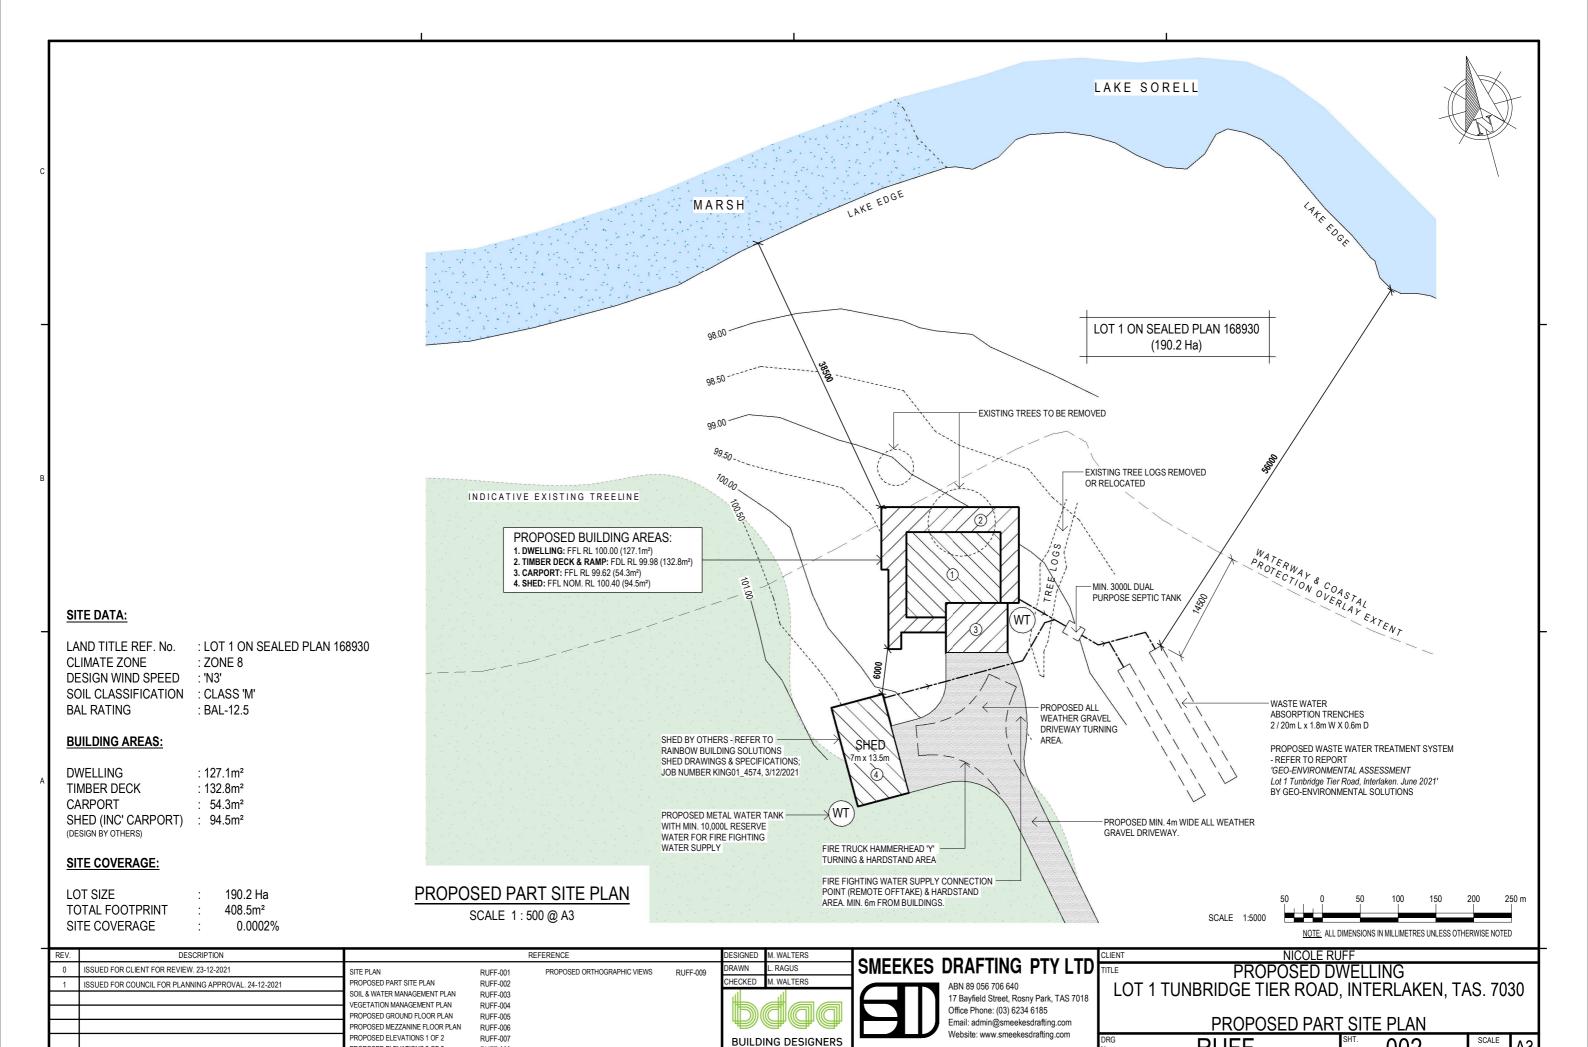


ASSOCIATION OF AUSTRALIA

Building Designer Licence Nos. 723026951, 861284073 & CC6621

1:500

2

PROPOSED ELEVATIONS 2 OF 2

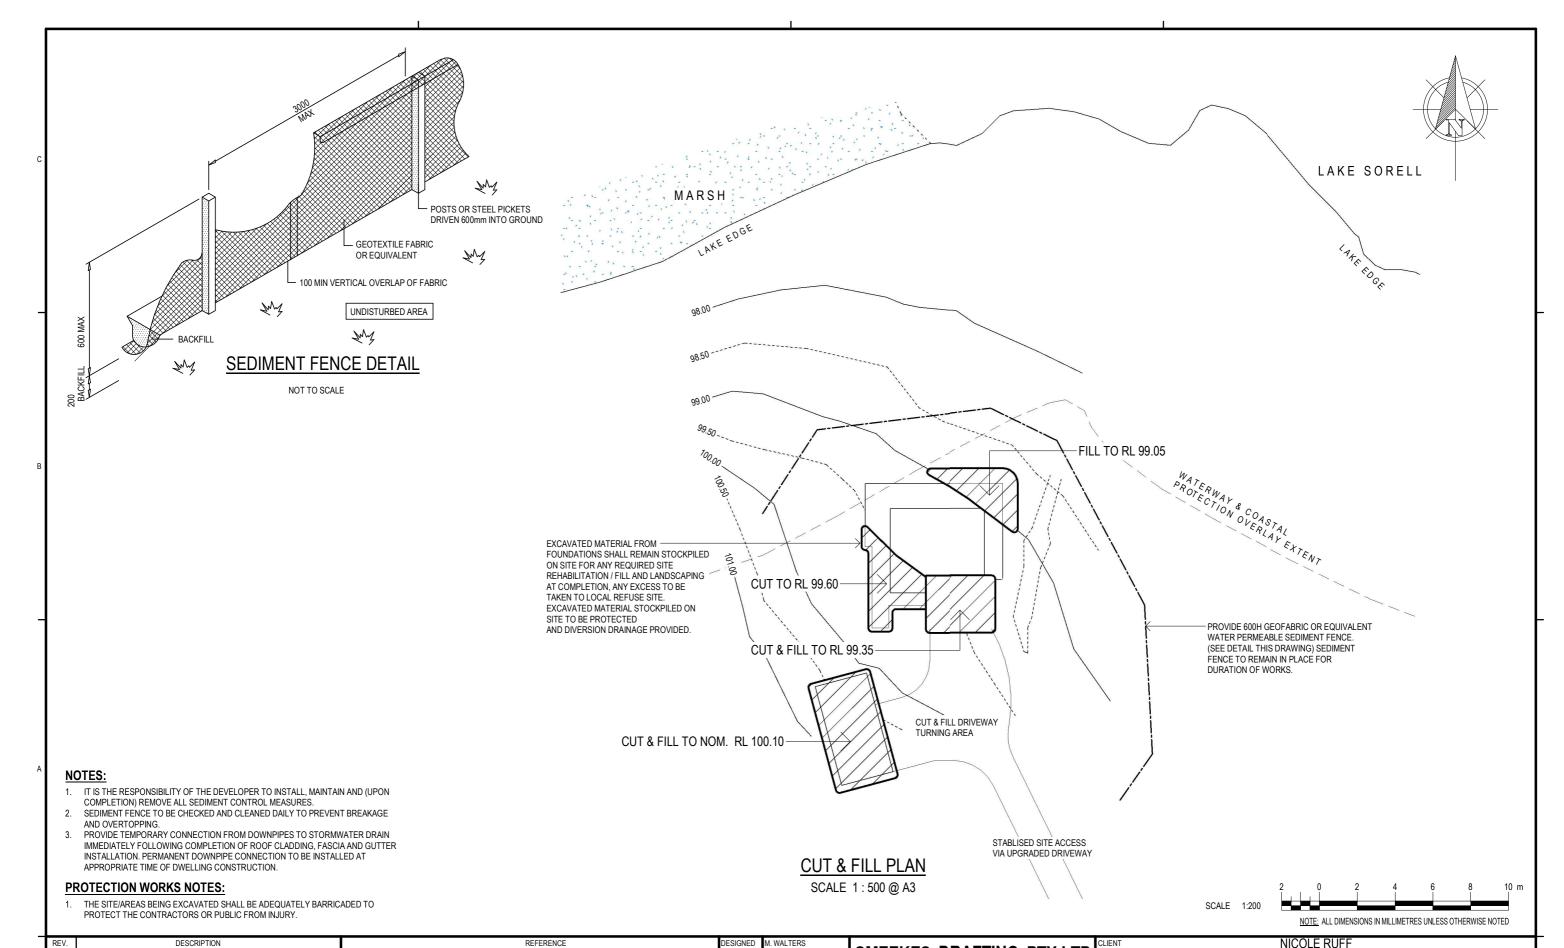


NICOLE RUFF
PROPOSED DWELLING SMEEKES DRAFTING PTY LTD L. RAGUS / M. WALTERS ISSUED FOR CLIENT FOR REVIEW. 23-12-2021 SITE PLAN PROPOSED ORTHOGRAPHIC VIEWS RUFF-001 HECKED M WAITERS PROPOSED PART SITE PLAN ISSUED FOR COUNCIL FOR PLANNING APPROVAL, 24-12-2021 RUFF-002 LOT 1 TUNBRIDGE TIER ROAD, INTERLAKEN, TAS. 7030 SOIL & WATER MANAGEMENT PLAN RUFF-003 17 Bayfield Street, Rosny Park, TAS 7018 VEGETATION MANAGEMENT PLAN RUFF-004 Office Phone: (03) 6234 6185 PROPOSED GROUND FLOOR PLAN RUFF-005 **SOIL & WATER MANAGEMENT PLAN** Email: admin@smeekesdrafting.com PROPOSED MEZZANINE FLOOR PLAN RUFF-006 Website: www.smeekesdrafting.com PROPOSED ELEVATIONS 1 OF 2 **BUILDING DESIGNERS** SCALE PROPOSED ELEVATIONS 2 OF 2 Building Designer Licence Nos. 723026951, 861284073 & CC6621 1:500 ASSOCIATION OF AUSTRALIA


#### **VEGETATION MANAGEMENT NOTE:**

EXTENT OF MODIFICATION TO VEGETATION FOR REQUIRED BUSHFIRE HAZARD MANAGEMENT AREA (BAL-12.5) AROUND THE PROPOSED DWELLING TO PROVIDE A DEFENDABLE SPACE.

- EXISTING GROUND COVER WITHIN THE HMA, CONSISTING MOSTLY OF NATIVE GRASSES, TO BE RETAINED AND MAINTAINED TO NO MORE THAN 100mm HIGH TO PROVIDE FOR LOW FUEL LOADS . REMOVE AND MINIMSE ALL GROUND LITTER (FALLEN LIMBS, STICKS, BARK, LEAVES).
- EXISTING MIDDLE GROWTH OF SHRUBS WITHIN THE HMA MODIFIED TO PROVIDE SEPARATION BETWEEN SMALL CLUMPS OF SHRUBS (3 - 4) AND NO MIDDLE GROWTH TO BE LOCATED UNDER TREES. SMALL SHRUBS WITHIN 3m THE DWELLING & LARGE SHRUBS WITHIN 6m OF THE DWELLING TO BE REMOVED.
- EXISTING TREES WITHIN THE HMA TO BE MAINTAINED BUT THINNED WHERE REQUIRED TO PROVIDE MIN. 6m CANOPY SEPARATION BETWEEN EACH TREE AND TO BE NO CLOSER THAN 6m TO THE DWELLING (FROM TREE CANOPY) OR NOT BE ABLE TO FALL ONTO THE BUILDING. PRUNE ALL BRANCHES LESS THAN 2m ABOVE GROUND.
- THESE VEGETATION MODIFICATIONS ARE IN ACCORDANCE WITH FUTURE BHMP REQUIRED FOR BUILDING APPROVAL.

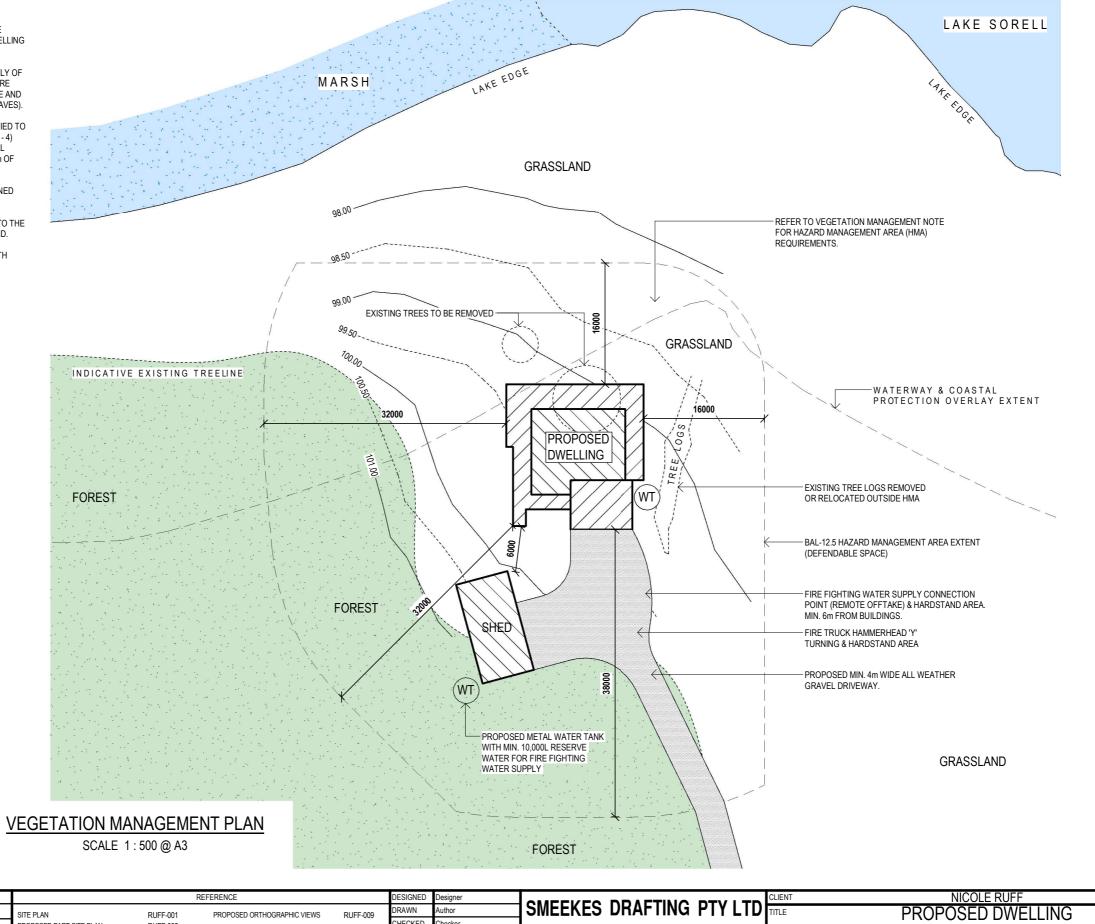

T	REV.	DESCRIPTION			REFERENCE		DESIGNED	Designer	OMERICEO	DDAETING		CLIENT	NICOLE RU	JFF	
			SITE PLAN	RUFF-001	PROPOSED ORTHOGRAPHIC VIEWS	RUFF-009	DRAWN	Author	SMEEKES	DRAFTING	PIYLID	TITLE	PROPOSED DV	NELLING	
			PROPOSED PART SITE PLAN	RUFF-002			CHECKED	Checker		ABN 89 056 706 640		LO			ΔS 7030
			SOIL & WATER MANAGEMENT PLAN	RUFF-003						17 Bayfield Street, Rosn	ny Park, TAS 7018		I I TONDINDOL HER NOAD	, IIN I LIXLAIXLIN, 17	AO. 1000
			VEGETATION MANAGEMENT PLAN PROPOSED GROUND FLOOR PLAN	RUFF-004 RUFF-005						Office Phone: (03) 6234	1 6185				
			PROPOSED MEZZANINE FLOOR PLAN	RUFF-006						Email: admin@smeekes			VEGETATION MANA	<u>GEMENT PLAN</u>	
			PROPOSED ELEVATIONS 1 OF 2	RUFF-007			BUILD	ING DESIGNERS		Website: www.smeekes	<b></b>	DRG	DLIEE	SHT. OO 1	SCALE 1:500 A3
			PROPOSED ELEVATIONS 2 OF 2	RUFF-008			ASSOC	ATION OF AUSTRALIA	Building Designer Lice	ence Nos. 723026951, 8612	84073 & CC6621	No.	RUFF	<sup>внт.</sup> 004	1:500 AS

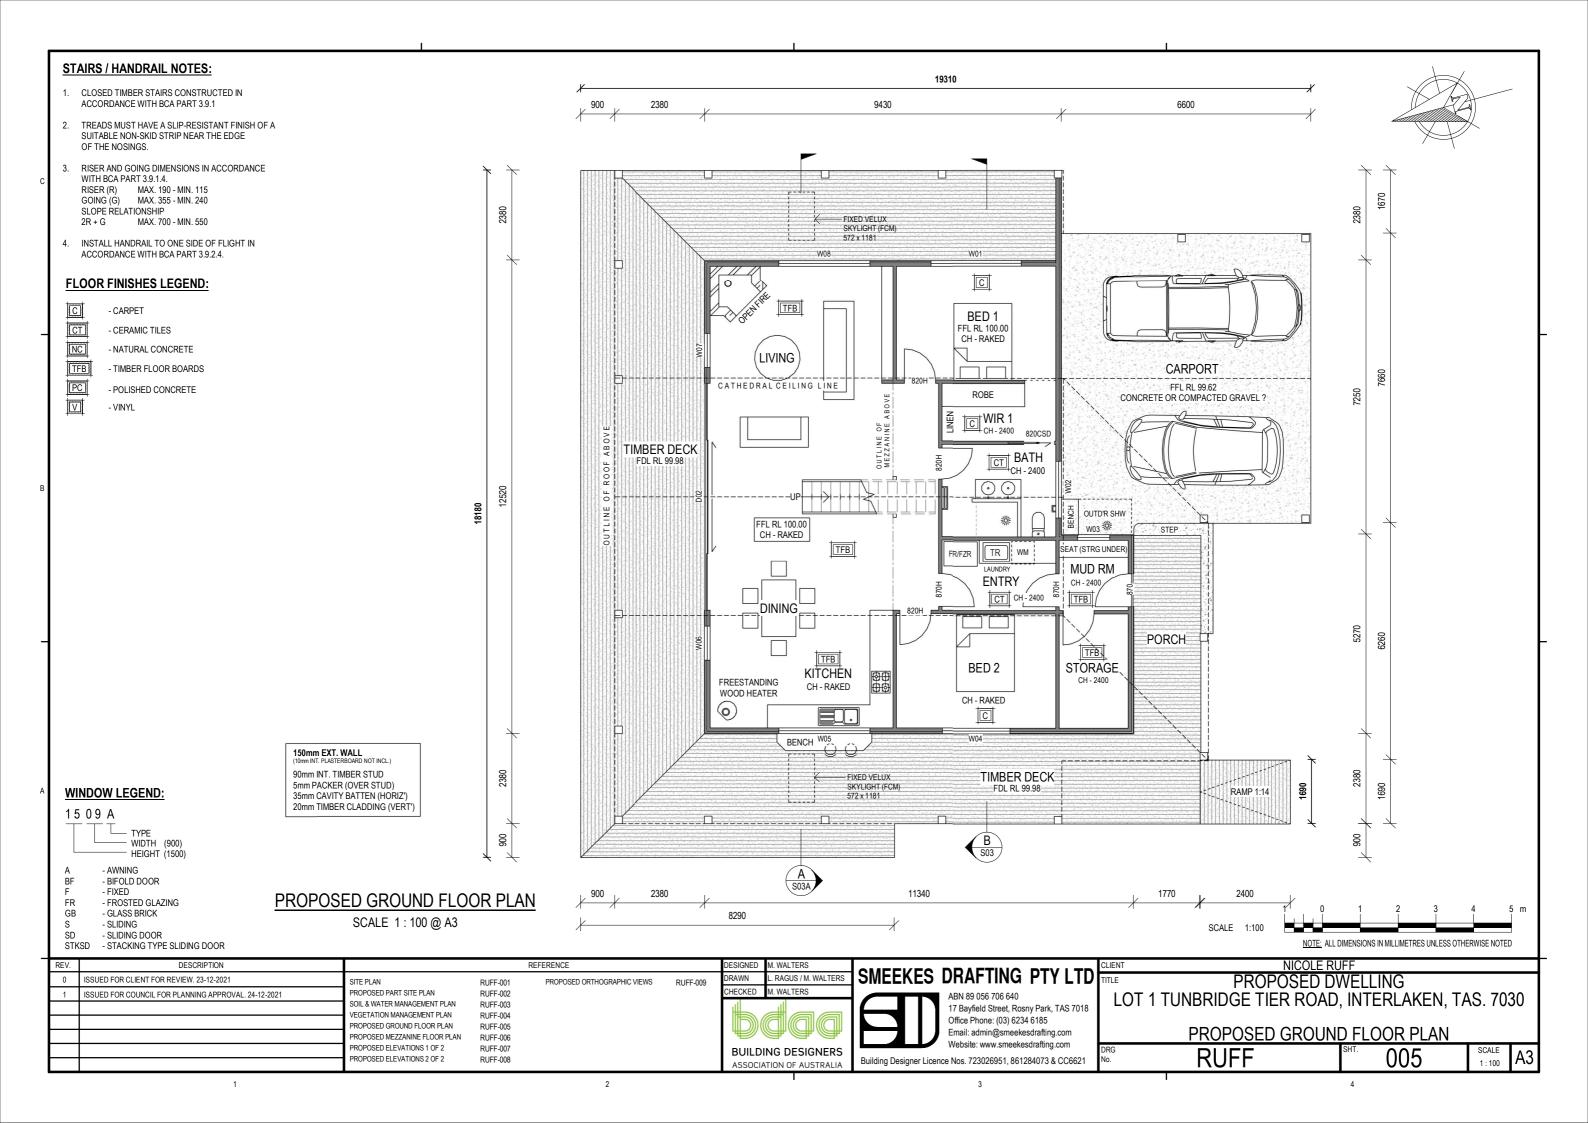

#### STAIRS / HANDRAIL NOTES:

- CLOSED TIMBER STAIRS CONSTRUCTED IN ACCORDANCE WITH BCA PART 3.9.1
- TREADS MUST HAVE A SLIP-RESISTANT FINISH OF A SUITABLE NON-SKID STRIP NEAR THE EDGE OF THE NOSINGS.
- 3. RISER AND GOING DIMENSIONS IN ACCORDANCE WITH BCA PART 3.9.1.4.
  RISER (R) MAX. 190 MIN. 115
  GOING (G) MAX. 355 MIN. 240
  SLOPE RELATIONSHIP
  2R + G MAX. 700 MIN. 550
- 4. INSTALL HANDRAIL TO ONE SIDE OF FLIGHT IN ACCORDANCE WITH BCA PART 3.9.2.4.

#### **FLOOR FINISHES LEGEND:**

С

- CARPET

СТ

- CERAMIC TILES
- NATURAL CONCRETE

NC TFB

- TIMBER FLOOR BOARDS

PC


- POLISHED CONCRETE

V - VINYL



- SLIDING

SD - SLIDING DOOR STKSD - STACKING TYPE SLIDING DOOR

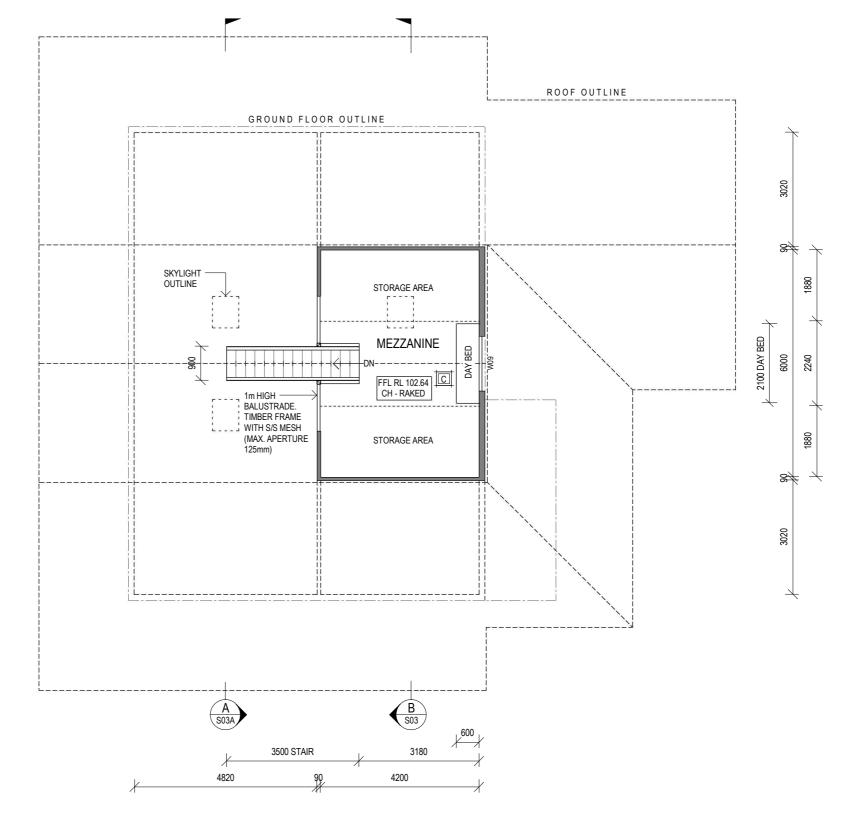


### PROPOSED UPPER FLOOR MEZZANINE PLAN

SCALE 1:100 @ A3



REV.	DESCRIPTION		RE	EFERENCE		DESIGNED	M. WALTERS	OMERICA DRAFTING BEVILED	CLIENT	NICOLE	RUFF	
0	ISSUED FOR CLIENT FOR REVIEW. 23-12-2021	SITE PLAN	RUFF-001	PROPOSED ORTHOGRAPHIC VIEWS	RUFF-009	DRAWN	L. RAGUS	SMEEKES DRAFTING PTY LTD	TITLE	PROPOSED	DWELLING	
1	ISSUED FOR COUNCIL FOR PLANNING APPROVAL. 24-12-2021		RUFF-002			CHECKED	M. WALTERS	ABN 89 056 706 640	1 OT 1	TUNBRIDGE TIER ROA		LV6 2030
			RUFF-003			#		17 Bayfield Street, Rosny Park, TAS 7018	LOTI	I DINDINIDGE TIEN NO	AD, INTLINEAREN,	170.7000
			RUFF-004 RUFF-005				alala	Office Phone: (03) 6234 6185				_
			RUFF-006					Email: admin@smeekesdrafting.com		PROPOSED MEZZA	<u>NINE FLOOR PLAN</u>	
			RUFF-007			BUILDI	NG DESIGNERS	Website: www.smeekesdrafting.com	DRG	DLIEE	SHT. OOG	SCALE A3
		PROPOSED ELEVATIONS 2 OF 2	RUFF-008			ASSOCIA	TION OF AUSTRALIA	Building Designer Licence Nos. 723026951, 861284073 & CC6621	No.	RUFF	SHT. 006	1:100 A3

# **ELEVATION KEYNOTES:** TYP. DOUBLE GLAZED DOORS TO BAL-12.5. COLOUR OF FRAME - COLORBOND 'MONUMENT.' CHIMNEY FLUE. STAINLESS STEEL.' 1800 MIN. HEIGHT ABOVE COLORBOND 'CUSTOM ORB' ROOF CLADDING. COLOUR - COLORBOND 'MONUMENT'. STRUCTURAL TIMBER POST TO BAL-12.5. SPECIES, FINISH & COLOUR TO OWNER'S CHOICE. ROUGH SAWN VERTICAL TIMBER CLADDING TO BAL-12.5. SPECIES & COLOUR TO OWNER'S CHOICE. COLORBOND 'CUSTOM ORB' WALL CLADDING, VERTICAL. COLOUR - COLORBOND 'MONUMENT.' TYP. DOUBLE GLAZED WINDOWS TO BAL-12.5. COLOUR OF FRAME - COLORBOND 'MONUMENT.' N.G.L. FFL RL 100.00 FQL RL 99.98 SCALE 1:100 NOTE: ALL DIMENSIONS IN MILLIMETRES UNLESS OTHERWISE NOTED NICOLE RUFF PROPOSED DWELLING LOT 1 TUNBRIDGE TIER ROAD, INTERLAKEN, TAS. 7030 PROPOSED ELEVATIONS 1 OF 2 SCALE Building Designer Licence Nos. 723026951, 861284073 & CC6621 1:100

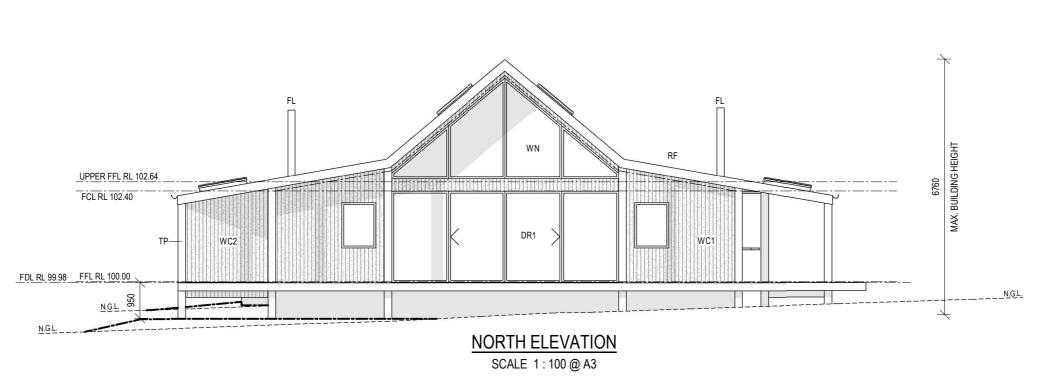



2

DESCRIPTION REFERENCE L. RAGUS ISSUED FOR CLIENT FOR REVIEW. 23-12-2021 PROPOSED ORTHOGRAPHIC VIEWS SITE PLAN RUFF-001 PROPOSED PART SITE PLAN HECKED M. WALTERS ISSUED FOR COUNCIL FOR PLANNING APPROVAL. 24-12-2021 RUFF-002 SOIL & WATER MANAGEMENT PLAN RUFF-003 VEGETATION MANAGEMENT PLAN RUFF-004 PROPOSED GROUND FLOOR PLAN RUFF-005 PROPOSED MEZZANINE FLOOR PLAN RUFF-006 PROPOSED ELEVATIONS 1 OF 2 PROPOSED ELEVATIONS 2 OF 2

**BUILDING DESIGNERS** ASSOCIATION OF AUSTRALIA

SMEEKES DRAFTING PTY LTD TITLE 17 Bayfield Street, Rosny Park, TAS 7018 Office Phone: (03) 6234 6185 Email: admin@smeekesdrafting.com Website: www.smeekesdrafting.com


### **ELEVATION KEYNOTES:**

FL	CHIMNEY FLUE. STAINLESS STEEL.' 1800 MIN. HEIGHT ABOVE ROOF.
RF	COLORBOND 'CUSTOM ORB' ROOF CLADDING. COLOUR - COLORBOND 'MONUMENT'.
RMP	1:14 TIMBER RAMP TO BAL-12.5. SPECIES & COLOUR TO MATCH WALL CLADDING.
TD	HARDWOOD TIMBER DECK TO BAL-12.5. SPECIES & COLOUR TO MATCH WALL CLADDING.
TP	STRUCTURAL TIMBER POST TO BAL-12.5. SPECIES, FINISH & COLOUR TO OWNER'S CHOICE.
WC1	ROUGH SAWN VERTICAL TIMBER CLADDING TO BAL-12.5. SPECIES & COLOUR TO OWNER'S CHOICE.
WC2	COLORBOND 'CUSTOM ORB' WALL CLADDING, VERTICAL. COLOUR - COLORBOND 'MONUMENT.'
WN	TYP. DOUBLE GLAZED WINDOWS TO BAL-12.5. COLOUR OF FRAME - COLORBOND 'MONUMENT.'

## UPPER FFL RL 102.64 WC1 FCL RL 102.40 WC1 WC2 WC2 FFL RL 100.00 FDL RL 99.98 FSL 99.62

### **SOUTH ELEVATION**

SCALE 1:100 @ A3

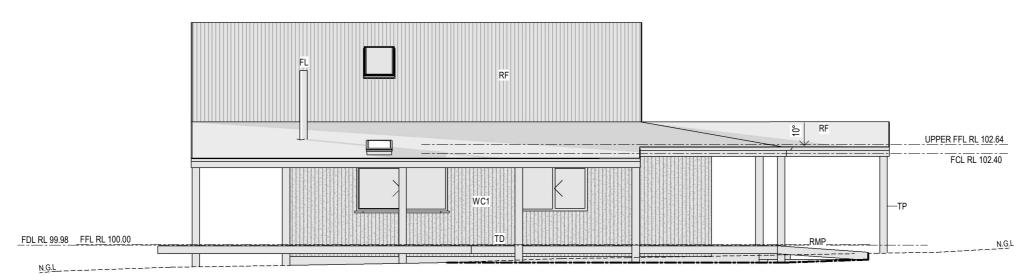

# WEST ELEVATION SCALE 1:100 @ A3



REV.	DESCRIPTION		RE	FERENCE		DESIGNED	M. WALTERS	OMERICEO P	SDAETING BEVLED	CLIENT	NICOLE F	RUFF	
0	ISSUED FOR CLIENT FOR REVIEW. 23-12-2021	SITE PLAN	RUFF-001	PROPOSED ORTHOGRAPHIC VIEWS	RUFF-009			SMEEKES L	PRAFTING PTY LTD	TITLE	PROPOSED [	OWELLING	
1	ISSUED FOR COUNCIL FOR PLANNING APPROVAL. 24-12-2021	PROPOSED PART SITE PLAN SOIL & WATER MANAGEMENT PLAN	RUFF-002 RUFF-003			CHECKED	M. WALTERS		ABN 89 056 706 640 17 Bayfield Street, Rosny Park, TAS 7018	LOT 1 T	UNBRIDGE TIER ROAI		AS. 7030
		VEGETATION MANAGEMENT PLAN PROPOSED GROUND FLOOR PLAN	RUFF-004 RUFF-005				daa		Office Phone: (03) 6234 6185 Email: admin@smeekesdrafting.com		PROPOSED ELEV	ATIONS 2 OF 2	
		PROPOSED MEZZANINE FLOOR PLAN PROPOSED ELEVATIONS 1 OF 2 PROPOSED ELEVATIONS 2 OF 2	RUFF-006 RUFF-007 RUFF-008				NG DESIGNERS		Website: www.smeekesdrafting.com Nos. 723026951, 861284073 & CC6621	DRG No	RUFF	SHT. 008	SCALE A3
		110.0025 222 11.101.02 31 2	1011-000			ASSOCIA	TION OF AUSTRALIA	building Designer Licence	1 NOS. 723020931, 001204073 & CC0021	110.	11011	1 000	1:100
	1			2			•		3	•		4	



### ORTHOGRAPHIC KEYNOTES:

CS	CONCRETE SLAB. NATURAL TROWEL FINISH.
DR1	TYP. DOUBLE GLAZED DOORS TO BAL-12.5. COLOUR OF FRAME - COLORBOND 'MONUMENT.'
FL	CHIMNEY FLUE. STAINLESS STEEL.' 1800 MIN. HEIGHT ABOVE ROOF.
RF	COLORBOND 'CUSTOM ORB' ROOF CLADDING. COLOUR - COLORBOND 'MONUMENT'.
RMP	1:14 TIMBER RAMP TO BAL-12.5. SPECIES & COLOUR TO MATCH WALL CLADDING.
TD	HARDWOOD TIMBER DECK TO BAL-12.5. SPECIES & COLOUR TO MATCH WALL CLADDING.
TP	STRUCTURAL TIMBER POST TO BAL-12.5. SPECIES, FINISH & COLOUR TO OWNER'S CHOICE.
WC1	ROUGH SAWN VERTICAL TIMBER CLADDING TO BAL-12.5. SPECIES & COLOUR TO OWNER'S CHOICE.
WC2	COLORBOND 'CUSTOM ORB' WALL CLADDING, VERTICAL. COLOUR - COLORBOND 'MONUMENT.'
WN	TYP. DOUBLE GLAZED WINDOWS TO BAL-12.5. COLOUR OF FRAME - COLORBOND 'MONUMENT.'

REV.	DESCRIPTION		REFERENCE		DESIGNED	M. WALTERS	OMERICA DRAFTING BTV LTD	CLIENT NICOLE RUFF
0	ISSUED FOR CLIENT FOR REVIEW. 23-12-2021	SITE PLAN R	RUFF-001 PROPOSED ORTHOGRAPHIC VIEWS	RUFF-009	DRAWN	L. RAGUS	SMEEKES DRAFTING PTY LTD	PROPOSED DWELLING
1	1000EB FOR COORDIE FOR FEMALURO / IF HOVE E E 12 EUE		RUFF-002		CHECKED	M. WALTERS	ABN 89 056 706 640	LOT 1 TUNBRIDGE TIER ROAD, INTERLAKEN, TAS. 7030
			RUFF-003 RUFF-004				17 Bayfield Street, Rosny Park, TAS 7018	LOT I TONDINDOL HER ROAD, INTERLAREN, TAO. 1000
			RUFF-005			alalal	Office Phone: (03) 6234 6185	DDODOGED ORTHOODARING MENAG
		PROPOSED MEZZANINE FLOOR PLAN R	RUFF-006				Email: admin@smeekesdrafting.com	PROPOSED ORTHOGRAPHIC VIEWS
			RUFF-007		BUILDI	NG DESIGNERS	Website: www.smeekesdrafting.com	RUFF SHT. 009 SCALE A3
		PROPOSED ELEVATIONS 2 OF 2 R	RUFF-008		ASSOCIA	TION OF AUSTRALIA	Building Designer Licence Nos. 723026951, 861284073 & CC6621	RUFF SHI. 009 SCALE A3

# R A I N B O W building solutions

**Specification Report** 

Distributor:

139 Main Rd

Spec. Date: 3/12/2021

Spec. Number: KING01\_4574

Customer: Nicole Ruff

Site Address:


Lot 1 Tunbridge Tier Road, Interlaken, TAS, 7030


Sorrel, 7172, TAS

Rainbow Building


Telephone: 1300 737 910 Telephone:

Building Description:	Main Building:	Left Skillion:	Right Skillion:		
Span:	4.50m	4.50m	4.50m		
Bay Size:	3.5m	3.50m	3.50m		
Number of Bays:	2	2	2		
Length:	7.00m	7.00m	7.00m		
Wall Height:	3,80m	2.40m	2.40m		
Apex Height:	4.73m	NA	NA		
Roof Pitch:	22.5°	11°	11°		
Roof Area:	34.09m²	32.09m²	32.09m²		
Roof Purlin Type:	TH64100	TH64100	TH64100		
Roof Purlin Spacing (Internal):	600	600	600		
Roof Purlin Spacing (End):	600	600	600		
Purlin Lap:	10%	10	10		
Wall Girt Type:	TH64100	TH64100	TH64100		
Wall Girt Spacing:	1400	1400	1400		
Girt Lap:	10%	10	10		
Eave Purlin Type:	C15019	C15019	C15019		
Column Size:	C15024	C15019	C15019		
Rafter Size:	C15024	C15019	C15019		
Mullion Size:	C15024	NA	NA		
Knee Brace:	NA	NA	NA		
Ridge Brace:	C10019	NA	NA		
Wall Cladding:	0.42 BMT (0.47 TC	T) Corrugated Colorbond®			
Roof Cladding:	0.42 BMT (0.47 TC	T) Corrugated Colorbond®			
Down Pipes:	Downpipe 90mm Re	ound			
Gutters:	Quad Gutter 115 Hi	gh Tensile			
Barge:	Garage Barge				
Roller Doors:	1 x 3000H x 3250W (Opening: 3000H x 3190W) Series A Roller Door Manua Lift Colorbond				

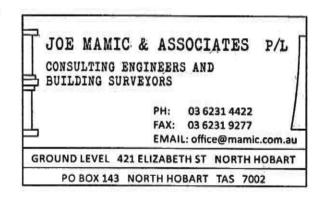

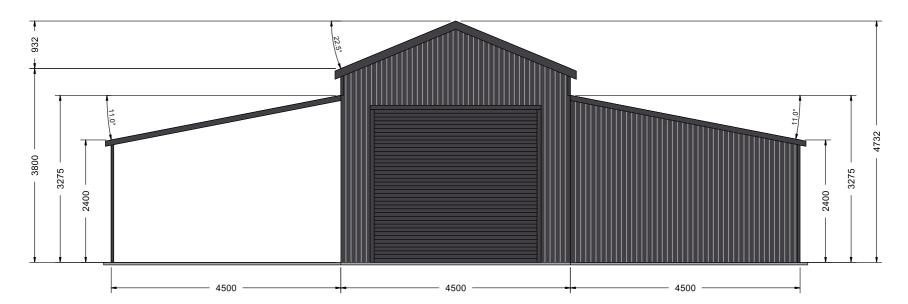

## **FRONT ELEVATION**

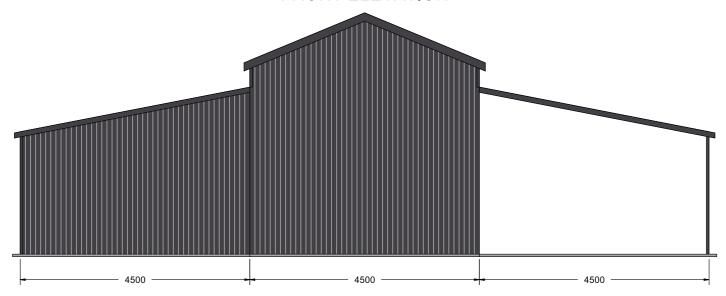

# **REAR ELEVATION**



Email: sales@rainbowbuilding.com.au

CLIENT: Nicole Ruff

PHONE:

DRAWING TITLE: End Elevations

SITE ADDRESS: Lot 1 Tunbridge Tier Road, Interlaken, TAS, 7030SCALE: 1:74.123


DATE: 03-12-2021

EMAIL: Nicole.Ruff@skretting.com

Job Number: KING01\_4574

Drawing Number: EE



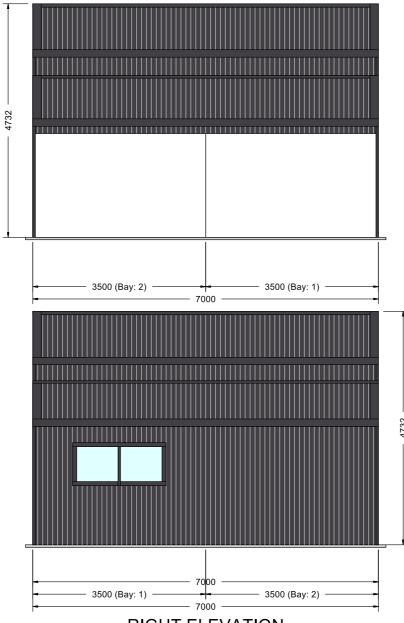

**RIGHT ELEVATION** 



Email: sales@rainbowbuilding.com.au

CLIENT: Nicole Ruff


DRAWING TITLE: Side Elevations

SITE ADDRESS: Lot 1 Tunbridge Tier Road, Interlaken, TAS, 7030SCALE: 1:76.599
PHONE:
DATE: 03-12-20

DATE: 03-12-2021 Job Number: KING01\_4574

EMAIL: Nicole.Ruff@skretting.com

Drawing Number: SE

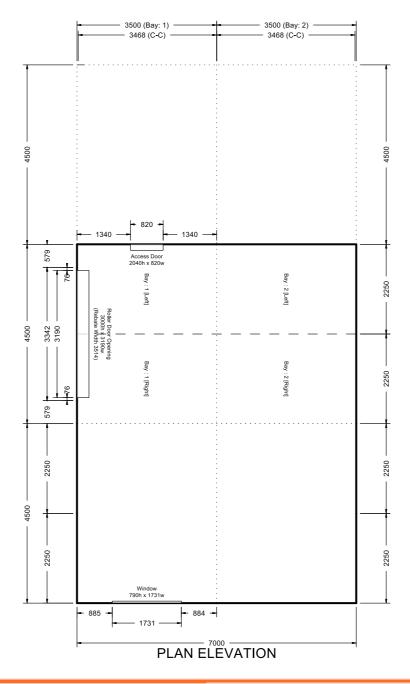



Email: sales@rainbowbuilding.com.au

CLIENT: Nicole Ruff

PHONE:

DRAWING TITLE: Plan Elevation


SITE ADDRESS: Lot 1 Tunbridge Tier Road, Interlaken, TAS, 70305CALE: 1:94.807

DATE: 03-12-2021


Job Number: KING01\_4574


EMAIL: Nicole.Ruff@skretting.com

Drawing Number:

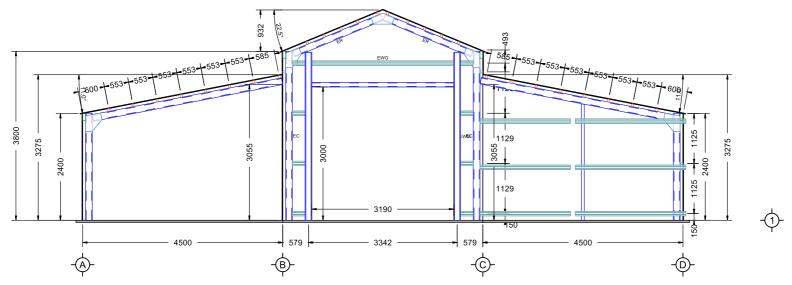

#### FRONT ELEVATION

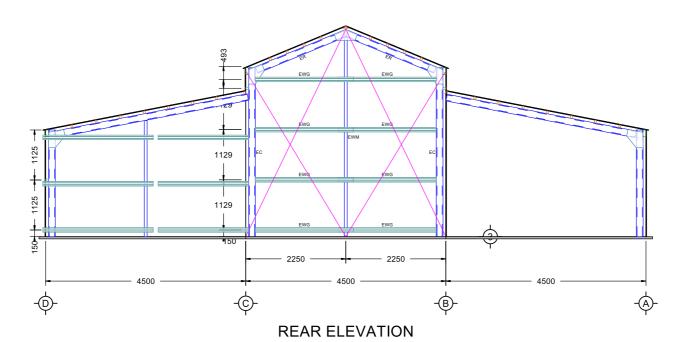

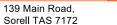

Phone: 1300 737 910

Email: sales@rainbowbuilding.com.au

CLIENT: Nicole Ruff

DRAWING TITLE: End Frame Elevations


SITE ADDRESS: Lot 1 Tunbridge Tier Road, Interlaken, TAS, 7030SCALE: 1:85.057
PHONE:
DATE: 03-12-20

EMAIL: Nicole.Ruff@skretting.com


DATE: 03-12-2021 Job Number: KING01\_4574

Drawing Number: EFE



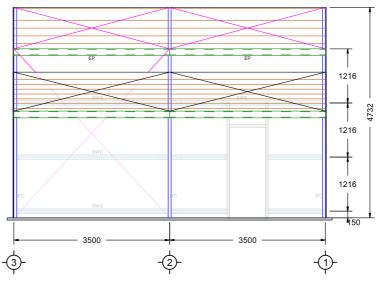

LEFT ELEVATION

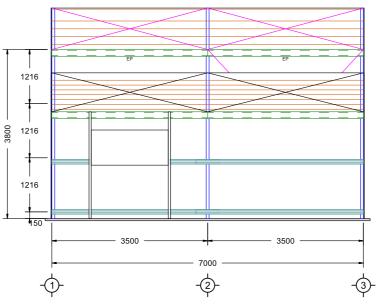

**RIGHT ELEVATION** 

Email: sales@rainbowbuilding.com.au

CLIENT: Nicole Ruff


**DRAWING TITLE: Side Frame Elevations** 

SITE ADDRESS: Lot 1 Tunbridge Tier Road, Interlaken, TAS, 7030SCALE: 1:84.975

PHONE: DATE: 03-12-2021 EMAIL: Nicole.Ruff@skretting.com Job Number: KING01\_4574

Drawing Number: SFE



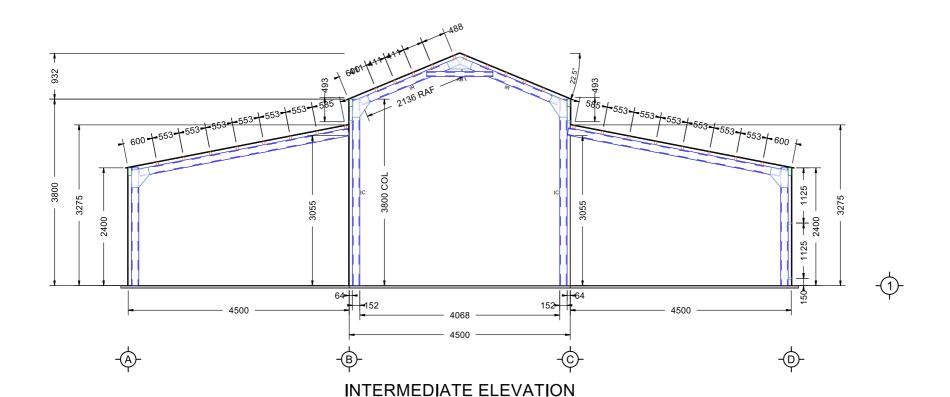



Email: sales@rainbowbuilding.com.au

CLIENT: Nicole Ruff

DRAWING TITLE: Cross Section

SITE ADDRESS: Lot 1 Tunbridge Tier Road, Interlaken, TAS, 7030SCALE: 1:77.003

PHONE:


DATE: 03-12-20

DATE: 03-12-2021

Job Number: KING01\_4574

EMAIL: Nicole.Ruff@skretting.com

Drawing Number: CS

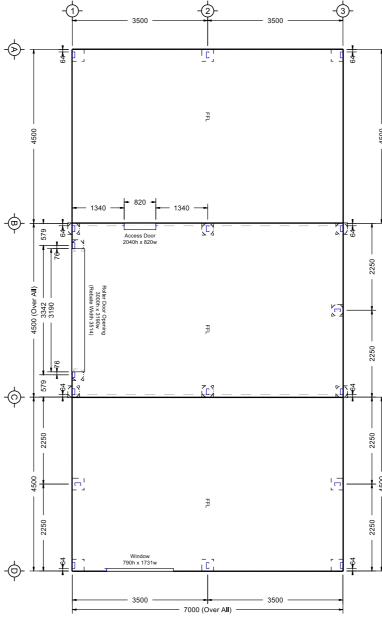

FLOOR PLAN



Email: sales@rainbowbuilding.com.au

CLIENT: Nicole Ruff

PHONE:

DRAWING TITLE: Floor Plan


SITE ADDRESS: Lot 1 Tunbridge Tier Road, Interlaken, TAS, 70306CALE: 1:97.854

DATE: 03-12-2021

Job Number: KING01\_4574

EMAIL: Nicole.Ruff@skretting.com

Drawing Number: FP

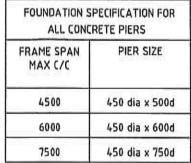


FOR SITE CLASSIFICATION A,S & M


OTHER SITE CLASSES BY OTHERS

NOTE: STRIP SITE OF TOPSOIL VEGETATION MIN. 100 ROOT BALLS AND SOFT AREAS TO APPROVAL BEFORE PLACING ANY FILL BELOW SLAB ALL CONCRETE EDGE BEAMS MUST BE FOUNDED ON FIRM NATURAL SUB-GRADE. DEEPEN EDGE BEAMS AS REQUIRED

CORNER PIER

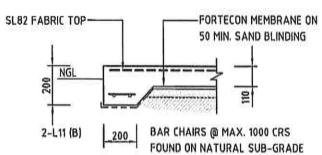


# **SLAB EDGE BEAM**

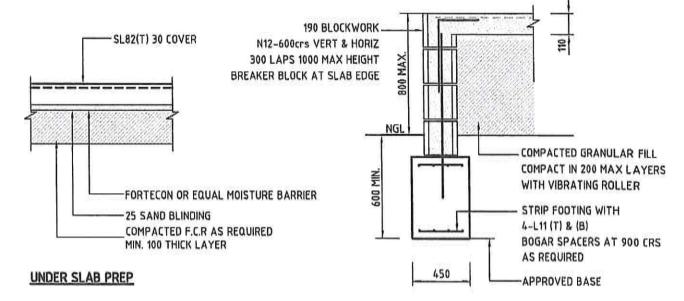


# FRAME SPAN 110 SLAB ON GRADE SL82 (T) 30 COVER N25 CONCRETE SLAB EDGE BEAM INTERNAL PIER 110 SLAB ON GRADE SL82 (T) 30 COVER N25 CONCRETE

NOTE : REFER SITE SPECIFICATION & ELEVATION DRAWINGS

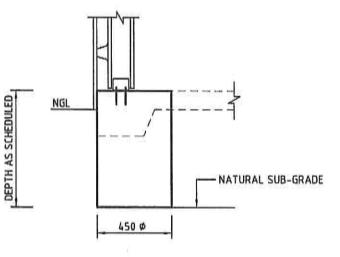

PIER/SLAB DETAIL

# 20d x 10w SAW-CUT JOINT FORMED WITHIN 3 DAYS OF

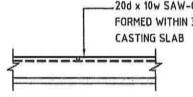


# SLAB SAW-CUT DETAIL

WHERE SLAB O/A LENGTH > 9.0m
PLACE SAW CUTS AT NO MORE THAN 6m INTERVALS


#### RETAINING WALL DETAILS

HEIGHT > 500mm HEIGHT < 1000mm

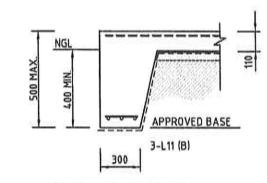

#### RETAINING WALL DETAILS

HEIGHT - 500mm

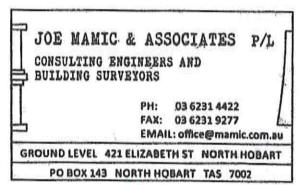

0 6 DEC 2021

#### TYPICAL SLAB & PIER LAYOUT

NOTES :

SLAB DESIGN FOR CLASS A,S & M TO AS 2870
TYPICALLY N25 CONCRETE 30mm COVER TO REO
LAP REO MIN. 225mm SUPPORT ON BAR CHAIRS AT 1000 MAX crs
POUR PIER FOOTINGS INTEGRAL WITH SLAB
DO NOT PLACE INFILL CONCRETE SLAB AGAINST WALL SHEETING
PROVIDE 25mm POLYSTYRENE SHEET AS BARRIER

-MULLION PIER

NOTE : REFER RAINBOW BUILDING SOLUTIONS SPECIFICATIONS FOR SITE SPECIFIC INFORMATION & STRUCTURAL CERTIFICATION

R A II N O

Building solutions

139 Main Road Sorell, TAS 7172 www.rainbowbuilding.com.au T: 1300 737 910

RAINBOW BUILDING SOLUTIONS
SHED CONSTRUCTION DETAILS
MAX. 7.5m WIDE SHED CONSTRUCTION
FOOTING/SLAB DETAILS - CLASS 10A
STRUCTURES ONLY

Designed by: JM


Accreditation Number:
CC411N

Date:
June '11


Job No.
RAINB-7.5
Drawing No.

N.T.S

June '15 S1

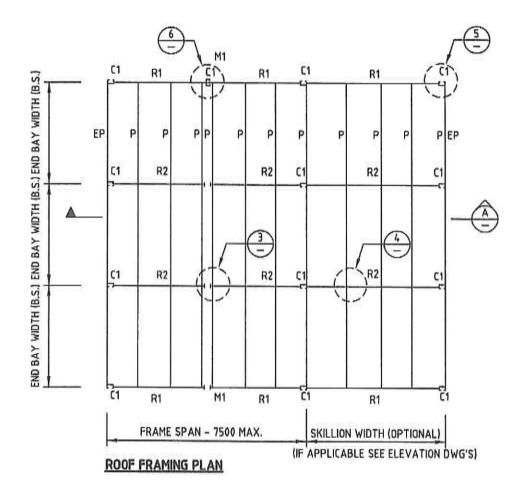

NOTE : REFER RAINBOW BUILDING SOLUTIONS SPECIFICATIONS FOR SITE SPECIFIC INFORMATION & STRUCTURAL CERTIFICATION

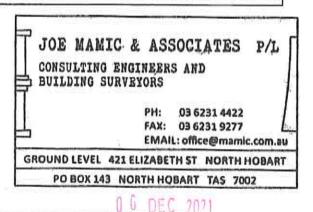


ROOF & WALL	SHEETING MA	X. SPAN TABLE	\$	
CLADDING	LOCATION	END SPAN	INT SPAN	
CORRUGATED 0.42 BMT	ROOF	900	1200	
CORRUGATED 0.42 BMT	WALL	1200	1500	
K-PANEL 0.42 BMT	WALL	1200	1500	
MONOCLAD 0.42 BMT	ROOF	900	1200	
MONOCLAD 0.42 BMT	WALL	1200	1500	

#### **RBS CONSTRUCTION NOTES:**

NOTES:

- 1. REFER RAINBOW BUILDING SPECIFICATIONS FOR SITE SPECIFIC INFORMATION
- 2. END WALL CLADDING CAN BE DELETED TO ENABLE OPEN END BAYS
- 3. WALL CLADDING CAN BE DELETED ONE FULL SIDE PROVIDE MIN.

  1 BRACED BAY EACH SIDE
- 4. WHERE 2 OR MORE BAYS OPEN SIDED & COLUMNS > 3.0m IN HEIGHT PROVIDE BACK TO BACK COLUMNS

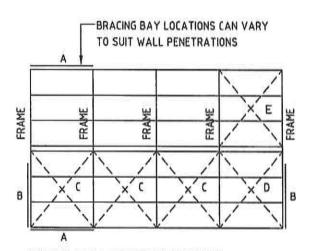


#### **ROOF & WALL BRACING SCHEDULE**

ALL BRACING 32 X 1.2 G500 GI STRAP 2 - 14-20 X 22 TEK SCREWS EACH END TO FRAMES WITH TENSIONER FIX TO EXTERNAL FACE OF COLUMNS & RAFTERS

MAX SPAN	6m	7.5m		
BAY SIZE crs > 4.0m	B,C,D	B,C,D		
LENGTH > 4 BAYS	A,B,C,D,E	A,B,C,D,E		
HEIGHT > 3.0m	B,C,D	B,C,D		
	BAY SIZE crs > 4.0m LENGTH > 4 BAYS	BAY SIZE crs > 4.0m B,C,D LENGTH > 4 BAYS A,B,C,D,E		

FRAMES UP TO 7.5M SPAN WITHIN THESE PARAMETERS REQUIRE NO BRACING

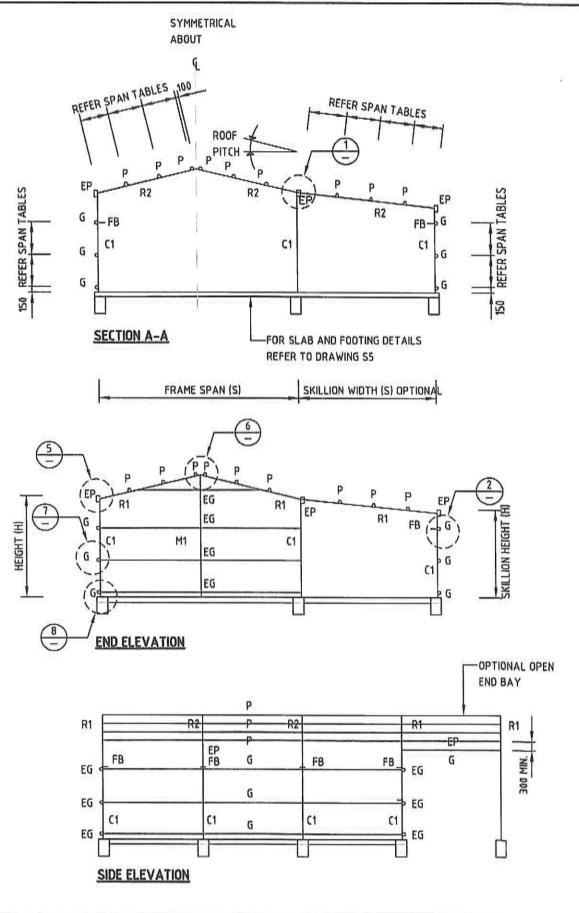




Project Tifle:
RAINBOW BUILDING SOLUTIONS
STEEL FRAME BUILDINGS
MAX. 7.5m WIDE SHED CONSTRUCTION
TYPICAL WALL FRAMING &
ROOF FRAMING DETAILS


Job No.
RAINB - 7.5
Drawing No.

Scale:

N.T.S

Designed by: JM Accreditation Number: CC411N Date: June '15

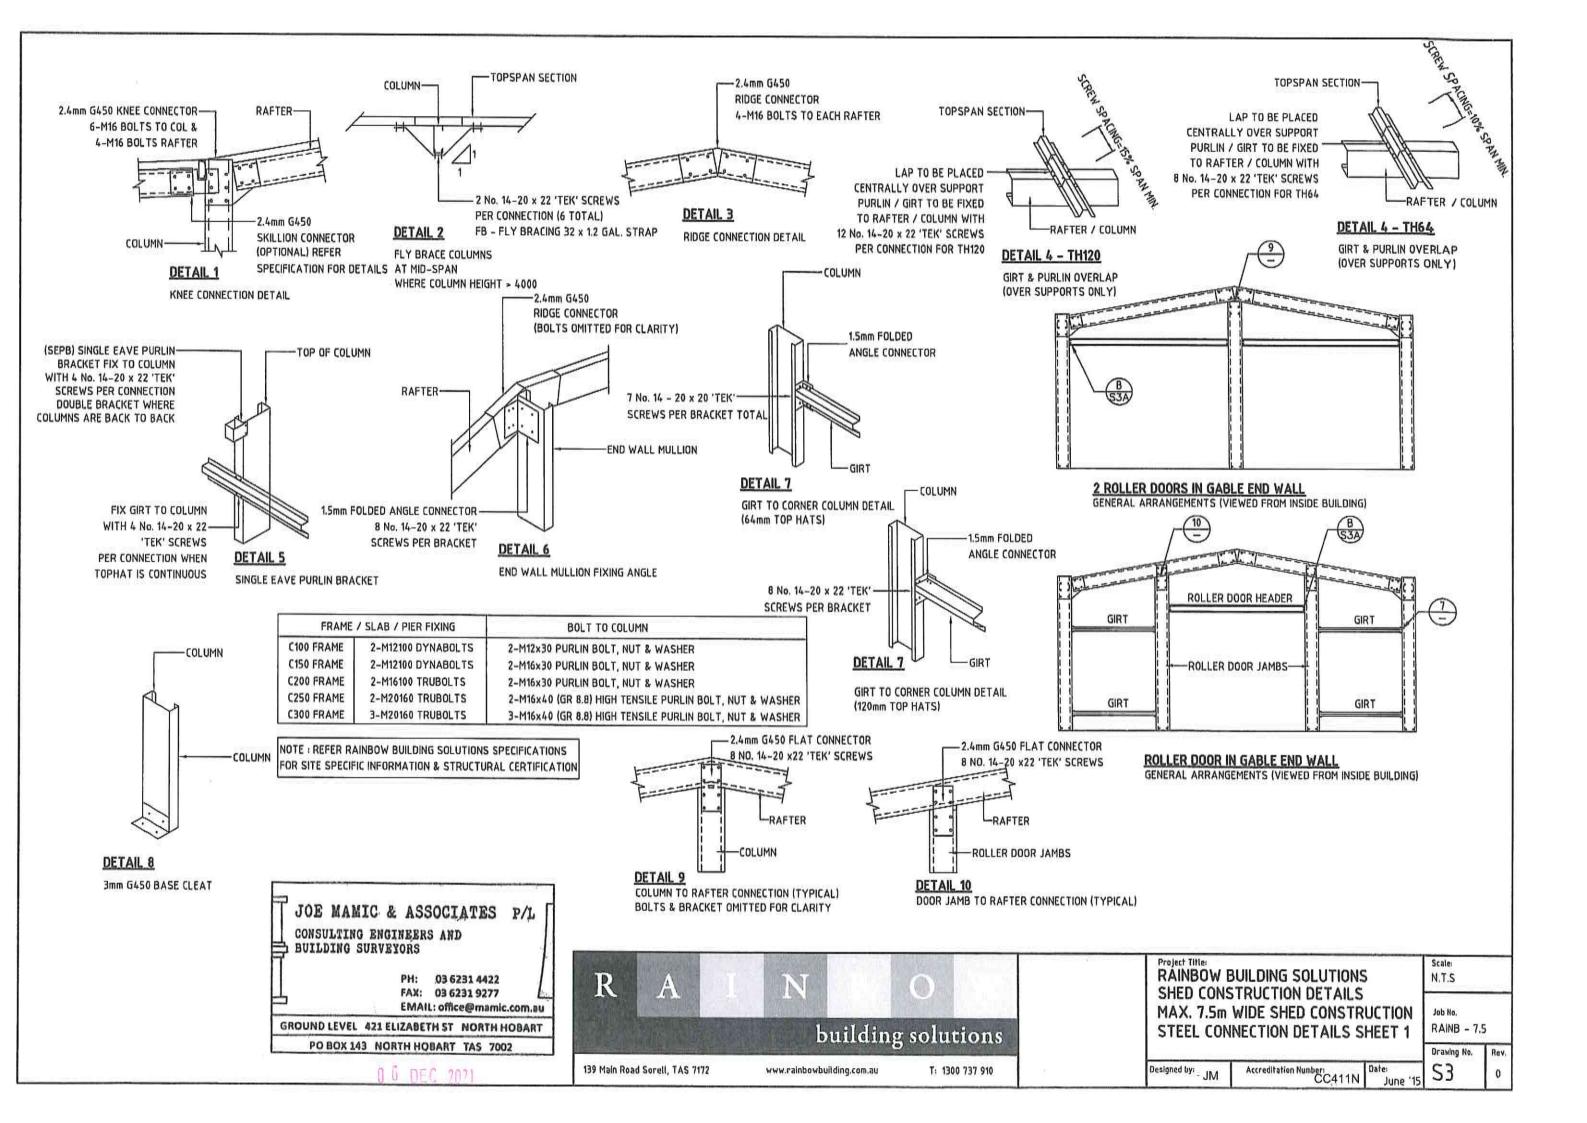

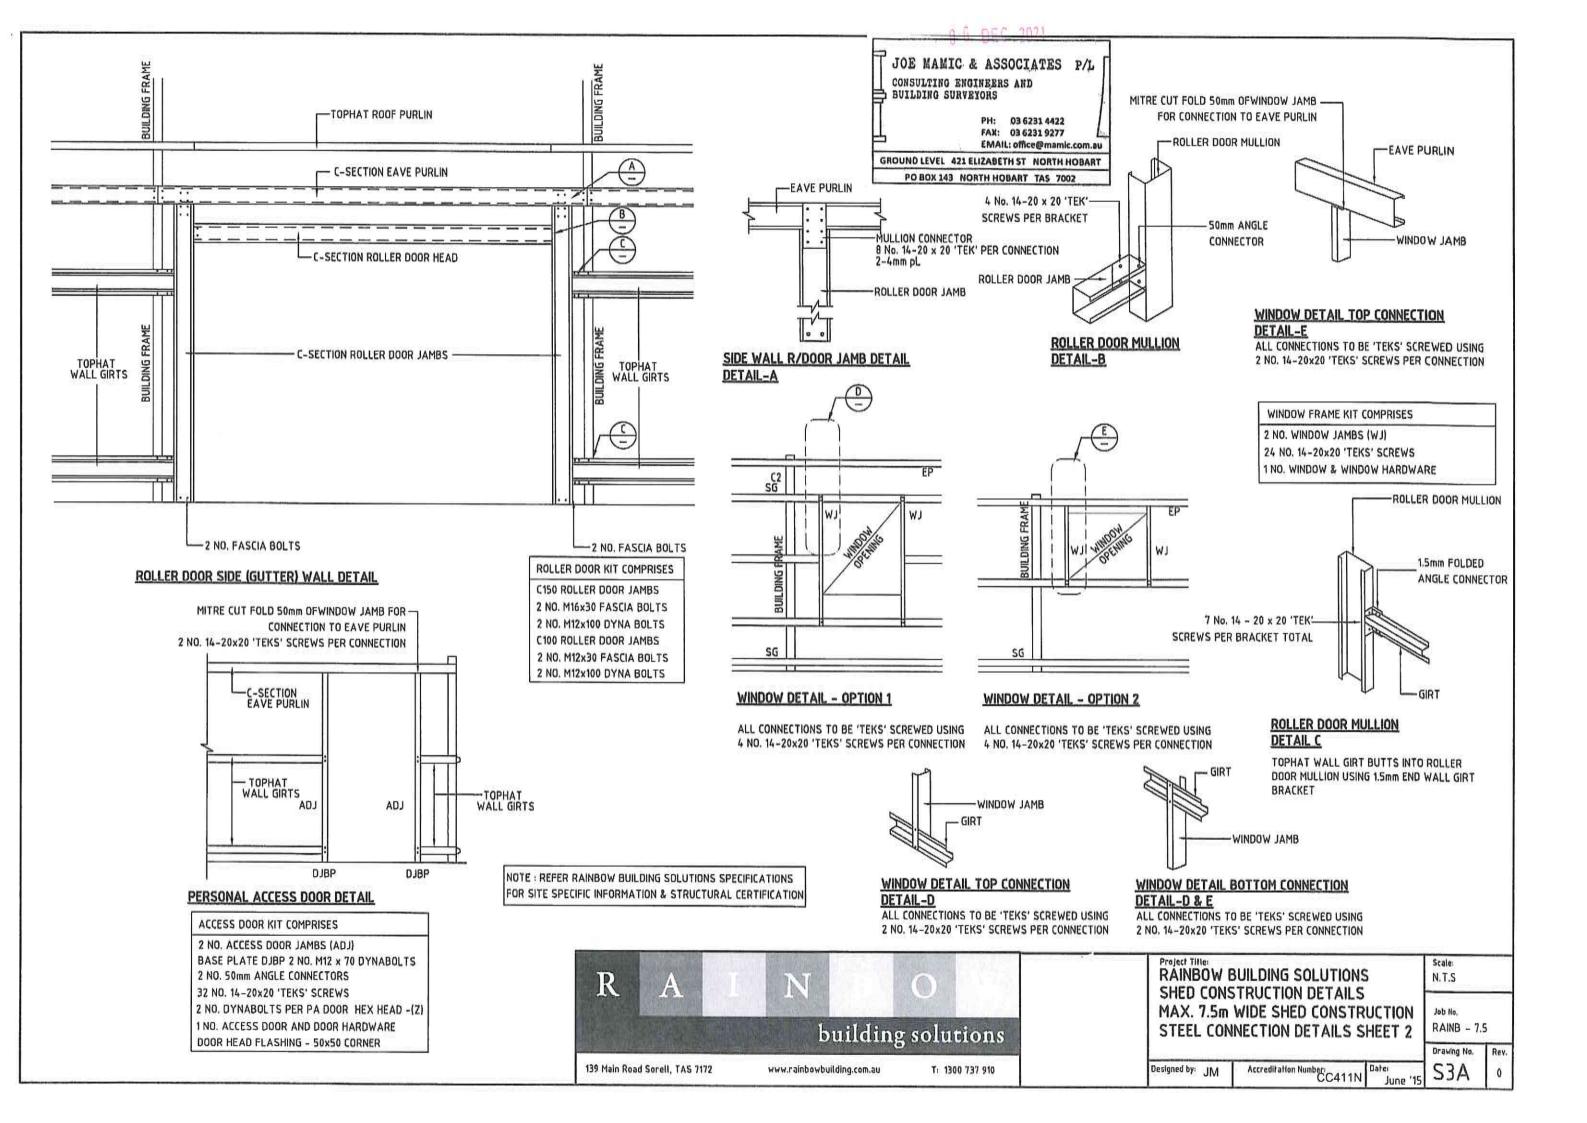

# CERTIFICATE OF THE RESPONSIBLE DESIGNER

Section 94 Section 106 Section 129 Section 155

То:	Nicole Ruff			Owner name	0.5
	Lot 1 Tunbridge Tier Ro	ad		Address	Form <b>35</b>
	Interlaken Tas.	Suburb/postcode			
Designer detail	s:				
Name:	Joe Mamic			Category:	Engineer
Business name:	Joe Mamic & Associates	s Pty Ltd		Phone No:	03 6231 4422
Business address:	PO Box 143				
	North Hobart Tas.	70	002	Fax No:	
Licence No:	CC411N Email ac	dress: office	e@mar	mic.com.au	
Details of the p	roposed work:				
Owner/Applicant	Nicole Ruff			Designer's proje reference No.	ct KING01_4574
Address:	Lot 1 Tunbridge Tier Ro	ad		Lot No	
	Interlaken Tas.	70	030		
Type of work:	Building wo	rk X	F	Plumbing work	(X all applicable)
Description of wor				Ø.	(r, all opplioable)
Left LeanTo: 4.5	.5m x 7m x 3.8m Gable 5 m x 7m x 2.4m .5m x 7m x 2.4m	Shed		ad re- we sto on me	ow building / alteration / dition / repair / removal / erection ater / sewerage / ormwater / -site wastewater anagement system /
Description of the	Design Work (Scope, limitat	ions or excl	usions):		ckflow prevention / other)
Certificate Type:	Certificate		0.17401701120100	ponsible Prac	COMPANY AND ADDRESS OF THE STATE OF THE STAT
(T <sub>1</sub> ,T <sub>2</sub>	☐ Building design			hitect or Buildir	The state of the s
	X Structural design			ineer or Civil D	
	☐ Fire Safety design		Fire	Engineer	
	☐ Civil design		Civi	Engineer or C	Civil Designer
	☐ Hydraulic design		Buil	ding Services	Designer
	☐ Fire service design		Buil	ding Services	Designer
	☐ Electrical design		Buil	ding Services	Designer
	☐ Mechanical design		Buil	ding Service D	esigner
	□Plumbing design			mber-Certifier; signer or Engin	Architect, Building eer
	☐ Other (specify)				
Deemed-to-Satisfy:	X	Performance	e Solutio	on: 🔲 (×th	e appropriate box)

Slab Design suitable for Class A, S & M sites only. Site soil Classification to AS 2870 by others Design documents provided: The following documents are provided with this Certificate -Document description: Drawing numbers: S1, S2, S3, S3A Prepared by: Joe Mamic Date: December 2021 Schedules: Prepared by: Date: Specifications: Report Prepared by: Joe Mamic Date: December 2021 Computations: Prepared by: Date: Performance solution proposals: Prepared by: Date: Test reports: Prepared by: Date: Standards, codes or guidelines relied on in design process: AS1170.1 AS1170.2, AS4100, AS4600, AS3600 Any other relevant documentation: NIL Attribution as designer: I Joe Mamic ...... am responsible for the design of that part of the work as described in this certificate: The documentation relating to the design includes sufficient information for the assessment of the work in accordance with the Building Act 2016 and sufficient detail for the builder or plumber to carry out the work in accordance with the documents and the Act: This certificate confirms compliance and is evidence of suitability of this design with the requirements of the National Construction Code. Name: (print) Signed Date Designer: Joe Mamic 06/12/2021 Licence No: CC411N

Other details:

Structural design of foundations, concrete slab and steel building frame.

All pier foundations must be excavated to approved natural sub-grade. Design BP 100kPa

Assessmen	t of Certifiable Works: (TasWate	er)	
Note: single res	sidential dwellings and outbuildings of to increase demand and are not certi	on a lot with an existing se	ewer connection are
If you cannot c	heck ALL of these boxes, LEAVE THIS	S SECTION BLANK.	
	then be contacted to determine if the		ifiable Works
I confirm that th	ne proposed works are not Certifiable Assessments, by virtue that all of the	Works, in accordance wit	The state of the s
The works	will not increase the demand for water s	upplied by TasWater	
The works or discharge	will not increase or decrease the amour ged into, TasWater's sewerage infrastruc	it of sewage or toxins that is sture	to be removed by,
The works made to Ta	will not require a new connection, or a n asWater's infrastructure	nodification to an existing co	onnection, to be
The works	will not damage or interfere with TasWa	ter's works	
The works	will not adversely affect TasWater's ope	erations	
The work a	re not within 2m of TasWater's infrastruc	cture and are outside any Ta	asWater easement
I have ched	cked the LISTMap to confirm the location	of TasWater infrastructure	
If the prope applied for	erty is connected to TasWater's water sy to TasWater.	stem, a water meter is in pla	ace, or has been
Certification			
satisfied that th	e works described above are not Certifia stry Act 2008, that I have answered the	able Works, as defined withi	n the Water and
read and under	stood the Guidelines for TasWater CCW	/ Assessments.	
Note: the Guid at: <u>www.taswa</u>	delines for TasWater Certification of ater.com.au	Certifiable Works Assess	ments are available
	Name: (print)	Signed	Date
Designer:	By Others		06/12/2021

Assessment of	f Certifiable Works: (TasWater)			
	ential dwellings and outbuildings on increase demand and are not certifia		n existing sewer co	onnection are
	k ALL of these boxes, LEAVE THIS S		ANK.	
-	en be contacted to determine if the p			Works.
	proposed works are not Certifiable W sessments, by virtue that all of the fo			Guidelines for
The works wil	not increase the demand for water sup	oplied by Tas	Water	
	not increase or decrease the amount of into, TasWater's sewerage infrastructu	_	toxins that is to be	removed by,
	l not require a new connection, or a mo /ater's infrastructure	dification to	an existing connecti	on, to be
The works wil	not damage or interfere with TasWate	's works		
The works wil	not adversely affect TasWater's opera	ations		
The work are	not within 2m of TasWater's infrastructu	ire and are c	utside any TasWate	er easement
I have checke	d the LISTMap to confirm the location o	of TasWater i	nfrastructure	
If the property applied for to	is connected to TasWater's water systomater.	em, a water	meter is in place, or	has been
Certification:				
are not Certifiable answered the abo TasWater CCW A	ines for TasWater Certification of Ce	d Sewerage have read a	<i>Industry Act 2008,</i> the Industry Act 2008, the Industry Industry	hat I have Guidelines for
	Name: (print)		Signed	Date
Designer:	By others			

# CERTIFICATE OF THE RESPONSIBLE DESIGNER

Section 94 Section 106 Section 129 Section 155

To:	Nicole Ruff	Owner name	25			
	Lot 1 Tunbridge Tier Road	_ot 1 Tunbridge Tier Road			Form <b>35</b>	
	Interlaken, TAS	Suburb/postcode	е			
Designer detail	s:					
Name:	Rainbow Building Solutions			Category:	Designer	
Business name:	Rainbow Roofing & Garages	Pty Ltd		Phone No:	1300 737 910	
Business address:	139 Main Road					
	SORELL TAS		7172	Fax No:	(03) 6265 3144	
Licence No:	181916529 Email ad	ddress: sa	les@rainbo	owbuilding.com	n.au	
Details of the p	roposed work:					
Owner/Applicant	Nicole Ruff			Designer's proje reference No.	KING01_4574	
Address:	Lot 1 Tunbridge Tier Road			Lot No	):	
	Interlaken, TAS		7030			
Type of work:	Building wo	rk x		Plumbing work		
(X all applicable)						
Description of wor	rk:				ew building / alteration /	
Left LeanTo: 4.5	.5m x 7m x 3.8m Gable S m x 7m x 2.4m .5m x 7m x 2.4m	Shed		re w ste or m	Idition / repair / removal / -erection rater / sewerage / ormwater / n-site wastewater anagement system / ackflow prevention / other)	
Description of the	Design Work (Scope, limitation	tions or e	xclusions)	: (X all applicable	e certificates)	
Certificate Type:	Certificate		Re	sponsible Pra	ctitioner	
	☑ Building design			chitect or Building Designer		
	☐ Structural design			gineer or Civil [	Designer	
	☐ Fire Safety design			e Engineer	Obid Decimen	
	☐ Civil design☐ Hydraulic design			il Engineer or ( Iding Services		
	☐ Fire service design			Iding Services	<b>v</b>	
	☐ Electrical design			Iding Services		
	☐ Mechanical design			Iding Service [	<b>v</b>	
	☐ Plumbing design ☐ Plumber-Certifier; Architect, Build Designer or Engineer					
	☐ Other (specify)					
Deemed-to-Satisfy:	<b>7</b>	Perform	ance Soluti	on: 🔲		
All pier foundations mus Slab Design suitable for Site Soil Classification to	idations, concrete slab and steel build t be excavated to approved natural su Class A, S & M sites only. o AS 2870 by others		sign BP 100kF	<sup>2</sup> a		

Design document	s provided	l:		
The following document Document description:	ts are provide	d with this Certificate	e —	
Drawing numbers:		Prepared by:		Date:
EE, SE, FPE, EFE, SF	E, CS, FP	Rainbow Roofing 8	& Garages Pty Ltd	3/12/2021
Schedules:		Prepared by:		Date:
Specifications:		Prepared by:		Date:
Computations:		Prepared by:		Date:
Performance solution p	oroposals:	Prepared by:		Date:
Test reports:		Prepared by:		Date:
Standards, codes process:	or guideli	nes relied on in	design	
AS1170.1, AS 1170.2,	AS 4100, AS	4600, AS 3600		
Any other relevan	t documer	ntation:		
Attribution on doc	ianor			
Attribution as des	_			
I Philip Smith am respon				
	ilding Act 201	6 and sufficient deta		e assessment of the work in mber to carry out the work in
This certificate confirms National Construction C		and is evidence of s	uitability of this design	with the requirements of the
	Nan	ne: (print)	Signed	Date
	ainbow Roo arages Pty	•	I mul	3/12/2021
Licence No: 18	81916529			
Cert No:				

Assessment of	Certifiable Works: (TasWater)					
710000011101111011	Toortinasio viorno. (Taoviator)					
	ential dwellings and outbuildings on increase demand and are not certifia		n existing sewer co	onnection are		
If you cannot chec	k ALL of these boxes, LEAVE THIS S	ECTION BI	_ANK.			
TasWater must the	n be contacted to determine if the p	oposed wo	rks are Certifiable	Works.		
	proposed works are not Certifiable W sessments, by virtue that all of the fo			Guidelines for		
The works will	not increase the demand for water sup	plied by Tas	sWater			
	not increase or decrease the amount of into, TasWater's sewerage infrastructure.	-	toxins that is to be	removed by,		
	not require a new connection, or a mo /ater's infrastructure	dification to	an existing connecti	on, to be		
The works will	not damage or interfere with TasWater	's works				
The works will	not adversely affect TasWater's opera	tions				
The work are	not within 2m of TasWater's infrastructu	re and are o	outside any TasWate	er easement		
I have checke	d the LISTMap to confirm the location o	of TasWater	infrastructure			
If the property applied for to	is connected to TasWater's water syste TasWater.	em, a water	meter is in place, or	has been		
Certification:						
I Philip Smith bein not Certifiable Wo the above question CCW Assessment	ines for TasWater Certification of Ce	werage Indu and unders	ustry Act 2008, that tood the Guidelines	I have answered for TasWater		
Name: (print) Signed Date						
Designer:	By others					
		1				



#### **GEO-ENVIRONMENTAL ASSESSMENT**

# Lot 1 Tunbridge Tier Road Interlaken June 2021



Disclaimer: The author does not warrant the information contained in this document is free from errors or omissions. The author shall not in any way be liable for any loss, damage or injury suffered by the User consequent upon, or incidental to, the existence of errors in the information.

#### Introduction

Client: Nicole Ruff

Date of inspection: 28/5/2021

**Location:** Lot 1 Tunbridge Tier Rd, Interlaken (CT:168930/1

Land description:Approx. 180ha lotBuilding type:Proposed dwellingInvestigation:AMS PowerProbe

**Inspected by:** A. Plummer

# **Background information**

Map: Mineral Resources Tasmania, 1:250 000

**Rock type:** Jurassic dolerite

**Soil depth:** 1.5 - 2m +

Planning overlays: Historic Heritage, Waterway and Coastal Protection Area

**Local meteorology:** Annual rainfall approx. 700mm

**Local services:** Tank water with onsite wastewater

# **Site conditions**

**Slope and aspect:** Approx 2-3% slope to the North West

**Site drainage:** Moderately well drained

**Vegetation:** Mixed native species

Weather conditions: Cloudy, approx. 10mm rainfall received in preceding 7 days.

**Ground surface:** Slightly moist surface conditions

# Investigation

A number of excavations were completed to identify the distribution of, and variation in soil materials on the site. A representative excavation at the approximate location indicated in the site plan was chosen for testing and classification according to AS2870-2011 and AS1547-2012 (see profile summary).

# Profile summary

Hole 1	Hole 2	Hole 3	Horizon	Description
Depth (m)	Depth (m)	Depth (m)		
0.0 – 0.30	0.0 – 0.30	0.0 – 0.30	A1	Dark Brown <b>CLAYEY SAND</b> ( <b>SC</b> ), single grain, slightly moist medium dense consistency, gradual boundary to
0.30 – 0.60	0.30 – 0.50	0.30 – 0.50	B21	Yellowish Brown CLAYEY SAND (SC), weak polyhedral structure, slightly moist medium dense consistency, gravels increasing with depth, gradual boundary to
0.60 – 1.50	0.50 – 0.80	0.50 – 2.0+	B22	Yellowish Brown <b>SANDY CLAY (CL)</b> , moderate polyhedral structure slightly moist stiff consistency, medium plasticity, gradual boundary to
	0.80 – 2.00		ВС	Brownish Yellow <b>SANDY SILT (ML)</b> , moist very stiff consistency, weathered rock

# Soil profile notes

Soils on the site have developed from Jurassic dolerite sediment and consist of gravelly and stony profiles dominated by clayey subsoils.

#### **Site Classification**

According to AS2870-2011 for construction the natural soil is classified as Class M, which is a moderately reactive site. Design and construction must be made in accordance with this classification.

#### Wind Classification

The AS 4055-2012 Wind load for Housing classification of the site is:

Region:  $\mathbf{A}$ 

Terrain category: TC2

NS Shielding Classification:

Topographic Classification: **T1** 

Wind Classification: **N3** 

Design Wind Gust Speed (V<sub>h,u</sub>) 50 m/sec

#### **Wastewater Classification & Recommendations**

According to AS1547-2012 (on-site waste-water management) the natural soil is classified as LIGHT CLAY (category 5). It is proposed to accommodate onsite wastewater using a dual-purpose septic tank with onsite absorption. A Design Loading Rate (DLR) of 7L/m<sup>2</sup>/day has therefore been assigned for primary treated effluent.

The proposed two-bedroom dwelling has a calculated maximum wastewater output of 480L/day. This is based on a tank water supply and a maximum occupancy of 5 people (120L/day/person).

Using the DLR of 7L/m<sup>2</sup>/day, an absorption area of at least 70m<sup>2</sup> will be required. This can be accommodated by two 20m x 1.8m x 0.6m absorption trenches connected to a dualpurpose septic tank (min 3000L) via a two-way splitter box to ensure equal distribution.

A cut-off drain will be required upslope of the application area to divert any surface water flows. A 100% reserve area must also be set aside and kept free from development for any future wastewater requirements. There is sufficient space available onsite to accommodate the required reserve due to the large property size (approx. 170ha). Therefore, a formal reserve area has not been assigned.

The following setback distances are required to comply with the Building Act 2016:

Upslope or level buildings: 3m Downslope buildings: 6m Upslope or level boundaries: 40m Downslope boundaries: 4m 29m Downslope surface water:

Compliance with Building Act 2016 Guidelines for On-site Wastewater Management Systems is outlined in the attached table.

The proposed onsite wastewater system will be located outside of the Waterway and Coastal Protection Area.

#### **Construction recommendations**

The natural soil is classified as **Class M**, which is a moderately reactive soil. All earthworks on site must comply with AS 3798-2007. Consideration is required to drainage and sediment control on site during and after construction.

During construction GES will need to be notified of any variation to the soil conditions or wastewater loading as outlined in this report.

Dr John Paul Cumming B.Agr.Sc (hons) PhD CPSS GAICD

Certified Professional Soil Scientist

#### GES P/L

#### Land suitability and system sizing for on-site wastewater management

Trench 3.0 (Australian Institute of Environmental Health)

#### Assessment Report

#### Site assessment for on-site waste water disposal

Assessment for Nicole Ruff Assess. Date 21-Jun-21

Ref. No.

Assessed site(s) Lot 1 Tunbridge Tier Rd Interlaken Site(s) inspected 24-May-21

Local authority Central Highlands Assessed by John Paul Cumming

This report summarises wastewater volumes, climatic inputs for the site, soil characteristics and sustem sizing and design issues. Site Capability and Environmental sensitivity issues are reported separately, where 'Alert' columns flag factors with high (A) or very high (AA) limitations which probably require special consideration for system design(s). Blank spaces on this page indicate data have not been entered into TRENCH.

#### **Wastewater Characteristics**

'astewater volume (L/day) used for this assessment = 480 (using the 'No. of bedrooms in a dwelling' method)

Septic tank was tewater volume (L/day) = 160

Sullage volume (L/day) = 320

Total nitrogen (kg/year) generated by wastewater = 4.3 otal phosphorus (kg/year) generated by wastewater = 1.8

#### Climatic assumptions for site

#### (Evapotranspiration calculated using the crop factor method)

	Jan	Feb	Mar	Apr	May	Jun	Jul	Aug	Sep	Oct	Nov	Dec
Mean rainfall (mm)	41	37	37	43	35	32	45	47	43	47	44	54
Adopted rainfall (R, mm)	41	37	37	43	35	32	45	47	43	47	44	54
Retained rain (Rr, mm)	37	33	33	39	32	29	41	42	39	42	40	49
Max. daily temp. (deg. C)												
Evapotrans (ET, mm)	130	110	91	63	42	29	32	42	63	84	105	126
Evapotr. less rain (mm)	93	77	58	24	11	1	-9	0	24	42	65	77

Annual evapotranspiration less retained rain (mm) = 463

#### Soil characterisitics

Texture = Light clay Category = 5 Thick. (m) = 2

Adopted permeability (m/day) = 0.24Adopted LTAR (L/sq m/day) = 7 Min depth (m) to water = 5

#### Proposed disposal and treatment methods

Proportion of wastewater to be retained on site: All wastewater will be disposed of on the site

The preferred method of on-site primary treatment: In dual purpose septic tank(s)

The preferred method of on-site secondary treatment: In-ground Trench(es) The preferred type of in-ground secondary treatment: The preferred type of above-ground secondary treatment: None

Site modifications or specific designs: Not needed

#### Suggested dimensions for on-site secondary treatment system

Total length (m) = 39

Width (m) =1.8

Depth (m) = 0.6

Total disposal area (sq m) required = 70

70 comprising a Primary Area (sq m) of:

and a Secondary (backup) Area (sq m) of:

Sufficient area is available on site

To enter comments, click on the line below 'Comments'. (This yellow-shaded box and the buttons on this page will not be printed.)

#### Comments

The calculated DLR for the category 5 soil present is 7L/sq m/day. An absorption area of at least 70sq m will be required. Therefore the system should have the capacity to cope with predicted climatic and loading events.

24-May-21

#### **GES P/L**

#### Land suitability and system sizing for on-site wastewater management Trench 3.0 (Australian Institute of Environmental Health)

# Site Capability Report

#### Site assessment for on-site waste water disposal

Assessment for Nicole Ruff Assess. Date 21-Jun-21 Ref. No.

Assessed site(s) Lot 1 Tunbridge Tier Rd Interlaken Site(s) inspected

Local authority Central Highlands Assessed by John Paul Cumming

This report summarises data relating to the physical capability of the assessed site(s) to accept wastewater. Environmental sensitivity and system design issues are reported separately. The 'Alert' column flags factors with high (A) or very high (AA) site limitations which probably require special consideration in site acceptability or for system design(s). Blank spaces indicate data have not been entered into TRENCH.

				Confid		tation	
Alert	Factor	Units	Value	level	Trench	Amended	Remarks
	Expected design area	sq m	5,000	V. high	Very low		
	Density of disposal systems	/sq km	1	Mod.	Very low		
	Slope angle	degrees	2	High	Very low		
	Slope form	Straight si	mple	High	Low		
	Surface drainage	lmp	erfect	High	Moderate		
	Flood potential Site	floods <1:10	00 yrs	High	Very low		
	Heavy rain events	Infre	quent	High	Moderate		
	Aspect (Southern hemi.)	Faces NE c	or NW	V. high	Low		
	Frequency of strong winds	Com	nmon	High	Low		
	Wastewater volume	L/day	480	High	Low		
	SAR of septic tank effluent		1.4	High	Low		
	SAR of sullage		2.5	High	Moderate		
	Soil thickness	m	2.0	V. high	Very low		
	Depth to bedrock	m	2.0	V. high	Low		
	Surface rock outcrop	%	0	V. high	Very low		
	Cobbles in soil	%	0	V. high	Very low		
	Soil pH		5.5	High	Low		
	Soil bulk density gn	n/cub. cm	1.5	High	Low		
	Soil dispersion Eme	erson No.	8	V. high	Very low		
	Adopted permeability	m/day	0.24	Mod.	Very low		
	Long Term Accept. Rate L	/day/sq m	7	High	Moderate		

To enter comments, click on the line below 'Comments'. (This yellow-shaded box and the buttons on this page will not be printed.)

#### Comments

The site has the capability to accept onsitre wastewater.

#### **GES P/L**

Land suitability and system sizing for on-site wastewater management Trench 3.0 (Australian Institute of Environmental Health)

#### **Environmental Sensitivity Report** Site assessment for on-site waste water disposal

Assessment for Nicole Ruff Assess. Date 21-Jun-21

Ref. No.

Assessed site(s) Lot 1 Tunbridge Tier Rd Interlaken Site(s) inspected 24-May-21

Local authority Central Highlands Assessed by John Paul Cumming

This report summarises data relating to the environmental sensitivity of the assessed site(s) in relation to applied wastewater. Physical capability and system design issues are reported separately. The 'Alert' column flags factors with high (A) or very high (AA) limitations which probably require special consideration in site acceptability or for system design(s). Blank spaces indicate data have not been entered into TRENCH.

				Confid	Limi	tation	
Alert	Factor	Jnits	Value	level	Trench	Amended	Remarks
	Cation exchange capacity mmol	/100g	75	High	Moderate		
	Phos. adsorp. capacity kg/d	cub m	0.6	High	Moderate		
	Annual rainfall excess	mm	-463	High	Very low		
	Min. depth to water table	m	5	High	Very low		
	Annual nutrient load	kg	6.1	High	Low		
	G'water environ. value Agri	ic non-s	ensit	V. high	Low		
	Min. separation dist. required	m	2	High	Very low		
	Risk to adjacent bores	Ver	y low	V. high	Very low		
	Surf. water env. value Agri	ic non-s	ensit	V. high	Low		
AA	Dist. to nearest surface water	m	50	V. high	Very high		
	Dist. to nearest other feature	m	50	V. high	Moderate		
	Risk of slope instability	Ver	y low	V. high	Very low		
	Distance to landslip	m	200	V. high	Low		

To enter comments, click on the line below 'Comments'. (This yellow-shaded box and the buttons on this page will not be printed.)

Comments

Acceptable Solutions	Performance Criteria	Compliance
A1  Horizontal separation distance from a building to a land application area must comply with one of the following:  a) be no less than 6m; or b) be no less than:  (i) 3m from an upslope building or level building;  (ii) If primary treated effluent to be no less than 4m plus 1m for every degree of average gradient from a downslope building;  (iii) If secondary treated effluent and subsurface application, no less than 2m plus 0.25m for every degree of average gradient from a downslope building.	a) The land application area is located so that  (i) the risk of wastewater reducing the bearing capacity of a building's foundations is acceptably low.; and  (ii) is setback a sufficient distance from a downslope excavation around or under a building to prevent inadequately treated wastewater seeping out of that excavation	Complies with A1 (a) Land application area will be located with minimum separation distance to proposed building of 3m.
Horizontal separation distance from downslope surface water to a land application area must comply with (a) or (b)  (a) be no less than 100m; or  (b) be no less than the following:  (i) if primary treated effluent 15m plus 7m for every degree of average gradient to downslope surface water; or  (ii) if secondary treated effluent and subsurface application, 15m plus 2m for every degree of average gradient to down slope surface water.	Horizontal separation distance from downslope surface water to a land application area must comply with all of the following:  a) Setbacks must be consistent with AS/NZS 1547 Appendix R;  b) A risk assessment in accordance with Appendix A of AS/NZS 1547 has been completed that demonstrates that the risk is acceptable.	Complies with A2 (b) (i) Land application area located 40m from downslope surface water (29m required)

A3	P3	
Horizontal separation distance from a property boundary to a land application area must comply with either of the following:  (a) be no less than 40m from a property boundary; or  (b) be no less than:  (i) 1.5m from an upslope or level property boundary; and  (ii) If primary treated effluent 2m for every degree of average gradient from a downslope property boundary; or  (iii) If secondary treated effluent and subsurface	Horizontal separation distance from a property boundary to a land application area must comply with all of the following:  (a) Setback must be consistent with AS/NZS 1547 Appendix R; and  (b) A risk assessment in accordance with Appendix A of AS/NZS 1547 has been completed that demonstrates that the risk is acceptable.	Complies with A3 (b) (i) Land application area will be located with a minimum separation distance of 1.5m from an upslope or level property boundary  Complies with A3 (b) (ii) Land application area will be located with a minimum separation distance of 40m of downslope property boundary (4m required)
application, 1.5m plus 1m for every degree of average gradient from a downslope property boundary.	D4	
Horizontal separation distance from a downslope bore, well or similar water supply to a land application area must be no less than 50m and not be within the zone of influence of the bore whether up or down gradient.	P4 Horizontal separation distance from a downslope bore, well or similar water supply to a land application area must comply with all of the following:  (a) Setback must be consistent with AS/NZS 1547 Appendix R; and  (b) A risk assessment completed in accordance with Appendix A of AS/NZS 1547 demonstrates that the risk is acceptable	Complies with A4 No bore or well identified within 50m

Vertical separation distance between groundwater and a land application area must be no less than:  (a) 1.5m if primary treated effluent; or  (b) 0.6m if secondary treated effluent	P5 Vertical separation distance between groundwater and a land application area must comply with the following:  (a) Setback must be consistent with AS/NZS 1547 Appendix R; and  (b) A risk assessment completed in accordance with Appendix A of AS/NZS 1547 that demonstrates that the risk is acceptable	Complies with A5 (a)  No groundwater encountered
Vertical separation distance between a limiting layer and a land application area must be no less than:  (a) 1.5m if primary treated effluent; or  (b) 0.5m if secondary treated effluent	P6 Vertical setback must be consistent with AS/NZS1547 Appendix R.	Complies with A6 (a)  No limiting layer identified
A7 nil	P7 A wastewater treatment unit must be located a sufficient distance from buildings or neighbouring properties so that emissions (odour, noise or aerosols) from the unit do not create an environmental nuisance to the residents of those properties	Complies



#### AS1547:2012 – Loading Certificate – Septic System Design

This loading certificate sets out the design criteria and the limitations associated with use of the system.

**Site Address:** Lot 1 Tunbridge Tier Rd, Interlaken (CT 168930/1)

System Capacity: 4 people @ 120L/person/day

**Summary of Design Criteria** 

**DLR:**  $7L/m^2/day$ .

**Absorption area:** 70m<sup>2</sup>

**Reserve area location /use:** Not assigned – more than 100% available

Water saving features fitted: Standard fixtures

Allowable variation from design flows: 1 event @ 200% daily loading per quarter

**Typical loading change consequences:** Expected to be minimal due to capacity of system and site area (provided loading changes within 25% of design)

**Overloading consequences:** Continued overloading may cause hydraulic failure of the absorption area and require upgrading/extension of the area. Risk considered acceptable due to visible signs of overloading and owner monitoring.

**Underloading consequences:** Lower than expected flows will have minimal consequences on system operation unless the house has long periods of non occupation. Under such circumstances additional maintenance of the system may be required. Risk considered acceptable.

Lack of maintenance / monitoring consequences: Issues of underloading/overloading and condition of the absorption area require monitoring and maintenance, if not completed system failure may result in unacceptable health and environmental risks. Septic tank de-sludging must also be monitored to prevent excessive sludge and scum accumulation. Monitoring and regulation by the property owner required to ensure compliance.

Other operational considerations: Owners/occupiers must be aware of the operational requirements and limitations of the system, including the following; the absorption area must not be subject to traffic by vehicles or heavy stock and should be fenced if required. The absorption area must be kept with adequate grass cover to assist in evapotranspiration of treated effluent in the absorption trenches. The septic tank must be desludged at least every 3 years, and any other infrastructure such as septic tank outlet filters must also be cleaned regularly (approx. every 6 months depending upon usage). Foreign materials such as rubbish and solid waste must be kept out of the system.

# CERTIFICATE OF QUALIFIED PERSON – ASSESSABLE ITEM

Section 321

To:	Nicole Ruff		Owner /Agent	EE			
	30 Brady Street	Address	Form <b>55</b>				
	Midway Point	7171	Suburb/postcode				
Qualified perso	on details:						
Qualified person:	John-Paul Cumming						
Address:	29 Kirksway Place		Phone No:	03 6223 1839			
	Battery Point	7004	Fax No:				
Licence No:	AO999 Email address:	jcummir	g@geosolutio	ons.net.au			
Qualifications and Insurance details:	Certified Professional Soil Scientist (CPSS stage 2)	ctor's Determination	ription from Column 3 of the tor's Determination - Certificates valified Persons for Assessable				
Speciality area of expertise:	AS2870-2011 Foundation Classification	I Direc					
Details of work	:						
Address:	Lot 1 Tunbridge Tier Road			Lot No:			
	Interlaken	7030	Certificate of	f title No: 168930/1			
The assessable item related to this certificate:	Classification of foundation Con according to AS2870-2011	certified) Assessable item - a material; - a design - a form of co - a document - testing of a system or p	onstruction				
Certificate deta	ils:						
Certificate type: Foundation Classification  (description from Column 1 of Schedule 1 of the Director's Determination - Certificates by Qualified Persons for Assessable Items n)							
This certificate is in	This certificate is in relation to the above assessable item, at any stage, as part of - (tick one)						
building work, plumbing work or plumbing installation or demolition work							
or a building, temporary structure or plumbing installation: □							

In issuing this certificate the following matters are relevant –

Documents: The attached soil report for the address detailed above in 'details of

Work'

Relevant

calculations: Reference the above report.

References: AS2870-2011 residential slabs and footings

AS1726-2017 Geotechnical site investigations

CSIRO Building technology file - 18.

Substance of Certificate: (what it is that is being certified)

Site Classification consistent with AS2870-2011.

#### Scope and/or Limitations

The classification applies to the site as inspected and does not account for future alteration to foundation conditions as a result of earth works, drainage condition changes or variations in site maintenance.

#### I, John-Paul Cumming certify the matters described in this certificate.

Qualified person:

Signed:

Certificate No:

Date:

21/06/2021

J3437



# **CERTIFICATE OF THE RESPONSIBLE DESIGNER**

Section 94 Section 106 Section 129 Section 155

To:	: Nicole Ruff			Owner name	25		
	30 Brady Street				Address	Form <b>35</b>	
	Midway Point		717 <sup>-</sup>	1	Suburb/postcode		
	<u> </u>		J L				
Designer detail	S:						
Name:	John-Paul Cumming				Category:	Bld. Srvcs. Dsgnr Hydraulic	
Business name:	Geo-Environmental Solutions	6			Phone No:	03 6223 1839	
Business address:	29 Kirksway Place						
	Battery Point		7004		Fax No:	N/A	
Licence No:	CC774A Email ac	ddress:	office@g	geos	olutions.net.au		
Details of the p	roposed work:						
					Designer's projec	rt 10.407	
Owner/Applicant	Nicole Ruff				reference No.	<sup>‡</sup> J3437	
Address:	Lot 1 Tunbridge Tier Roa	ad			Lot No:	168930/1	
	Interlaken		7030	0			
Type of work:	Building wo	rk 🗌		F	Plumbing work	X (X all applicable)	
Description of wor	rk: management system - design				/no	ew building / alteration /	
Description of the	Design Work (Scope, limitat	ions o	or exclusi	ons)	re- wa sto on- ma bad	dition / repair / removal / erection ater / sewerage / rmwater / site wastewater nagement system / ckflow prevention / other) certificates)	
Certificate Type:	Certificate				sponsible Prac		
,,,,,,,,,,,,,,,,,,,,,,,,,,,,,,,,,,,,,,,	☐ Building design			1	hitect or Buildin		
	☐ Structural design			Eng	gineer or Civil D	esigner	
	☐ Fire Safety design			Fire	Engineer		
	☐ Civil design			Civ	il Engineer or C	civil Designer	
				Bui	Building Services Designer		
	☐ Fire service design			Bui	uilding Services Designer		
	☐ Electrical design				Iding Services [		
	☐ Mechanical design				Iding Service D		
	☐ Plumbing design				mber-Certifier; <i>i</i> signer or Engin	Architect, Building eer	
	☐ Other (specify)			•			
Deemed-to-Satisfy:	×	Perfo	ormance S	Soluti	on: X the a	appropriate box)	
Other details:							
Dual-purpose seption	c tank with onsite absorption						
Design docume	ents provided:						

The following documents are provided with this Certificate – Document description: Drawing numbers: Date: Jun-21 Prepared by: Geo-Environmental Solutions Schedules: Prepared by: Date: Prepared by: Geo-Environmental Solutions Date: Jun-21 Specifications: Computations: Prepared by: Date: Performance solution proposals: Prepared by: Date: Prepared by: Geo-Environmental Solutions Test reports: Date: Jun-21 Standards, codes or guidelines relied on in design process: AS1547-2012 On-site domestic wastewater management. AS3500 (Parts 0-5)-2013 Plumbing and drainage set. Any other relevant documentation: Geo-Environmental Assessment - Lot 1 Tunbridge Tier Road, Interlaken - Jun-21

Geo-Environmental Assessment - Lot 1 Tunbridge Tier Road, Interlaken - Jun-21

#### Attribution as designer:

I John-Paul Cumming, am responsible for the design of that part of the work as described in this certificate;

The documentation relating to the design includes sufficient information for the assessment of the work in accordance with the Building Act 2016 and sufficient detail for the builder or plumber to carry out the work in accordance with the documents and the Act;

This certificate confirms compliance and is evidence of suitability of this design with the requirements of the National Construction Code.

	Name: (print)	Signed	Date
Designer:	John-Paul Cumming		21/06/2021
Licence No:	CC774A		

#### **Assessment of Certifiable Works: (TasWater)**

Note: single residential dwellings and outbuildings on a lot with an existing sewer connection are not considered to increase demand and are not certifiable.

If you cannot check ALL of these boxes, LEAVE THIS SECTION BLANK.

TasWater must then be contacted to determine if the proposed works are Certifiable Works.

I confirm that the proposed works are not Certifiable Works, in accordance with the Guidelines for TasWater CCW Assessments, by virtue that all of the following are satisfied:

	, ,
Х	The works will not increase the demand for water supplied by TasWater
Х	The works will not increase or decrease the amount of sewage or toxins that is to be removed by or discharged into, TasWater's sewerage infrastructure
Х	The works will not require a new connection, or a modification to an existing connection, to be made to TasWater's infrastructure
Х	The works will not damage or interfere with TasWater's works
Х	The works will not adversely affect TasWater's operations
Х	The work are not within 2m of TasWater's infrastructure and are outside any TasWater easemen
Х	I have checked the LISTMap to confirm the location of TasWater infrastructure
х	If the property is connected to TasWater's water system, a water meter is in place, or has been

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applied for to TasWater.

I ......... John-Paul Cumming....... being responsible for the proposed work, am satisfied that the works described above are not Certifiable Works, as defined within the *Water and Sewerage Industry Act 2008*, that I have answered the above questions with all due diligence and have read and understood the Guidelines for TasWater CCW Assessments.

Note: the Guidelines for TasWater Certification of Certifiable Works Assessments are available at: <a href="https://www.taswater.com.au">www.taswater.com.au</a>

Designer:

John-Paul Cumming

Name: (print)

Signed

Date

21/06/2021



#### Wastewater system:

Dual-purpose septic tank (min 3000L)

Cut-off drain Two-way splitter box

Absorption Trenches 2 x 20m x 1.8m x 0.6m

Min 3m separation

Min 3m from upslope or level buildings
Min 6m from downslope buildings
Min 1.5m from upslope or level boundaries
Min 4m from downslope boundaries
Min 29m from downslope surface water

Refer to GES report

## SITE DATA:

LAND TITLE REF. No. : LOT 1 ON SEALED PLAN 168930

CLIMATE ZONE : ASSUMED ZONE 7

DESIGN WIND SPEED : T.B.A. SOIL CLASSIFICATION : T.B.A.

BAL RATING : BAL-12.5 T.B.C.


#### **BUILDING AREAS:**

EXISTING DWELLING : 000.0m² EXISTING SHED : 00.0m²

TOTAL : 000.0m²

#### SITE COVERAGE:

LOT SIZE : 0000m²
TOTAL FOOTPRINT : 000.0m²
SITE COVERAGE : 0.00%

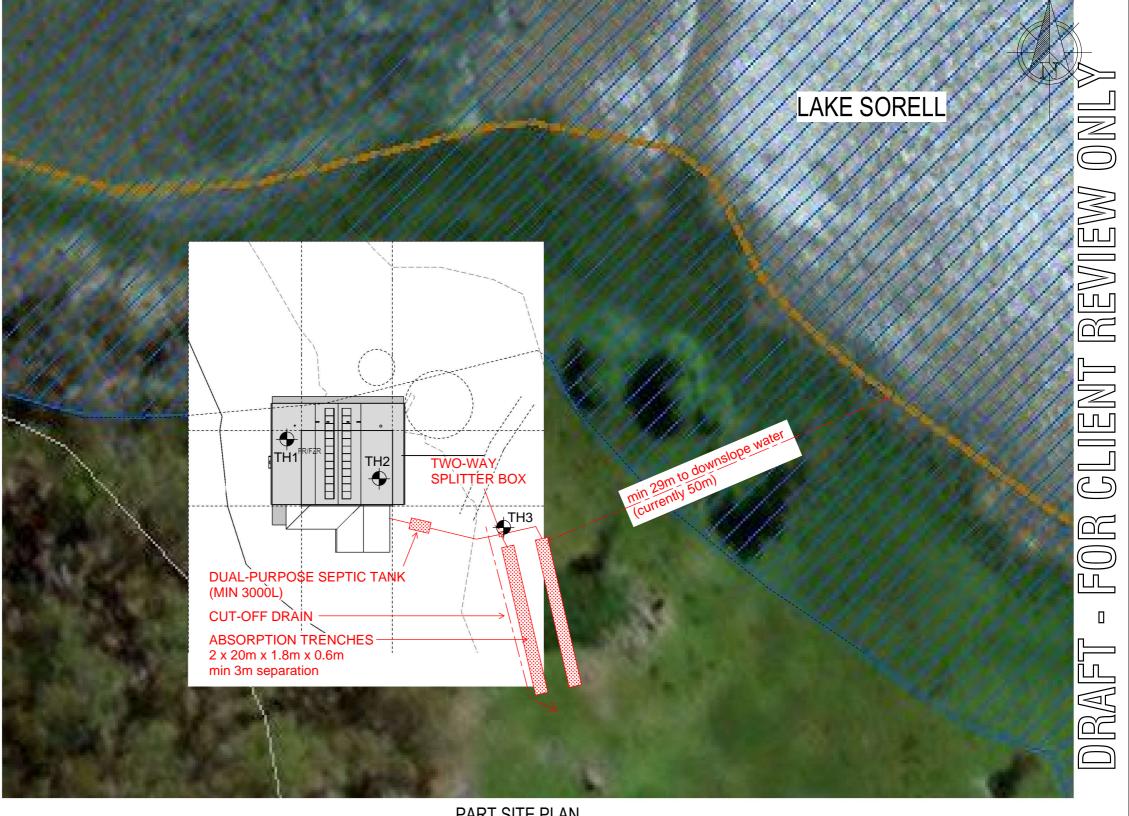

# PRELIMINARY

2

PART SITE PLAN
SCALE 1:500 @ A3




REV.	DESCRIPTION	REFERENCE	DESIGNED	Designer	OMERICEO DRAFTINO DEVITO	CLIENT Owner
0	ISSUED FOR CLIENT FOR REVIEW. 00-00-0000	SHEET TITLE 000-CLIENT	DRAWN	Author	SMEEKES DRAFTING PTY LTD	Project Name
			CHECKED	Checker	ABN 89 056 706 640	Enter address here
			4		12 Warwick Street, Hobart, TAS 7000	Liller address riere
				alala	Office Phone: (03) 6234 6185	0
					Email: admin@smeekesdrafting.com	SITE PLAN
			BUILDI	NG DESIGNERS	Website: www.smeekesdrafting.com	SHT. A03 SCALE A3
			ASSOCIA	TION OF AUSTRALIA	Building Designer Licence Nos. 723026951, 619068752 & CC6621	

#### **Design notes:**

- 1. Absorption trench dimensions of up to 20m long by 0.60m deep by 1.8m wide total storage volume calculated at average 35% porosity.
- 2.Base of trenches to be excavated level and smearing and compaction avoided.
- 3.350-410mm Arch should be placed in the centre of trench
- 4. Geotextile or filter cloth to be placed over the distribution arch to prevent clogging
- 5.Construction on slopes up to 10% to allow trench depth range 650mm upslope edge to 450mm on down slope edge
- 6.Dispersive soils gypsum to be incorporated into the base of the trench at a rate of 1kg/m<sup>2</sup>
- 7.All works on site to comply with AS3500 and Tasmanian Plumbing code.



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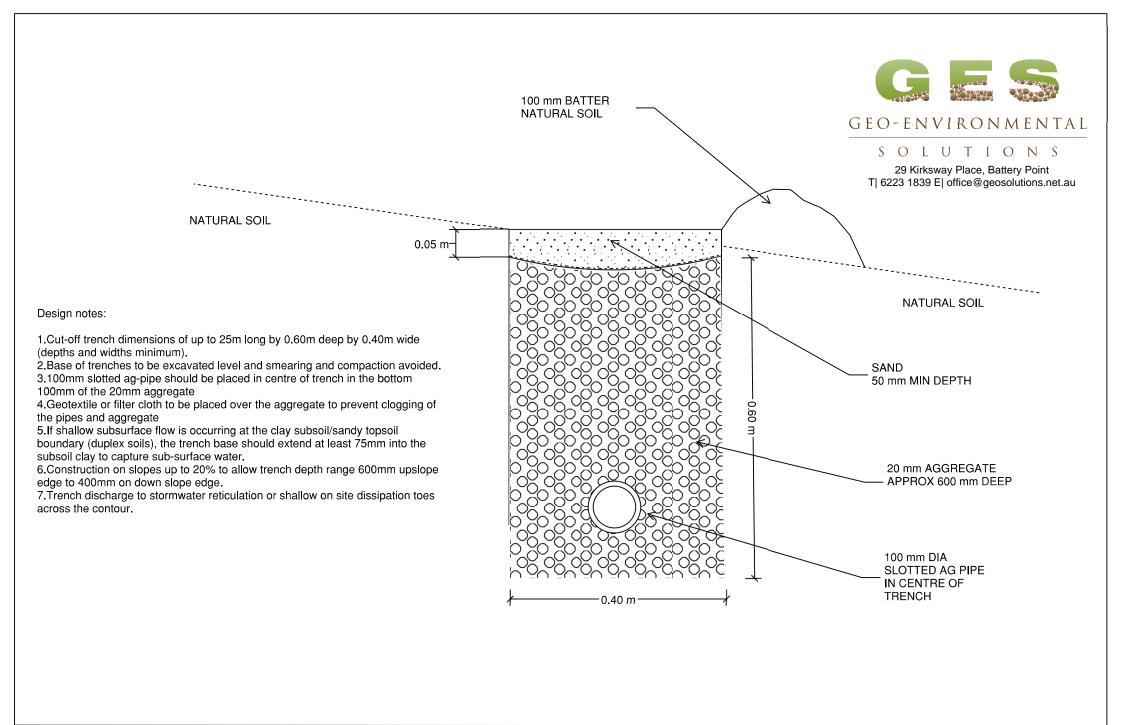
Do not scale from these drawings.
Dimensions to take precedence
over scale.

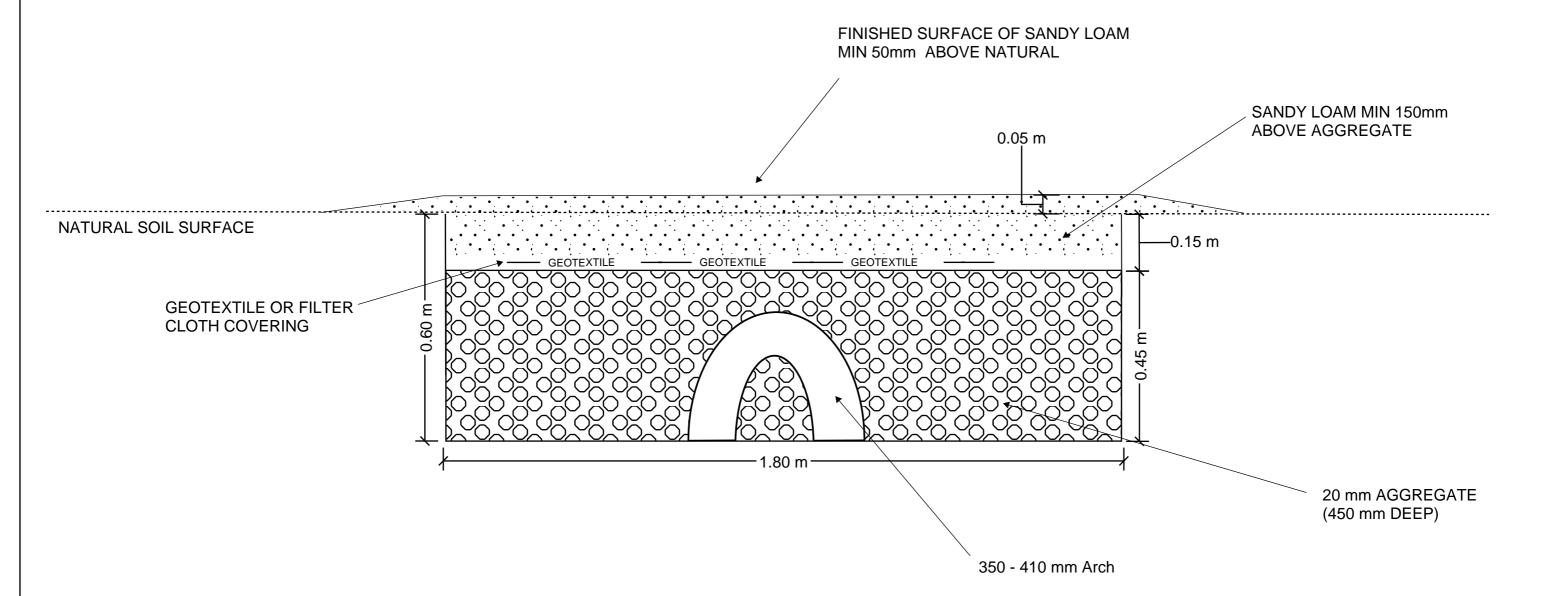Geo-Environmental Solutions

Date: Jun 2020

Terraced Absorption Trench Detail

Sheet 1 of 1



Do not scale from these drawings.
Dimensions to take precedence
over scale.