
Attachment A

Youth Services Center Gymnasium and Courtyard Construction Documents dated October 12, 2015

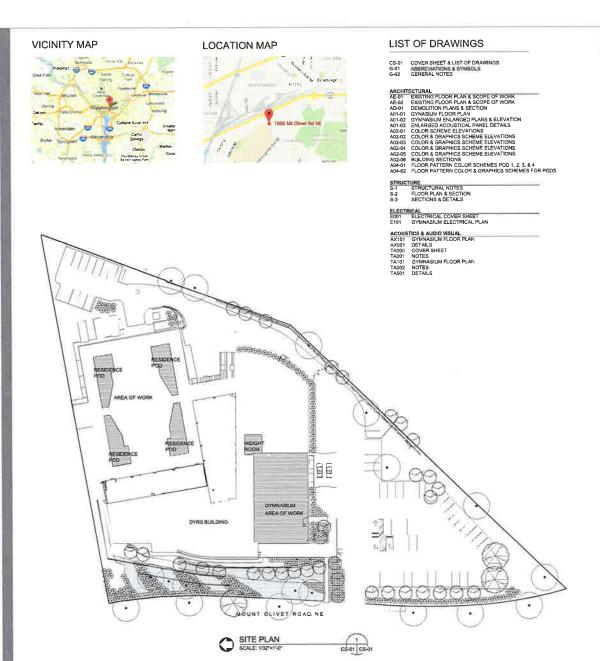

YOUTH SERVICES CENTER GYMNASIUM RENOVATION

1000 MOUNT OLIVET ROAD, NE WASHINGTON, DC 20002

CONSTRUCTION DOCUMENTS

OCTOBER 12, 2015

PROJECT TEAM

DGS

DEPARTMENT OF GENERAL SERVICES (DGS)

1250 U STREET, NW, 4TH FLOOR
WASHINGTON DO 20099

Acettot

LANCE BAILEY & ASSOCIATES, INC.

WASHINGTON DC 20012 T: (301) 505-2280 F: (301) 505-2287 www.lancattoley.com

STRUCTURAL ENGINEER

MGV

T. 101-814-046 F; 201-816-0848

GES

GLOBAL ENGINEERING SOLUTION

WASHINGTON DC 20015 11: (707) 495-7746 F1 (707) 495-7747 CIVIA, ENGINEERING

AMT LLC

10 G 5 Negt1 Ne 54/16 F 43/0

WASHINGTON DC 2003)

T. SHOU 280/255 F (2013) 395-605

POLYSONICS

AGGINELLE BINLANE
WARRANTON VA 2018
T (SAD)SHIMBE F; (SAC)SHIMBE

SHEET TITTLE

COVER SHEET & LIST OF DRAWINGS

PROJECT NO

SUBMISSION DATE

SHEET NO

DATE OF ORIGIN: MAY 30, 2015

CS-01

ABBREVIATION

ABOVE FINISH FLOOR	AFF	DEP
ACCOMODATE	ACCOM_	DET
ACCOUSTICAL	AC.	DIAA
ACCOUSTICAL TILE	AT.	DIME
ADJUSTTABLE	ADJ.	DOV
ADJACENT	ADJ.	DOV
ALTERNATE	ALT. ALUM	DRA
ALUMINUM ANCHOR BOLT	AB	DRA
AND	å	Drox
ANGLE	î.	EAS
APPROXIMATE	APPROX	EAC
ARCHITECT	ARCHT	ELE
AREA DRAIN	AD	ELE
ASBESTOS	ASB	ELE
ASPHALT	ASPH	EMP
ASSISTANT	ASSIST	EQU
ASSOCIATE	ASSOC	EQU
AT	@	EXH
ni e	6	EXIS
BASEMENT	BSMT	EXP
BATHROOM	8	EXP
BEAM	BM	EXT
BEARING	BRNG	EXT
BED ROOM	BR.	
BEYOND	BYND.	
BITUMINOUS	BIT.	FAC
BLOCK	BLK	FAC
BLOCKING	BLKG	FAC
BOARD	BD,	FAC
BOLTS	BT.	FINI
BOTTOM	BOT_	FIRE
BOTTOM OF WALL	BW.	FIRE
BRICK	BRK	FIRE
BUILDING	BLDG	FIXT
		FLA
CABINET	CAB	FLO
CAULKING	CLKG_	FLO
CEILING	CLNG.	FOO
CEILING SPACE	C S	FOO
CENTER LINE	CL	FOL
CENTER TO CENTER	CC.	FRE
CERAMIC	CER	FRE
CERAMIC TILE	CT.	FUR
CHANNEL		
CLEAR	CLR	GAL
CLOSET	C/CL	GEN
COLUMN	COL	GLA
COMMUNICATION	COMM	GRA
CONCRETE	CONC_	GYF
CONCRETE MASONRY UNIT	CMU	GYF
CONDITION	COND	
CONSTRUCTION	CONST	HAF
CONTINUOUS	CONT	HAH
	CONTR	HIG
CONTRACTOR		HEI
CONTROL JOINT	C)	
CONTROL JOINT COOLER	CLR.	HOL
CONTROL JOINT		

DPT DET DEIN, DR. DN. DS. DL. DWG. IENSION OR WN SPOUT AIN LEADER AWING EA ELECT CTRICAL CTRICAL WATER COOLER EWC. EL/ELEV. VATION EMP EQ EQUIP EXH EXIST PLOYEE HAUST STING EXP.BT. EJ. EXT. EIFS PANSION BOLT PANSION JOINT TERIOR TERIOR INSULATED FINISH FC. FF. FW. FIN. FE. FEC FP. FIX. FLABIO. FL. CE OF COLUMN CE OF FRAME CE OF MASONRY CE OF WALL CE OF WALL
VISHED
RE EXTINGUISHER
RE EXTINGUISHER CABINET E PROOFING TURE ASHING OOR OOR DRAIN OOR | FL |
OOR | FD |
OOR | FD |
OOT/FEET | FT |
OOTING | FTG |
UNDATION | FON |
EE AIR | FA |
REEZER | FAZR |
RRNITURE/FIXTURE/EQUIPMENT | FI/E ALVANIZED ENERAL .ASS RADE GALV. GEN. GL. GD. PSUM GYP. PSUM WALL BOARD GWB. ARDWARE ANDICAPPED HDW. HC. HP. HGT. HM. HORIZ HR H POINT DLLOW METAL DRIZONTAL

INCL INFO IRGB INCLUDED INFORMATION IMPACT RESISTANT GYPSUM INSIDE DIAMETER/DIMENSION INSUL INT JANITOR'S CLOSET JUNCTION

JC JT JCT KITCHEN KITCHEN/LAUNDRY K, K/L LAVATORY LAV. LENGTH, LOUVER LIGHT LIGHT WEIGHT L LT LTWT LOCATION LOC LOCKERS LOC. LOW POINT LONG LEG VERTICAL LAMINATED VENEER LUMBER

MACHINE MANAGER MANUFACTURE/R MACH, MGR, MFR, MAS, MASONRY, MASON MAS MO MATL MAX MECH METAL MIN MISC. MB MASONRY OPENING MATERIAL MAXIMUM MECHANICAL METAL MINIMIIM MISCELLANEOUS NORTH N. NTC NOT TO CONTRACT

NOT TO SCALE NUMBER NTS NO# OFF. OFFICE ON CENTER
OPENING
OPPOSITE
ORIENTED STRAND BOARD OPP OPP OPP OSB OD OUTSIDE DIMENSION

PNT. PTD. PAINTED PAIR PARAPET PERCENT PR. PARA % PLAM, PLASTIC LAMINATED PLASTIC WALL COATING PWC. PL PLMB'G PLYWD PL GL PT PLATE PLYWOOD PLATE GLASS LBS POUNDS POUND PER SQUARE INCH PRECAST CONCRETE PROJECTION PSI PRE CONC PROJ

Q.T.

REF.

REQ,D. RF. R.D. RM. SCH.

UNO

SYMBOLS

QUARRY TILE RADIUS RECREATION REFRIGERATOR REINFORCING ROOF DRAIN ROOM SCHEDULE SECTION SHEET SHOWER SIMILAR

SECT. SHT. SHW. SIM. SOUTH SPECIFICATION SQUARE SQUARE FOOT/FEET SPEC. SQ. FT. SQUARE INCH SO. IN. START POINT OF THE CEILING STORAGE STRUC SURFACE SURF.

TELEPHONE THRESHOLD TEL THR, THRU THROUGH TILE/TOP TOLET
TOP OF CURB
TOP OF JOIST TOIL/T TC. TJST. TOP. TOS TOP OF PARAPET TOP OF STEEL TYPICAL

UNLESS NOTED OTHERWISE

VAPOR BARRIER VENTILATION/VENTILATOR VENDING MACHINES VERIFIED IN FIELD VERTICAL VESTIBULE VINYL COMPOSITE TILE WATER CLOSE WATER PROOF WEIGHT WEST/WITH WIDE FLANGE WITHOUT

VP. VENT. VEND MACH VEST VCT WC WP WT W

-DGS DGS (DEPARTMENT OF GENERAL SERVICES)

LANCE BAILEY & ASSOCIATES

(250 U STREET, NW., WASHINGTON, DC 20009

NORTHCH

STRUCTURN, ENGINEER MGV

CONSULTING STRUCTURAL ENGINEER 5256 EXECUTIVE BULLEVARD INCRETH RETHERDA, NO VERSIONED 1, 201415-0848 F (201416-0848) WHILP PROPERTY AND THE PROPERTY AND TH

ELECTRICAL ENGINEER

GES

GLOBAL ENGINEERING SOLUTION WASHINGTON DC 20015 T: (202) 485-7746 F: (202) 495-7747

CONT. ENGINEER AMT

10 G STREET, NE SUITE # 430 WASHINGTON DC 20092 T: (202) 289-4545 F: (202) 289-5051

ACQUISTICAL CONSULTANT POLYSONICS 405 BELLE AIR LANE WARRENTON VA 20188 T: (540) 341-4888 P: (540) 341-0908

SUBMISSION SCHEDULE NO DESCRIPTION REVISION SCHEDULE DATE NO DESCRIPTION

PROJECT: DYRS GYMNASIUM

RENOVATION 1000 MOUNT OLIVET ROAD, NE WASHINGTON, DC 20002

SHEET TITLE

ABBREVIATIONS & SYMBOLS

PROJECT NO: 1310 OCTOBER 12, 2015 NOT TO SCALE SHEET NO:

G-01

MATERIAL INDICATIONS



Š. HANDICAPPED STANDARD CHANGE IN ELEVATION OF CEILING, FLOOR ETC. Mi. 10 ROOM NUMBER STOREFRONT/CURTAIN WALL DETAIL NUMBER 01 **♦** 8 107.00 ELEVATION DESIGNATION A GLAZING TYPE **(A)** FIXTURE ACCESSORY NUMBER (A) WALL TYPE CAS (101) DOOR NUMBER EXISTING DOOR & FRAME NUMBER

102

102

DOOR & FRAME NUMBER

DWG. NUMBER DETAIL NUMBER BUILDING CUT DWG. NUMBER - DWG NUMBER DETAIL NUMBER DETAIL MARKER DWG NUMBER DWG, NUMBER

 Λ REVISION NUMBER DETAIL NUMBER DWG TITLE INTERIOR ELEVATION NUMBER INTERIOR ELEVATION MARKER INTERIOR FLEVATION NUMBER EXTERIOR FLEVATION NUMBER

GENERAL NOTES

THE FOLLOWING NOTES ARE APPLICABLE FOR THIS PROJECT, PROJECT COMPRISES OF IMPROVEMENTS AT THE GYMNASIUM AND RESIDENTIAL PODS IN THE EXISTING FACILITY, PROJECT CONSISTS OF CIVIL, LANDSCAPING, STRUCTURAL, ARCHITECTURAL, ELECTRICAL, AND ACOUSTICAL TECHNOLOGY WORK ONLY.

- SITE VERIFY ALL EXISTING DIMENSIONS AND CONDITIONS INDICATED ON EXISTING CONDITIONS DRAWINGS, PRIOR TO FABRICATION AND/OR INSTALLATION OF THE NEW WORK UNDER THIS CONTRACT.
- ABBREVIATIONS THROUGHOUT THE CONTRACT DOCUMENTS ARE TO BE READ SIMILARLY WITH OR WITHOUT PERIODS OR APOSTROPHES WITHIN THE ABBREVIATION.
- 3. ALL WORK SHALL BE PERFORMED IN STRICT ACCORDANCE WITH LOCAL AND NATIONAL CODES AND STANDARDS, ANY ITEMS REVISED IN THE CONTRACT DUCUMENTS THAT CONFLICT WITH CODES ARE TO BE NOTED PRIOR TO BIDS.
- 4. ITEMS AND CONDITIONS NOTED OR DETAILED ARE APPLICABLE AND BINDING TO SIMILAR CONDITIONS ON ALL DRAWINGS, FOR CONDITIONS ON TOTED OR DETAILED, CONTRACTOR SHALL PROVIDE MATERIAL AND LABOR OF EQUAL QUALITY AND PERFORMANCE TO OTHER SIMILAR CONDITIONS ON THE JOB.
- 5. REFER TO ELECTRICAL DRAWINGS FOR ADDITIONAL NOTES PERTAINING TO THEIR PARTICULAR TRADES AND FIELD CHECK AGAINST ANY CONFLICTS BETWEEN DRAWINGS, GENERAL CONTRACTOR SHALL COORDINATE, WORK OF ALL TRADES & REPORT TO THE ARCHITECT ANY CONFLICTS BETWEEN EXISTING CONDITIONS AND NEW WORK, PRIOR TO THE FABRICATION AND INSTALLATION OF NEW WORK.
- ANY AREAS OR SPACES NOT CLEARLY DEFINED OR INDICATED BY NOTES SHALL BE REVIEWED WITH THE ARCHITECT PRIOR TO PROCEEDING WITH ASSUMPTIONS. BIDS ARE TO ACCOMMODATE MOST STRINGENT SCENARIO/OFTON/ASSUMPTION.
- 7. ELECTRICAL SWITCHES, OUTLETS OR OTHER WALL MOUNTED ACCESSORIES SHALL BE INSTALLED IN LOCATIONS WHICH ARE SHOWN ON DRAWINGS, CONTRACTOR TO COORDINATE LOCATIONS PRIOR TO FABRICATION AND INSTALLATION OF ANY RELATED ITEMS IN CASE OF AMBIGUITY CONSULT WITH THE ARCHITECT.
- B. ELECTRICAL SMITOSES, THERMOSTATS, EXPOSED BLECT. ITEMS OR OTHER ELECTRONIC CONTROL IS IN THE RIME WORK SHALL BE MOUNTED AT THE SAME HEIGHT FROM FLOOR AS EXISTING A INJURYORY DORBELLY FASHION, ALL SUCH ITEMS ARE SHOWN ON DWGS. EXISTING LOCATION OF ALL ITEMS ARE TO BE CONFIRMED WITH ARCHITECT ON SITE PRIOR TO INSTALLATION.
- 9 ALL COLORS AND FINISH MATERIALS TO BE APPROVED BY THE OWNER AND THE ARCHITECT, BIDS ARE TO ACCOMMODATE SELECTION FROM MANUFACTURER'S FULL RANGE OF COLORS, FINISHES AND FABRICATION.
- 10. DIMENSIONS FOR ALL WALLS SHOWN ON PLANS ARE NOMINAL. THE CONTRACTOR SHALL USE ACTUAL DIMENSIONS SHOWN ON WALL TYPES SHEET FOR CONSTRUCTION, DO NOT SCALE DRAWINGS.
- 11. DIMENSIONS AT MASONRY WALLS ARE TO FACE OF WALL, U.O.N.
- 12 CONTRACTOR SHALL APPLY FOR, PAY FOR, AND OBTAIN ALL NECESSARY PERMITS OTHER THAN THE BUILDING PERMIT.
- 13. ALL SURFACES EXPOSED TO VIEW MUST BE PRIMED AND PAINTED, UNLESS OTHERWISE NOTED.
- 14. CONTRACTOR SHALL DISCONNECT AND CAP ALL UTILITIES THAT WILL BE AFFECTED BY WORK UNDER THIS CONTRACT PRIOR TO BEGINNING ANY WORK ON THIS PROJECT. RECONNECT AS REQUIRED FOR FULLY FUNCTIONING SYSTEMS.
- 15 CONTRACTOR SMALL PROTECT EXISTING BUILDING AND ELEMENTS FROM DAMAGE DURING DEMOUTION AND CONSTRUCTION UNDER THIS CONTRACT, IN CASE OF ANY DAMAGE, CONTRACTOR SHALL CORRECT THE DAMAGE TO THE SATISFACTION OF THE ACHITECT AND THE OWNER T NO COST TO THE OWNER.
- 16. WHERE EXISTING FLOORING IS REPLACED BY NEW FLOORING, CONTRACTOR SHALL REMOVE EXISTING FLOORING. AD HERIVES AND IMPERFECTIONS IN THE EXISTING FLOOR BY GRINDING THE FLOOR SLAB TO AN ABSOLUTELY FLAT SURFACE AND PROVIDING CONCRETE LEVELERS TO ACHIEVE A LEVEL, PLUMB, FLAT FINISHED FLOOR.
- 17. UNLESS NOTED AS EXISTING OR RELOCATED, ALL CONSTRUCTION IS TO BE ASSUMED NEW AND FURNISHED AND INSTALLED. BY THE CONTRACTOR.
- 18, ALL WORK SHALL BE IN COMPLIANCE WITH ALL APPLICABLE CODES AND GOVERNMENT REGULATIONS INCLUDING BUT NOT LIMITED TO: IBC 2012, WHERE SPECIFIED OR INDICATED REQUIREMENTS OF MORE CURRENT VERSIONS OF CODES, REGULATIONS, ETC, CONFLICT WITH 114TAT OF THE OF GOVERNMENT, THE MOST STRINGENT OF THE TWO
- 19: CONTRACTOR TO BECOME FULLY FAMILIAR WITH CONTRACT DOCUMENTS PRIOR TO BIDDING, ANY ABBREVIATIONS, 19. CHOIS, LANGLAGE MEALESS, LIFAMILLAR TEXT HOTTES, WORDNESS, DETAILS, ETC NOT UNDERSTOOD SHOULDES. BROUGHT TO THE CONTRACTING OPPICERS ATTENTION PRIOR TO BIDDING. 20. DRAWINGS ARE TO PROVIDED FOR DESIGN INTENT. CONTRACTORS BID SHALL INCLUDE VERIFYING EXISTING CONDITIONS AND MANING NECESSARY ADJUSTIMENTS OF THE SATISFACTION OF THE OWNER/ARCHITECT,
- 21, COORDINATE SITE ACCESS, STAGING, STORING, MATERIALS, WORK HOURS, WITH THE DGS PROJECT MANAGER PRIOR TO BIDDING.



DGS (DEPARTMENT OF GENERAL SERVICES) 1250 LI STREET, NW, WASHINGTON, DC 20009

ARCHITECT

E I A

LANCE BAILEY & ASSOCIATES 7600 GEORGIA AVENUE, NW WASHINGTON, DC 20012 T: (301)565-2283 F: (301)565-2281

STRUCTURAL ENGINEER



CONSULTING STRUCTURAL ENGINEER 6239 EXECUTIVE BULEVARD NORTH BETT-ESDA ND 2052-2008

ELECTRICAL ENGINEEL

GES

GLOBAL ENGINEERING SOLUTION \$225 WASCONSIN AVENUE NW. SUITE 300 WASHINGTON DC 20015 T: (202) 485-7745 F: (202) 485-7747



12 G STREET, NE. BUILT V 430 magrens fon, dic 2002 1: poppular-rays F: unit; am-sist

ACCUISTICAL CONSULTAN POLYSONICS 405 BELLE ARI LANE WARRENTON, VA 20165 T: (540) 341-4986 F: (540) 341-0908

SUBMISSION SCHEDULE DATE NO DESCRIPTION DATE REVISION SCHEDULE NO DESCRIPTION PROJECT:

DYRS GYMNASIUM RENOVATION


1000 MOUNT OLIVET ROAD, NE WASHINGTON, DC 20002

SHEET TITLE:

GENERAL NOTES

PROJECT NO: 1310 OCTOBER 12, 2015 SCALE: AS NOTED SHEET NO:

G-02

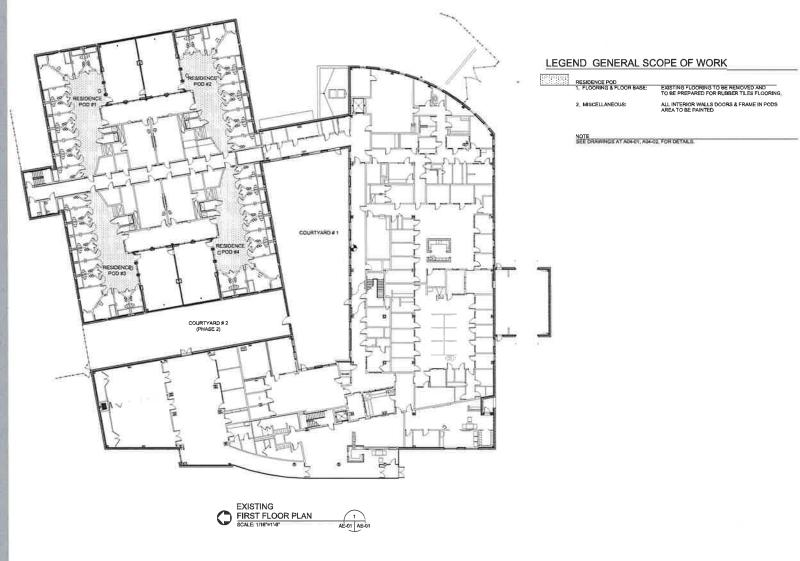



DGS (DEPARTMENT OF GENERAL SERVICES)
1250 I STREET, NW.
WASHINGTON DC 20009

LANCE BAILEY & ASSOCIATES
NO GEORGIA ANS NAS. NW
WAS-BUTTON, DC 20012
11 DOTUMB-2287

STRUCTURAL ENGINEER

MEY

CONSULTING STRUCTURAL ENGINEER 6239 EXECUTIVE BULEVARD NORTH BETHESDA MID 2005/2-900 T. 201-416-0469 www.mg/rengineers.com

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WASHINGTON, DC 20015
T: (202) 495-7746 F: (202) 495-7747

DVS. ENGNEER AMT

10 G STREET, NE, SUITE # 430 WASHINGTON, DC 20002 T: (202) 289-4545 F: (202) 289-5051

ACOUSTICAL CONSULTANT

HOS BELLE AND LAME WANNESTON, VA 20156 T. (SAT) 591-4988 F. (SAT) 541-0909

SUBMISSION SCHEDULE DATE NO DESCRIPTION REVISION SCHEDULE NO DESCRIPTION PROJECT:

DYRS GYMNASIUM RENOVATION


1000 MOUNT OLIVET ROAD, NE WASHINGTON, DC 20002

SHEET TITLE:

EXISTING FLOOR PLAN & SCOPE OF WORK

PROJECT NO: 1310 OCTOBER 12, 2015 SCALE: AS NOTED

AE-01

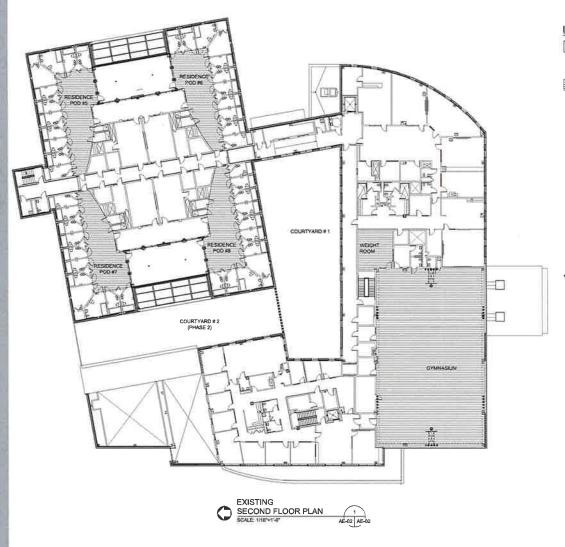

LEGEND SCOPE OF WORK

3 BASKETBALL HOOP:

RESIDENCE POD

1. FLOORING FLOOR BASE: EXISTING FLOORING TO BE REMOVED AND TO BE PREPARED FOR RUBBER TILES FLOORING

ALL INTERIOR WALLS DOORS & FRAME IN POD AREA TO BE PAINTED 2 MISCELLANEOUS:

GYMNASIUM

1. ACOUSTICAL PANELS:

PROVIDE ACCOUSTICAL PANELS AT ALL

2_STAGE:

WALL MOUNTED RETRACTABLE STAGE SHALL BE PROVIDED. ADDITIONAL 4 BASKETBALL HOOPS SHALL BE PROVIDED AT GYMNASIUM, 2 EXISTING BASKET HOOPS TO BE REPLACED.

PROVIDE ELECTRICALLY OPERATED SPACE DIVIDER 4. DIVIDER CURTAIN:

PAINT ALL EXPOSED GYMNASIUM WALLS, DOORS & FRAMES. 5 WALLS:

6_ LIGHTING:

PROVIDE LIGHTING FOR THE STAGE, PROVIDE LED STRIP LIGHTS AT SPECIFIC NEW ACQUISTICAL SPAREL LOCATIONS. THEY ARE TO BE CHANGE LIGHTING COLORS, CELLING FIRSTLESS WILL BE SHARE SHILL FEBRUAR BUT LIGHT BULBS WILL BE REPLACED WITH ENERGY EFFICIENT LED BULBS,

EXISTING FLOORING TO BE REFINISHED STAINED, AND NEW STRIPING TO BE PROVIDED FOR THE BASKETBALL COURT. COORDINATE WITH DYRS FOR CENTER COURT LOGO/GRAPHIC 7 FLOORING:

& WEIGHT ROOM. ADDITIONAL STAINLESS STEEL MIRROR WILL BE PROVIDED.

STRUCTURAL ELEMENTS
WALLS NEW OPENING TO BE CREATED IN THE
EXISTING WALL BETWEEN THE COURTYARD 1 &
COURTYARD 2

NOTE SEE STRUCTURAL DRAWINGS FOR DETAILS



DGS (DEPARTMENT OF GENERAL SERVICES)

1250 U STREET, NW, WASHINGTON, DC 20008

LBA LANCE BAILEY & ASSOCIATES

STRUCTURAL ENGINEER MGV

CONSULTING STRUCTURAL ENGINEER 5239 EXECUTIVE BULEVARD NORTH BETHESDA DO 70652-3005 T: 301-816-0649 F: 301-616-0649

FLECTRICAL FROMFER

GES

GLOBAL ENGINEERING SOLUTION SZZS WISCOMEN AVENUE, NW, BLITE DRE WARMENGTON, DC JUSTS T: (2002-005-77%), F: (2002-005-77%)

CHALENCOR

AMT

10 G STREET, NE, SUITE # 430 WASHINGTON, DC 20002 T: (202) 288-545 F: (202) 289-5061

ACOUSTICAL CONSULTANT POLYSONICS

DATE SUBMISSION SCHEDULE NO DESCRIPTION REVISION SCHEDULE DATE NO DESCRIPTION

DYRS GYMNASIUM RENOVATION

1000 MOUNT OLIVET ROAD, NE WASHINGTON, DC 20002

SHEET TITLE:

PROJECT:

EXISTING FLOOR PLAN & SCOPE OF WORK

PROJECT NO: 1310 OCTOBER 12, 2015 SCALE: SHEET NO:


AE-02

DEMOLITION NOTES:


- EMAL:
 BEFORE STARTING DEMOLITION, WALK THE SPACE WITH THE ARCHITECT TO EXPLAIN THE PROCESS AND
 PROCEDURE OF DEMOLISHING THE ITEMS DESIGNATED TO BE DEMOLISHED AND REMOVED.
 PROTECT WALKS, CEILINGS AND FLOORS AROUND THE DEMOLITION AREAS WITH SUITABLE MATERIALS SUCH AS
- PROTECT WALLS, SURFINESS AND FLOORS AND FLOOR OF REMOVED AND ADMINISTRATION OF THE PROPERTY OF SEAL PROJECT WORK AREA FROM OTHER AREAS OF THE BUILDING TO PREVENT DUST TRAVELLING OUTSIDE OF THE

WORK AREA.

- REMOVE EXISTING BASE AND FLOOR FINISHES, CLEAN CONCRETE SUBFLOOR OF ADHESIVES, SEALANTS OR MASTIC TO A LEVELLED SMOOTH FINISH ACCEPTABLE TO THE NEW RUBBER TILE MANUFACTURERANSTALLER
- GYMNASIUM: PROTECT ALL VERTICAL SURFACES AND SEAL OFF ALL VENTILATION SYSTEMS TO PREVENT AIRBORNE CONTAMINATES GETTING INTO ADJACEMENT AREAS,
- DEMOLSH EXISTING ACCUSTICS WALL PANELS, ON COMPLETION OF PANELS REMOVAL, ASK ARCHITECT TO INSPECT THE FRAMING TO DETERMINE IF THEY CAN BE USED. IF NOT REMOVE ALL FRAMING AND SUPPORTS AT THE GYMNASIUM WALLS, COVER AND PROTECT SURROUNDING WALLS, FLODRING AND CELLINGS FROM DAMAGE DURING
- 4 DEMOLISH EXISTING BASKETBALL HOOPS AND SUPPORTS.
- (5) REMOVE EXISTING BASE ON ALL WALLS, DOORS AND FRAMES.
- **⑥** REMOVE ALL CEILING LIGHT BULBS, ALL CEILING LIGHT FIXTURES WILL REMAIN IN PLACE TO RECEIVE NEW BULBS.
- INSPECT DYMNISHUM FLOOR FOR DAMAGED WOOD, ANY REPAIRS TO GYM FLOOR SHOULD SE DONE IN A MANNER AS TO MATCH THE EXISTING FLOORING AS CLOSE AS POSSIBLE.
- SAND GYM FLOOR USING THE COARSE, MEDIUM AND FINE SANDING MACHINES TO REMOVE THE EXISTING FINISH AND SANU GYM FLOOR USING THE CDAYSE, MEDIUM AND FINE SANDING MACHINES TO REMOVE THE EXISTING FINISH AND THE FLOOR SUPFACE IS COMPLETELY SMOOTH AND ACCEPTABLE TO RE-FINISH MARERIAL MANUFACTURER'S SATISFACTION, SCREEN AND VACUUM THE FLOOR TO ENSURE IT PREE FROM ALL DUST PARTICLES. PROVIDE FLOOR FINISH REMOVAL SPECIFICATION TO THE ARCHITECT WITH COMPLETE DETAILS ON SANDING OPERATION, NUMBER OF SANDINGS, TYPE OF SANDERS, BUFFERS, GRITS AND VACUUMING PROCESS, OBTAIN ARCHITECTS WRITTEN APPROVAL PRIOR TO STATING THE FINISH REMOVAL WORK.
- WEIGHT ROOM: REMOVE EXISTING PANELS AND EQUIPMENT ON THE WALLS.
- (1) ALL SIDES OF WALLS TO BE PATCHED, CLEANED FOR PAINTING.

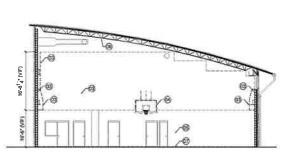



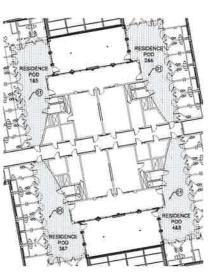






LEGEND

EXISTING FLOOR FINISH TO BE REMOVED

EXISTING ACOUSTICAL PANEL TO BE DEMOLISHED (ALL SIDES)

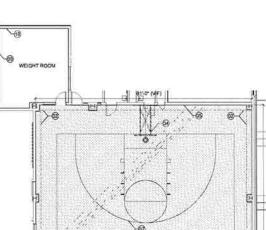

GVMNASE M

Filtra

DEMOLITION

SCALE: 1/8"=1'-0"

GYMNASIUM FLOOR PLAN

AD-01 AD-01

DATE SUBMISSION SCHEDULE NO DESCRIPTION REVISION SCHEDULE DATE NO DESCRIPTION PROJECT: DYRS GYMNASIUM RENOVATION 1000 MOUNT OLIVET ROAD, NE WASHINGTON, DC 20002

SHEET TITLE:

DGS

1250 U STREET, NW. WASHINGTON DC 20009

STRUCTURAL ENGINEER

ELECTRICAL ENGINEER

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CAN ENGINEER

AMT 10 G STREET NE SUITE 4 430 WASHINGTON DC 20002 T: (202) 289-4545 F: (202) 289-5051

MGV

LANCE BAILEY & ASSOCIATES

CONSULTING STRUCTURAL ENGINEER
ADDRESS THE DESCRIPTION OF THE PROJECT AND THE

GLOBAL ENGINEERING SOLUTION

5235 WISCONSIN AVENUE, NW, DUFFE 300

POLYSONICS

405 BELLE AIR LANE WARRENTON VA 20185 T. (540) 341-4988 F: (540) 341-0909

DGS (DEPARTMENT OF GENERAL SERVICES)

DEMOLITION PLANS & SECTION

PROJECT NO: 1310 OCTOBER 12, 2015 SCALE: SHEET NO:

AD-01

WALL/PARTITION SCHEDULE

7/8" FLERING CHANEL WITH 3/4" WOOD-PLASTIC COMPOSITE PANEL ANCHORED TO EXISTING CMU WALL (STARTS H=8/4" AFF)
1/12"X" WETAL STUD WITH 3/4" WOOD-PLASTIC COMPOSITE PANEL
WEEK ANATURE OF PERFORMENT

ACOUSTICS PANEL

1 1 /2" ACOUSTIC PANEL

EQUIPMENT

WALL SUSPENDED TOP ROLL DIVIDER. BOTTOM OF THE CURTAIN SHALL BE OPEQUE RETRACTABLE STAGE ZX4* COLORED ACOUSTICAL PANEL WALL SAFETY GUARD SPALDING DRAPER SHERIDAN E02 E03 E04 E05 E06 E07 DIVIDER CURTAIN ACOUSTICAL WALL PANEL AUDIMUTE SPALDING WALL PADING

COLUMN PADING SPALDING COLUMN SAFETY GUARD 4'X8' POLISHED STAINLESS STEEL MIRROR ANCHORED TO EXISTING

FLOOR

REFINISH EXISTING FLOOR, NEW STAIN, NEW STRIPING PER STANDARD.

EQUIPMENT LIST AND NEW WORK NOTES: GENERAL;

PRIOR TO DEVELOPING SHOP DRAWINGS, REVIEW DRAWINGS, SITE CONDITIONS AND DIMENSIONS FOR EACH EQUIPMENT TO ASSURE WHAT IS SPECIFIED AND INDICATED ON THE DRAWINGS THAT WILL FIT IN THE SPACE AVAILABLE FOR IT, IN CASE OF ANY ISSUE, CONTACT THE ARCHITECT IMMEDIATELY TO OBTAIN CLARITY

- ASSKETBALL HOOP SHALL BE WALL-BRACED FOLD UP BACKSTOP AS MANUFACTURED BY SPALDING EQUIPMENT COMPANY OR EQUAL APPROVED BY THE ARCHITECT, FIELD VERIFY STRUCTURAL SUPPORTS AND LENGTH FORM WALL REQUIRED FOR EACH BACKBOARD AND HOOP FRAMING, SUBMIT SHOP DRAWINGS WITH DIMENSIONS AND DETAILS FOR ARCHITECTS REVIEW AND APPROVAL.

- DIVIDER CURTAIN (E02):
 5. DIVIDER CURTAIN SHALL BE ROLL-UP TYPE, VINYL CURTAIN 50' WIDE AND 20' HIGH AS MANUFACTURED BY DRAPER INC, LOWER PORTION SOLID VINYL COATED POLYSTER MESH OR EQUAL APPROVED BY THE ARCHITECT,
 6. FIELD VERIEV STRUCTURAL SUPPORTS AND HEIGHT OF THE CURTAIN
 7. SUBMIT SHOP DRAWINGS WITH DIMENSIONS AND DETAILS FOR ARCHITECT'S REVIEW AND APPROVAL.

- RETRACTABLE STAGE E03):

 8. RETRACTABLE STAGE E03:

 9. FIELD VERIFY CONDITIONS FOR INSTALLATION AND OPERATION,

 10. STAGE SHALL BE INSTALLED IN ACCORDANCE WITH MANUFACTURERS INSTRUCTIONS AND FINAL SHOP DRAWINGS. TOP OF THE STAGE SHALL BE EARPET TILE FINISH,

 10. OPERATION SHALL BE LETRICALLY POWERD WINDHING MECHANISM FOR RETRACTING INTO WALL. POWER OUTLET AND SWITCH LOCATION MUST BE AT THE

 MANUFACTURER'S RECOMMENDED LOCATIONS

 12. STAGE SHAPE SHALL BE ARPETING, COLOR AS SELECTED BY THE ARCHITECT, SKIRTING SHALL BE FABRIC SKIRT BOARD.

 13. SUBMIT MANUFACTURER'S SHOP DRAWINGS WITH DIMENSIONS AND DETAILS OF INSTALLATION FOR ARCHITECT'S REVIEW AND APPROVAL.

ACCUISTICAL WALL PANELS (E04):

- USINCAL WALL PARELS (EM):
 ACQUISTICAL WALL PARELS SHALL BE AS MANUFACTURED BY AUDMUTE INC, OR EQUAL APPROVED BY THE ARCHITECT,
 FIELD VERRY CONDITIONS FOR INSTALLATION.
 SUBMIT SHOP DRAWINGS WITH DIMENSIONS AND DETAILS OF INSTALLATION FOR ARCHITECT'S REVIEW AND APPROVAL,

- WALL AND COLUMN PADDINGS (EG 5 & EG);
 17. WALL AND COLUMN PADDINGS SHALL BE AS MANUFACTURED BY SPALDING EQUIPMENT CO. OR EQUAL APPROVED BY THE ARCHITECT,
 18. SUBMIT SHOP DRAWINGS WITH DIMENSIONS AND DETAILS OF INSTALLATION FOR ARCHITECTS REVIEW AND APPROVAL.

- YOUN (LUTY).

 MIRROR SHALL BE AS MANUFACTURED BY SPALDING EQUIPMENT CO, OR EQUAL APPROVED BY THE ARCHITECT, MIRROR SHALL BE ANY FRAMELESS ROUNDED EDGE POLISHED STALLESS STEEL MIRROR. INSTALL ON THE MASORY WALL AT LOCATION NUICATED ON THE DRAWNINGS OR SPECIFIED.

- FLUUR RE-FINISHING (FUT & FUZ); GYM FLOOR RE-FINISHING AND LINE MARKING MATERIALS SHALL BE AS MANUFACTURED BY SIKA CORPORATION SPORT FLOOR 350 FINISH OR EQUAL APPROVED BY THE ARCHITECT.
- SUBMIT MANUFACTURER'S PRODUCT DATA SHEETS, MATERIAL SAFETY DATA SHEETS, AND RECOMMENDED INSTALLATION INSTRUCTIONS FOR ARCHITECT'S REVIEW SUBMIT MANUFACTURERS PRODUCT DATA SHEETS, MATERIAL SAFETY DATA SHEETS, AND RECOMMENDED INSTALLATION INSTRUCTIONS FOR ARCHITECTS REVIEW AND APPROVE PRIOR TO PROCUMEN MATERIALS.

 PREPARE SURFACE IN ACCORDANCE TO FINISH MANUFACTURERS DIRECTIONS AND APPLY FLOOR FINISH IN ACCORDANCE TO FINISH MANUFACTURERS DIRECTION. PROTECT ALL VERTICAL SURFACES AND SEAL OF ALL VENTILATION SYSTEM TO PREVENT AIRBORNE CONTAMINATES.


 FOLLOW MANUFACTURERS RECOMMENDATIONS ON URETHANGE COAT SEALER AND CURING.

- PAINT NEW GAME LINES AS INDICATED ON THE DRAWINGS.
- ON COMPLETION, CLEAN UP ALL AREAS AND SURFACCES OF DUST, DIRT AND RUBBISH

- PROVIDE WALL SAFETY PAD AT ALL EXISTING BUMPOUTS COLUMN PROJECTIONS
- PROVIDE 15' WIDE SAFETY PAD AT THE CENTER OF ALL BASKETBALL HOOP AT ALL WALLS.
 PROVIDE SAFETY PAD AT BACK OF RETRACTABLE STAGE WHILE STANDING UP, PAD MUST BE REMOVABLE ONLY AT THE STAGE

GYMNASIUM FLOOR BASE: 32 PROVIDE 4" VINYL BASE AT WALLS IN THE GYMNASIUM

PODS: 33. SEE DRAWINGS A04-01 FOR FLOOR FINISH AND PATTERNS. 34. PROVIDE NEW 4* HIGH VINYL BASE.

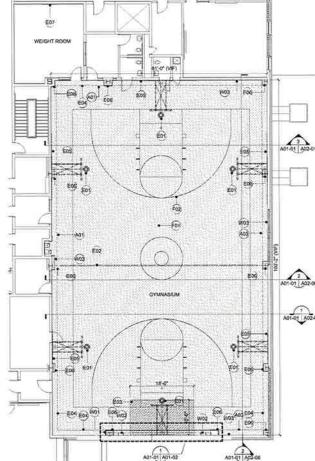

GYMNASIUM

FLOOR PLAN SCALE: 1/8"=1'-0"

DGS

DGS (DEPARTMENT OF GENERAL SERVICES)
1350 USTREET, NW.
WASHINGTON, DC 20009

ARCHIECI



LANCE BAILEY & ASSOCIATES WASHINGTON DC 20012 T: (301)565-2283 T: (301)665-2297

STRUCTURAL ENGINEER



CONSULTING STRUCTURAL ENGINEER NORTH BETHESDA MD 20852-3806 T: 301-816-0549 F: 301-810-0649

ELECTRICAL ENGINEER



GLOBAL ENGINEERING SOLUTION 525 W600AGN AVENUE NW. BUITE 36 WASHINGTON, DC 20013 1: USUI 465-7745 F. G02; 465-7747

CAN, ENGINEERS AMT

10 C STREET, NE SUITE # 430 WASHINGTON DC 20002 T; (202) 289-4545 F; (202) 289-5051

POLYSONICS WARRENTON VA 20186 T; (540) 341-4988 F; (540) 341-0908

SUBMISSION SCHEDULE DATE NO DESCRIPTION REVISION SCHEDULE DATE NO DESCRIPTION

DYRS GYMNASIUM RENOVATION

1000 MOUNT OLIVET ROAD, NE


SHEET TITLE

PRO IECT

GYMNASIUM FLOOR PLAN

PROJECT NO: 1310 OCTOBER 12, 2015 SCALE: AS NOTED SHEET NO:

A01-01

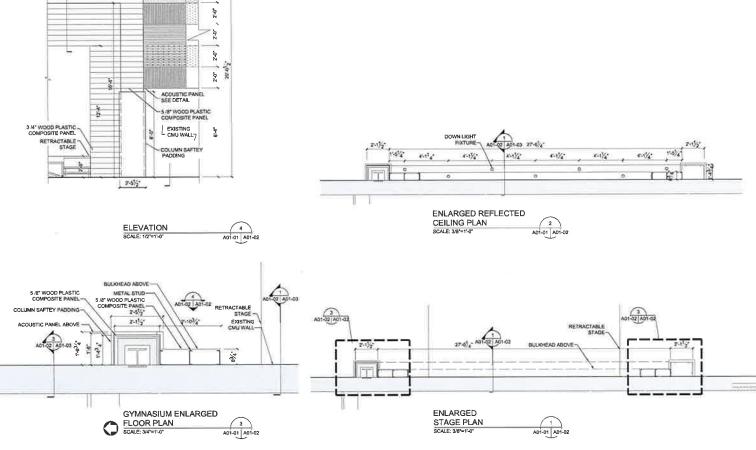

NOTE:

01 ALL WOOD PLASTIC COMPOSITE PANEL SHALL BE ATTACHED TO STUD WITH SCREWS.

02 VERIFY WITH POLYSONICS ON PANELS AND ATTACHMENT DETAIL

OVER.

DGS

DGS (DEPARTMENT OF GENERAL SERVICES)
1250 USTREET INV

ARCHITECT

LANCE BAILEY & ASSOCIATES
WASHINGTON, DC 20012
T: (301)565-2283 F: (301)565-2287

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CONSULTING STRUCTURAL ENGINEER
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ELECTRICAL ENGINEER

GES

GLOBAL ENGINEERING SOLUTION 5225 WISCOWSIN AVENUE NW, SUITE 1000 WASHINGTON, DC 20015 T: (202) 495-7746 F: (202) 495-7747

CIVIL ENGINEER

AMT

10 G STREET, NE SUITE # 430 WASHINGTON DC 20002 T: (202) 289-4645 F: (202) 289-5051

ACQUISTICAL CONSULTANT
POLYSONICS
406 BECLE AND UMBE
WHENCENTON, VA 20168.
1. (145) 541-4508 F. (145) 541-2008

SUBMISSION SCHEDULE DATE

NO DESCRIPTION

REVISION SCHEDULE DATE

NO DESCRIPTION

PROJECT:

DYRS GYMNASIUM

RENOVATION


1000 MOUNT OLIVET ROAD, NE WASHINGTON, DC 20002


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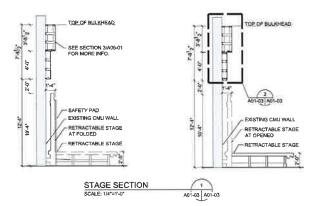
GYMNASIUM ENLARGED PLANS & ELEVATION

PROJECT NO: 1310
OCTOBER 12, 2015
SCALE: AS NOTED
SHEET NO:

A01-02



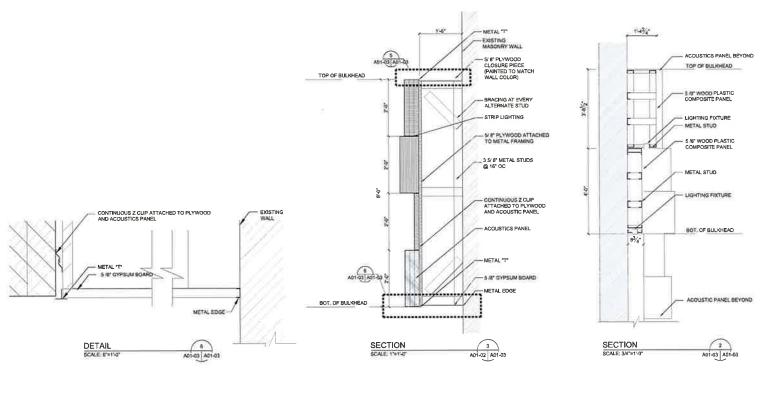

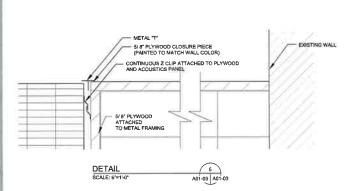

* * * DGS DGS (DEPARTMENT OF GENERAL SERVICES)
1260 USTREET NW,
WAS DESIGNED. . . . LANCE BAILEY & ASSOCIATES
7000 GEORGIA MENUAL NW
WAS SHIPTON, OC 20017
11 (201) MENUAL P. (201) MENUAL P. STRUCTURAL SAGRESH MOY DIFFERENCE PRODUCTS GES GLOBAL ENGINEERING SOLUTION \$225 MOCONSIN AVENUE, NW, SLITE 300 WASHINGTON, OC 20012 T. (2021 MG-7745 F) (2021 MG-7747 GML ENGINEER AMT NS G STREET, NE, SUITE # 436 WASHINGTON, DC 2000/ E USEC/200-4345 F: (242) 200-5031 POLYSONICS 405 RELLE ARE LANE MARKENTON, VA 2010E T. CASE 341-4988 F. CASE 341-5109

SUB	BMISSION SCHEDULE	DATE
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AS NOTED


PROJECT NO: 1310 OCTOBER 12, 2015 SCALE:


SHEET NO:

A01-03

NOTE:

- 01 ALL +4.5" (INDICATIVE) PROJECTED TILES SHALL HAVE STRIP LIGHTING ABOVE THE TILE SEE DWG 3/M3-1-03, A02-02 TO A02-05 02 SEE STRUCTURAL DRAWINGS FOR SPACE ON/DIPC CURTAIN FRAMING FOR SUPPORTS, ADD STRUCTURAL FRAMING FO

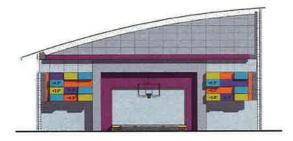

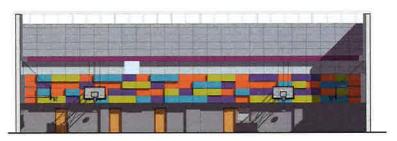








COLOR SCHEME NORTH ELEVATION SCALE: 1/8"=1'-0"



A02-01 A02-01

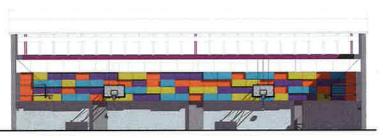

COLOR SCHEME SOUTH ELEVATION



DGS DGS (DEPARTMENT OF GENERAL SERVICES) 1250 U STREET, NW WASHINGTON, DC 20008

ARCHITECT



LANCE BAILEY & ASSOCIATES 7600 GEORGIA AVENUE, NW WASHINGTON, DC 20012 T: (301)665-2280 F: (301)685-2297

STRUCTURAL ENGINEER



ELECTRICAL ENGINEER



GLOBAL ENGINEERING SOLUTION S25 WISCOSSIN AVENUE, MV, SUITE 300 WASHINGTON, GC 2019. 1, GOD; 400-THE, F, GOZ; 85-7747



10 G STREET, NE, SUITE # 430 WASHINGTON, DC 20002 T: (202) 288-4545 F: (202) 288-5051

ACCUSTICAL CONSULTANT
POLYSONICS
405 SELLE AR LANE
WARRENTON, VA 2018B
T: (340) 341-9808 F: (540) 341-9908

SUBMISSION SCHEDULE DATE NO DESCRIPTION DATE REVISION SCHEDULE NO DESCRIPTION

DYRS GYMNASIUM RENOVATION

1000 MOUNT OLIVET ROAD, NE WASHINGTON, DG 20002


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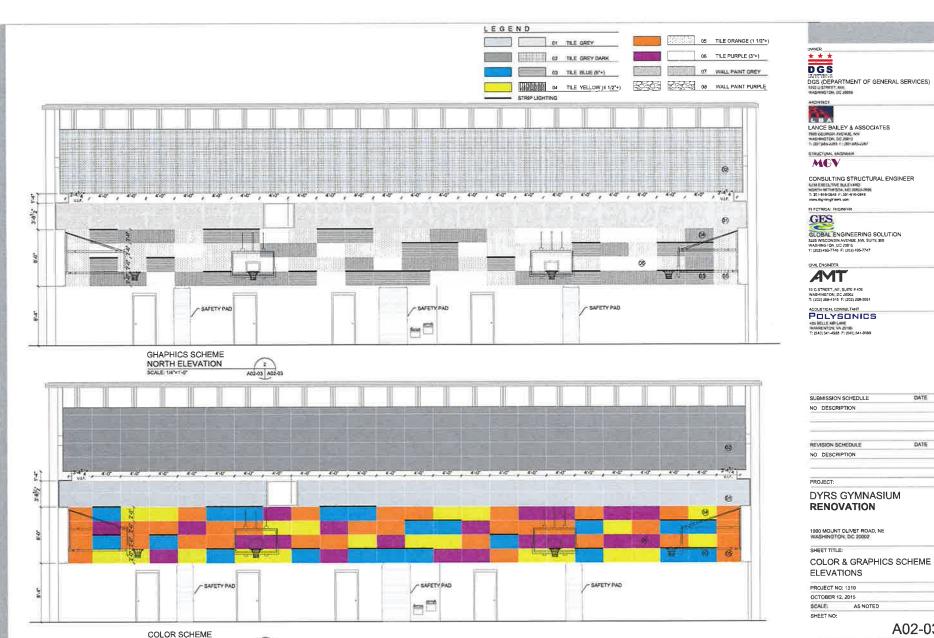
PROJECT:

COLOR SCHEME **ELEVATIONS**

PROJECT NO: 1310 OCTOBER 12, 2015 SCALE: AS NOTED

SHEET NO:




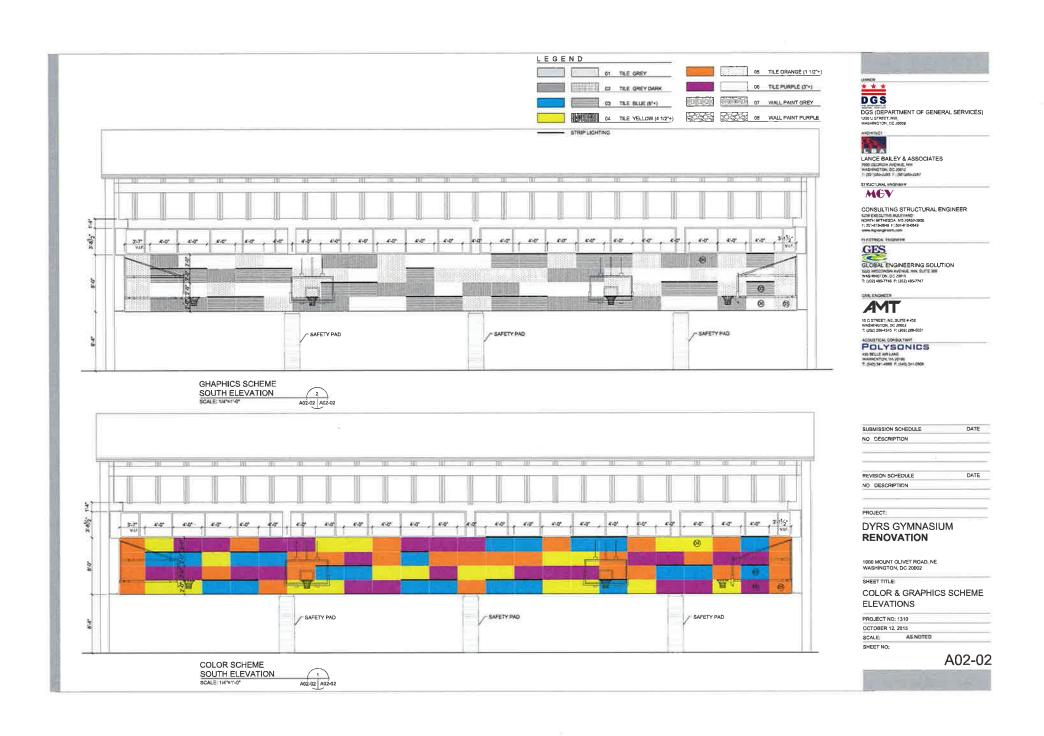

NORTH ELEVATION

A02-03 A02-03

DATE DATE DYRS GYMNASIUM

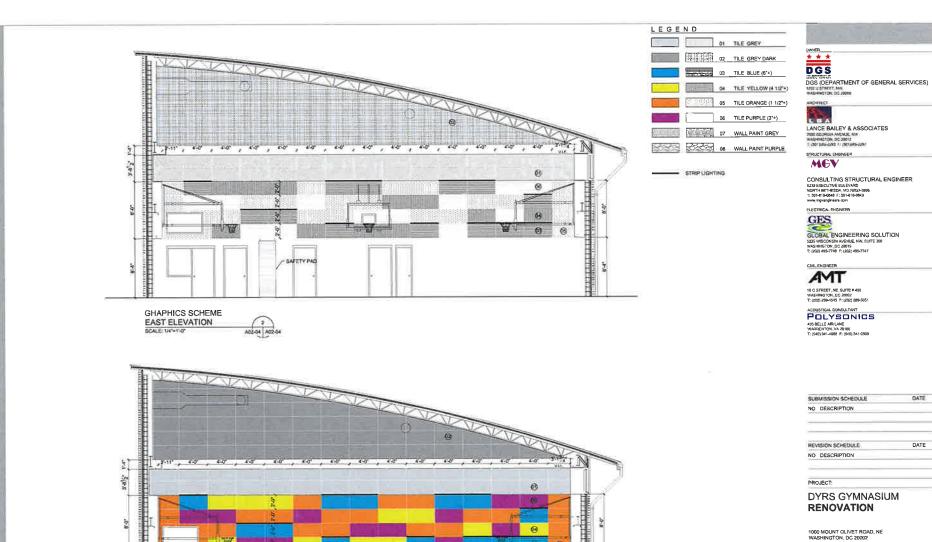

- SAFETY PAG

A02-04 A02-04

COLOR SCHEME

EAST ELEVATION


GLOBAL ENGINEERING SOLUTION 5225 WISCONSIN AVENUE, NW. SUITE 300 WASHINGTON, DC 20015 T. (202) 495-7748 F: (202) 495-7747 CML ENGINEER AMT 10 C STREET NE SUITE # 450 WASHINGTON, DC 20002 T: (202) 299-1545 F: (202) 289-5051 POLYSONICS 405 BELLE AIR LANE WARRENTON VA 20186 T: (540) 341-4988 F: (540) 341-0909 SUBMISSION SCHEDULE DATE NO DESCRIPTION REVISION SCHEDULE DATE

PROJECT: DYRS GYMNASIUM RENOVATION

1000 MOUNT OLIVET ROAD, NE WASHINGTON, DC 20002

COLOR & GRAPHICS SCHEME **ELEVATIONS**

PROJECT NO: 1310 OCTOBER 12, 2015 SCALE: AS NOTED

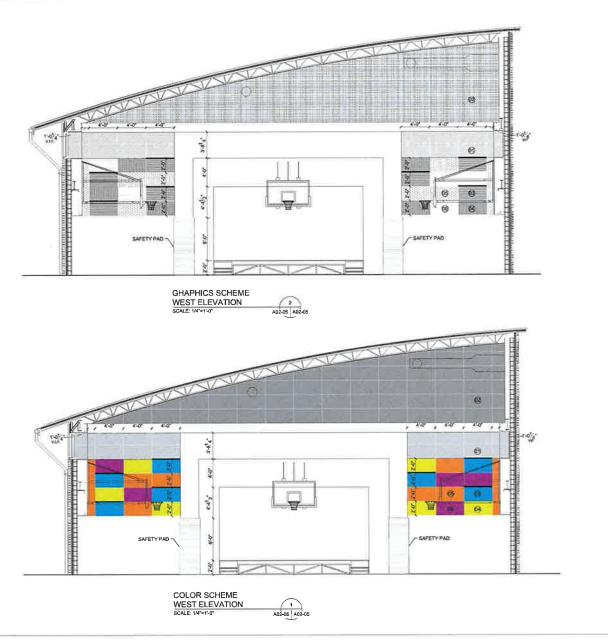





SUBMISSION SCHEDULE	DATE
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REVISION SCHEDULE	DATE
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PROJECT:	


DYRS GYMNASIUM RENOVATION


1000 MOUNT OLIVET ROAD, NE WASHINGTON, DC 20002

SHEET TITLE:

COLOR & GRAPHICS SCHEME ELEVATIONS

PROJECT NO: 1310 OCTOBER 12, 2015 SCALE: AS NOTED

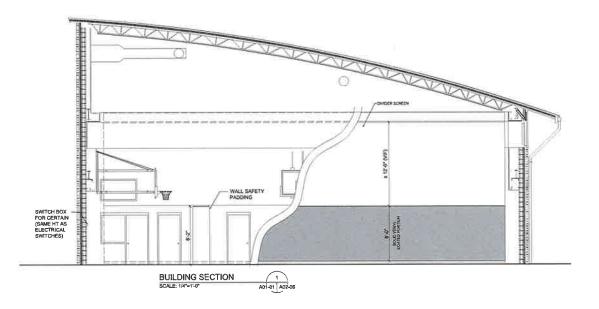

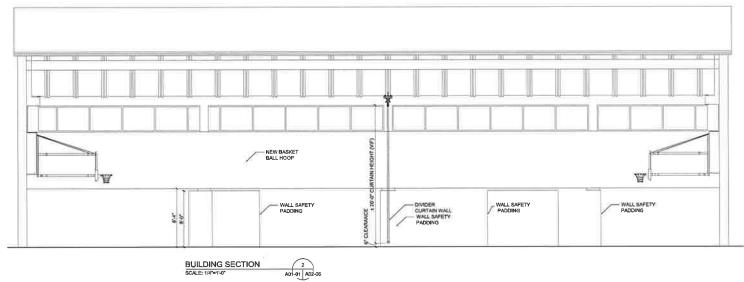

SCALE: 1/4"=1'-0"

* * * DGS DGS (DEPARTMENT OF GENERAL SERVICES)
1950 USTWEET, MW.
WASHINGTON, DC 20018 ARCHITECT P. PLA LANCE BAILEY & ASSOCIATES 7600 GEORGIA AVENUE, NW WASHINGTON DC 20012 T: (301)565-2293 F: (301)565-2297 STRUCTURAL ENGINEER MEV CONSULTING STRUCTURAL ENGINEER
4284 SECUTING BLEXNING
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1, 2014 SEC ELECTRICAL ENGINEER GES GLOSAL ENGINEERING SOLUTION 5225 WISCONSIN AVENUE, NW. SUITE 300 WASHINGTON DC 20015 T: (202) 495-7745 F: (202) 496-7747 CAN ENGNECE AMT 10 G STREET, NE, SUITE # 430 WASHINGTON, DC 20002 T: (202) 289-4545 F: (202) 289-5051

DATE SUBMISSION SCHEDULE NO DESCRIPTION REVISION SCHEDULE DATE NO DESCRIPTION PROJECT: DYRS GYMNASIUM

RENOVATION

1000 MOUNT OLIVET ROAD, NE WASHINGTON, DC 20002

ACOUSTICAL CONSULTANT
POLYSONICS
406 BELLE AIR LANE
WARRENTON, VA 20186
T: (540) 341-1988 F: (540) 341-0908

SHEET TITLE:

BUILDING SECTIONS

PROJECT NO: 1310 OCTOBER 12, 2015 SCALE: SHEET NO

LEGEND




FLOOR FINISH

FASOLPLUS - VINYL TILE RESIDENCE POD FLOOR FINISH

NOTE:

THE DRAWING REPRESENTS THE FLOOR PATTERN. CONTRACTOR IS REQUIRED TO USE THE CAD DRAWINGS TO DEVELOP THE SHOP DRAWINGS WITH PATTERN AND DIMENSIONS,

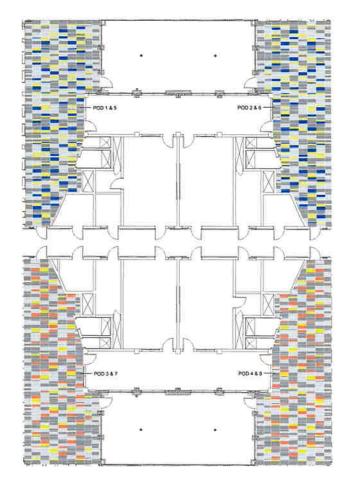



OWNER A DGS

DGS (DEPARTMENT OF GENERAL SERVICES)
1550 USTREET, NW.,
WASHINGTON, DC 20009

LANCE BAILEY & ASSOCIATES
NO GEORGIA AND USE NO
WASHINGTON, DC 20012
T, GEORGIA ST, DE 1001200-1201

STRUCTURAL ENGINEER

MGV

CONSULTING STRUCTURAL ENGINEER
6236 EXECUTIVE BULEVARD
NORTH BETHESDA, MID 20052-3000
17: 301-516-0646 F; 301-516-0649

PLECTRICAL FROMER

GES

GLOBAL ENGINEERING SOLUTION 1223 INSCOUND AVENUE, NW 0.FE 300 NATIONAL DECEMBER OF 2003 F (201) 456-7745 F (202) 455-7757

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ACOUSTICAL CONSULTANT

POLYSONICS

SUBMISSION SCHEDULE DATE NO DESCRIPTION REVISION SCHEDULE NO DESCRIPTION PROJECT:

DYRS GYMNASIUM RENOVATION


1000 MOUNT OLIVET ROAD, NE WASHINGTON, DC 20002

SHEET TITLE:

FLOOR PATTERN & COLOR SCHEMES PODS 1,2,3 & 4

PROJECT NO: 1310 OCTOBER 12, 2015 SCALE: AS NOTED


A04-01

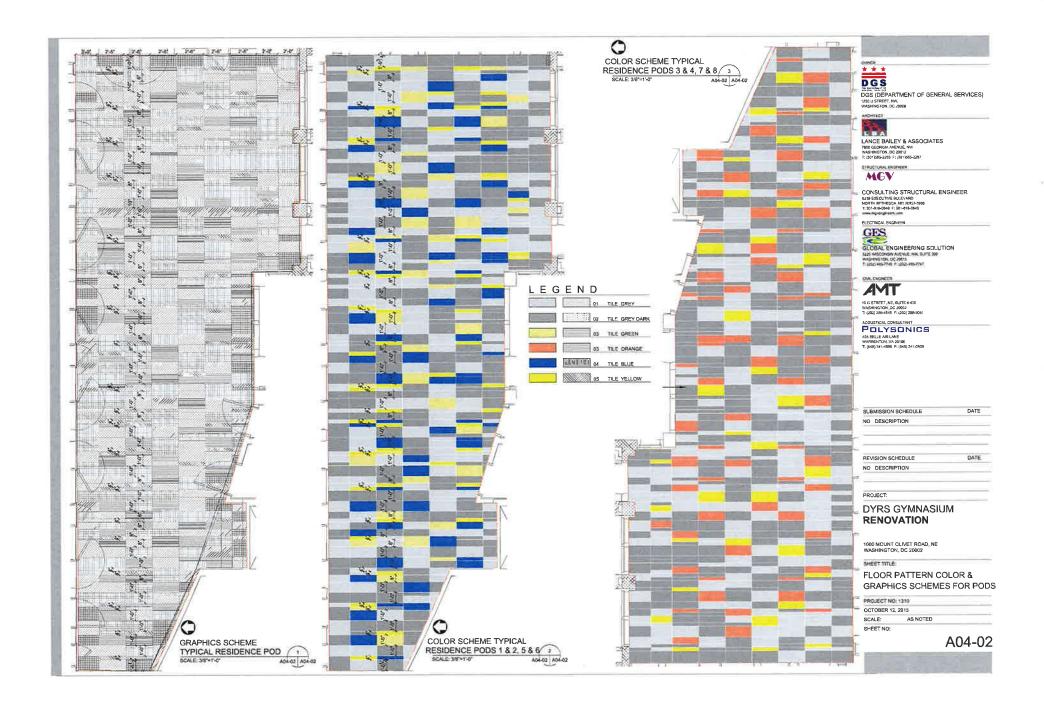

GENERAL NOTE:

1. SEE ARCHITECTURAL DRAWINGS FOR ACCUSTIC PANEL LOCATIONS AND LAYOUT.

2. SEE AZSO1 FOR ACOUSTICAL PANEL MOUNTING DETAIL

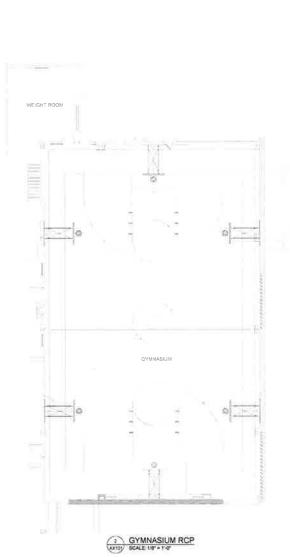



LANCE BAILEY & ASSOCIATES
MOS 07-000 A AVENUE NW
WASHINGTON OC 78812
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CONSULTING STRUCTURAL ENGINE

DICTURE SHOWER HAS BOUNTED

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SUBMISSION SCHEDULE 50% DESIGN DEVELOPMENT CONSTRUCTION DOCUMENTS DATE 07/28/15 08/14/15

REVISION SCHEDULE NO DESCRIPTION DATE

PROJECT:

DYRS GYMNASIUM RENOVATION

1000 MOUNT OLIVET ROAD, NE WASHINGTON, DC 20002


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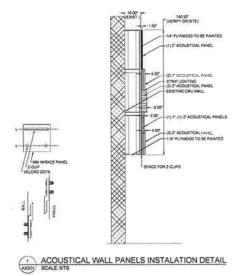
GYMNASIUM FLOOR PLAN % RCP

PROJECT NO: 1310
AUGUST 14, 2015
SCALE: AS NOT

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CONSULTING STRUCTURAL ENGINEER

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SUBMISSION SCHEDULE 50% DESIGN DEVELOPMENT CONSTRUCTION DOCUMENTS

REVISION SCHEDULE
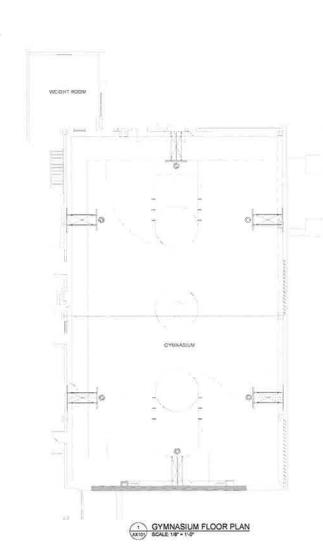
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DATE

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PROJECT:

DYRS GYMNASIUM RENOVATION

1000 MOUNT OLIVET ROAD, NE WASHINGTON, DC 20002

SHEET TITLE:

DETAILS

PROJECT NO: 1310
AUGUST 14, 2015
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DYRS GYMNASIUM RENOVATION

NE WASHINGTON D.C.


CONSTRUCTION DOCUMENTS
AUDIOVISUAL SET
AUGUST 14, 2015



Polysonics

Acoustics & Technology Consulting 405 Belle Air Lane

Warrenton, VA 20186 540-341-4988

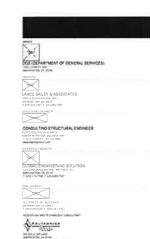

SUBMISSION SCHEDULE 50% DESIGN DEVELOPMENT DATE 07/28/15 08/14/15

REVISION SCHEDU

DATE

PROJECT:

DYRS GYMNASIUM RENOVATION

1000 MOUNT OLIVET ROAD, NE WASHINGTON, DC 20002

COVER

PROJECT NO: 1310
AUGUST 14, 2015
SCALE: AS NOTED

TA000

SHEET INDEX

 SHEET NUMBER
 SHEET NAME

 TA000
 COVER


 TA001
 NOTES

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 GYMNASIUM FLOOR PLAN & RCP

 TA501
 DETAILS

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USBA	UNIVERSAL SERIAL BUS - TYPE A
US88	UNIVERSAL SERIAL BUS - TYPE B
WWW	UNIVERSAL SERIAL BUS - TYPE B MINI
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SUBMISSION SCHEDULE

REVISION SCHEDULE

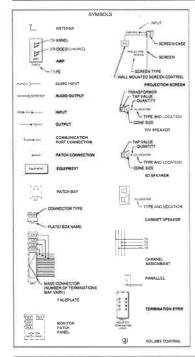50% DESIGN DEVELOPMENT

CONSTRUCTION DOCUMENTS

DYRS GYMNASIUM RENOVATION

1000 MOUNT OLIVET ROAD, NE WASHINGTON, DC 20002

DGS (DEPARTMENT OF GENERAL SERVICES)
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SHEET TITLE:

NOTES

PROJECT NO: 1310
AUGUST 14, 2015
SCALE: AS NOTED

SHEET NO:

TA001

DATE

07/28/15

08/14/15

DATE

DEVICE NAME	DESCRIPTION	FONTE	PHONEDATA	50% SUE	HEGH	Connects:
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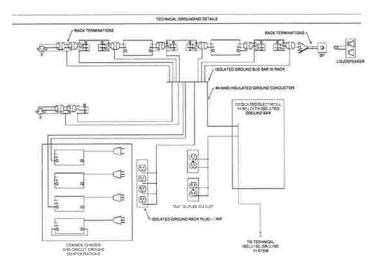
GENERAL PROJECT NOTES

- 1 REFER TO ARCHITECTURAL DRAWNOS FOR EXACT LOCATIONS OF ALL AV DEVICES
 2 DEVICE ICONS ARE NOT SCALED DEVICE WILL BE CENTERED WHERE THE SYMBOL, IS LOCATED AT EACH FLOOR, CEILING AND WALL LOCATION
 3 ALL AV PLATES PROVIDED AND INSTALLED BY AC CONTRACTOR UNLESS OTHERWISE NOTED


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SUBMISSION SCHEDULE 50% DESIGN DEVELOPMENT CONSTRUCTION DOCUMENTS

REVISION SCHEDULE NO DESCRIPTION

PROJECT:

DYRS GYMNASIUM RENOVATION

1000 MOUNT OLIVET ROAD, NE WASHINGTON, DC 20002

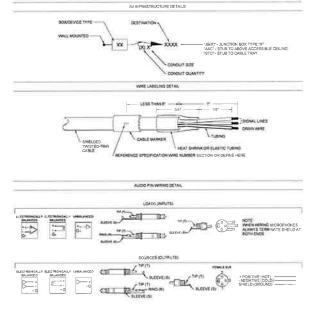SHEET TITLE:

NOTES

PROJECT NO: 1310 AUGUST 14, 2015 SCALE:


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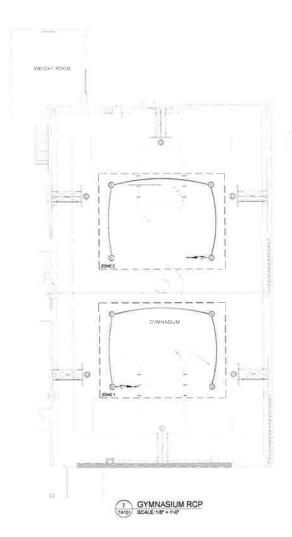
TA002

DATE

07/28/15

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LANCE BAILEY & ASSOCIATES
From Deconomina-vision from
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CONSULTING STRUCTURAL ENGIN

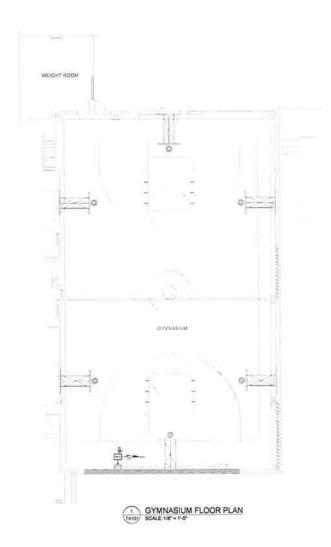

10 C STREET NE SUITE FAIR WASHINGTON DE 20007

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SUBMISSION SCHEDULE SON DESIGN DEVELOPMENT CONSTRUCTION DOCUMENTS 07/28/15 08/14/15

REVISION SCHEDULE NO DESCRIPTION DATE

PROJECT:

DYRS GYMNASIUM RENOVATION

1000 MOUNT OLIVET ROAD, NE WASHINGTON, DC 20002

SHEET TITLE:

GYMNASIUM FLOOR PLAN % RCP


PROJECT NO: 1316

AUGUST 14, 2015


SCALE: AS NOTED

SHEET NO:

TA101

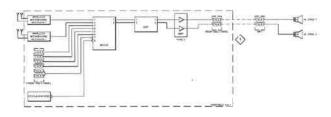

GYMNASIUM AUDIO LINE DIAGRAM SCALE: NTS

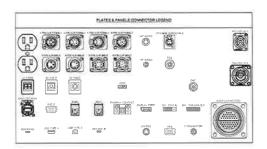




SPEAKER INPUT WALL PLATE QUANTTY 1 SIZE DOUBLE GAVS FINISH: BLACK W/ WHATE LETTERING NOTE: -





REAR RACK INPUT PANEL
QUANTITY I
SIZE I RU
FINISH BLACKW/WHITE LETTERING
NOTE -

3 PLATES AND PANEL DETAILS
TASDY SCALE:NTS

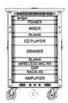

GYMMASUM PORTABLE RACK TOTALAMPS: 3 TOTAL WATTS 228 TOTAL BTU 778 CRCUITS (1) 20A 120V

2 GYMNASIUM PORTABLE RACK ELEVATION 1905/ SCALE:NTS

CEY NOTE

1. CONNECTIONS BETWEEN RACK AND WALL PLATE IS PRESENT ONLY WHEN IN USE
2. PORTAGE RACK IS GATOR G-SHOCK-ISL.



DGS (DEPARTMENT OF DENERAL SERVICE) 1931 CC 09/34 AVE IUC SWY
WASHING TON DC 2019
T (2015/6-7292 F (2014)6-7292 T PRINK-YEAR C CONSULTING STRUCTURAL ENGINEER

CONSULTING STRUCTURAL ENGINEER

8076/FC FUNDY RESPONSE

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ingue Sources		
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COMONONE	Section CD-2004	- 41
	and a land and	- 2
Mixera Processors		
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Made DSP	With Director's Symulation	
Wireless Microphone System		
Wilefelia Michighore Receives	Shure DLXD 124/05	2
Attended to the state of	Share DLICH Receiver	INCL
	State OLXIZ Hand Held Transmitter	INCI
	Shure CLXD1 Body Pack Dansmitter	INCL
	Shurp SM58 Handheld Mic	INC
	Share WL185 Languer Mic	INCI
Wirmi Nics, Stands, Accessor		
West Moouranes	Snure SM-58	
Mangelore Davies	Alths MS-12CE	
Amplifiers/Spowers		
Certima Socialera	JBL AWC 129	
Prison Artes 64	Crown Dc: 2-600	- 2
Microphone/Speaker Cebies		
Fude Cores	Windwid MK425	T
	Whitwind MK450	7 7 2
	Whitehal NL4-010	2
Wiscellaneous Equipment		
Pair Rata Parel	RCI Custom	
Feet Rick Parel	RCI Outlon	
Equipment Racks		
Parvisin State	Gator Cases G-SHOCK-16L	
Carder Stone	Gmor Cases GA-200	- 0
Hack Crown	Middle Atlantic TD3LK	- 1
Florier Contrioner	Supply SXC120R*	- 1
Black Paners	Middle Atlantic Blank Penels	1.5
DOM FEED	INDUSTRIAL COSTA PERES	u



SUBMISSION SCHEDULE
50% DESIGN DEVELOPMENT
CONSTRUCTION DOCUMENTS
REVISION SCHEDULE
NO DESCRIPTION
PROJECT:
DYRS GYMNASIUM
RENOVATION
1000 MOUNT OLIVET ROAD, NE
WASHINGTON, DC 20002

PROJECT NO: 1310 AUGUST 14, 2015 SCALÉ:

SHEET TITLE: **DETAILS**

SHEET NO:

TA501

DATE

07/28/15 08/14/15

DATE

ELECTRICAL LEGEND

GENERAL NOTES

- THE WORK TO BE DONE SHALL INCLUDE THE FURNISHING OF ALL LIBODR, MATERIAS, APPLIANCES, ROUMENT TOOLS TRANSPORTATION SUPPRESSED TO CONSTITUTE, THE FULL AND TO MODEL'S THE SELECTION AS SERVED TO CONSTITUTE, THE FULL AND TO MODEL'S THE ELECTRICAL SESSION OF CHESING SHOCK OF DOWN OF THESE OWNERS OF THE ELECTRICAL SESSION PROVIDE AND INSTALL ALL NECESSARY AND ICRES SLEEVES HANGERS STC FOR OR COMMECTING LLECTRICAL MORE TO RELATED WORK OF STREET
- ALL ELECTRICAL WORK SHALL BE PERFORMED IN ETRICT ACCORDANCE WITH THE LATEST ADOPTED NATIONAL ELECTRICAL CODE AND ALL OTHER LOCAL CODES AND AUTHORITIES HAVING AUTOSICTION
- THE DRAWINGS, WHICH CONSTITUTE A PART OF THIS CONTRACT, INDICATE THE DATE THE ARRESTMENT OF DIRECTIFF AND LOCATIONS OF CUTTATE, ENTOHIS.

 PANEL BOARDS. CONDUIT AND OTHER WORK, ALL ITEMS NOT SPECIFICALLY. MENTIONED HEREIN WHICH ARE ACCESSORY TO MAKE A COMPLETE WORKING NETALLATION, SHALL BE INCLUDED AT NO EXTRA COST
- IT SHALL BE THE REPORTING IT FOR CONTRACTOR TO EXAMPLE AND TO CODICIONSE WITH THE ADDITIONAL SECUNDACY, PLUGING AND THE PROTECTION DISASSES AND THE DEPARTS OF ALL OTHER TRACE IN ORIGIN TO EXCHALL SECUNDACY. THE STECTHICAL WORK
- CONTRACTOR SHALL COORDINATE MOUNTING HEIGHTS AND LOCATIONS OF ALL MEMBELECTRICAL DEVICES WITH ARCHITECTURAL ELEVATIONS AND DRAWINGS THOR TO COMPENCIONENT OF WORK DEVICES INCLUDE BUT ARE NOT LIMITED TO RECEPTACIES, SWITCHES, FORTURES AND TELEGRIZA OUTLETS
- ALL ELECTRICAL MATERIALS SHALL BE NEW EXCEPT WHERE SPECIFICALLY NOTES AS FEED TO BE WILLIAM MATTRIAL SHALL BE USTROMY THE UNDERWRITERS LABORATORIES INC (U.L.) DEFECTIVE EQUIPMENT AND/OR EQUIPMENT DAMAGED DURING WETALLATION AND/OR TESTING SHALL BE REPLACED OR REPARED IN A MANAGE MEETING THE APPROVAL OF THE ARCHITECT AND THE SHOPKER, WHERE APPLICABLE, ALL SOUTHWAY SHALL BE IN ACCOMMODISM WITH INTHA STANDARDS.
- ALL WORK SHALL BE SUBJECT TO THE APPROVAL OF THE OWNER OR OWNERS
- 8 ALL WORKSHULL BE INSTALLED IN A NEAT AND HORIMANNINE WANNER
- B. INSTALL A FIRE STOP OF ROCKWOOL FISCH OR SUCCIN FORM SEALANT TO PHOYOC AN EXTRECTIVE BIARRICA AGAINST THE SPHEAD OF THE AND SMOKE WHERE CONCLUTS, MINEWAYS, AND OTHER EXCENTION, RACCIVAYS MASS THROUGH FIRE RAYED PARTITIONS, MINIORS BLASS.
- THE ENGINEER, AND BECOME THE PROPERTY OF THE OWNER
- CONTRACTOR SHALL WE WAY ALL EGGREGATIVE TO SHE CONTRACTOR SHALLING CONDUCTOR CONDUCTORS FROM POWER SOURCE TO
- 12 THE CONTRACTOR SHALL MINN SLAS IN AREA OF PENETRATION PRICA TO CORE
- 13 CONDUCTOR WISTING ATTOM HOMERUNG TO THE PARE BOARD MAY BE BUIN TODETHER IN ONE CONDUST
- 14 PROVIDED ALL CONNECTIONS ARE IN ACCORDANCE WITH THE NATIONAL ELECTRICAL CODE AND LOCAL ELECTRICAL CODE REQUIREMENTS, AND THE MAXIMUM UNBALANCED CURRENT IN NEUTRAL DOES NOT EXCEED THE CAPAC OF THE WINE NO MORE THAN 3 SHOLE PHANE CHECUT SHALL DE RISTALLED IN ONE RACEWAY ELIMINATE STUCES WHEREVER POSSIBLE, AND WHERE MCCESSAY, DRUCE IN READLY ACCESSIBLE PULL, LANC YOU ON OUTLES SOR.
- 5 MODIFICATIONS TO EXISTING PANELBOARDS THE ELECTRICAL CONTRACTOR SHALL PROVIDE NEW CIRCUIT INCAMENS AND/OR FUSED SHITCHES AS REQUIRED. NEW EQUIPMENT OF HILL MATCH CREETING NOTALLED COUPMENT AND SHALL BE OF THE DAME MANUFACTURES AND TYPE AS SMILAR CRETING. EQUIPMENT, INTERPLIFT MATING OF EQUIPMENT SHALL BE THE BAVE AS OF THE
- 6. INTERRUPTION OF ELECTRICAL POWER, THE ELECTRICAL CONTRACTOR. SHALL CONGRAVE ALL WORK REQUIRED ATERCEPTOR OF ELECTRICAL POWER WITH THE BULDHOOD GROWER AND SHALL CORN AN WITHIN REMIREDER, FROM THE SULLING CONVERT REGIS TO ENLITTING DOWN FOREST TO ANY ENTITIONISMS THE CONTRACTOR SHALL ALSO PROVED AND THE TO ALL OTHER TRACES OF ALL SOCIEDAD OF EXPRINENTIANCE OF POWER.
- IT SITE VISIT, PROR TO SUMMETING HIS BID. THE FUTCE FOR CONTRACTOR SHALL VISIT THE SITE AND HARLINGS HOUSELF WITH ALL EXISTING CONDITIONS THE ELECTRICAL CONTRACTOR SHALL NOTIFY THE ARCHITECT AND/OR IFFR IN ADVANCE OF MAY COMOTIONS THAT EXIST THAT HOURD PRICED. THE WORK HEREIN SPECIFIED OR SHOWN ON THE DRAWINGS FROM BEING THE WORK RENEWS SPECIFIED OR SHOWN ON THE DIAGRAMS FROM BEING REPRORMED, FALLIER ID SUPPORT HE SITE FROM TO BED AND START OF CONSTRUCTION WILL NOT RELIEVE THE CONTRACTOR OF THE RESPONDE TO RETALL DEBIES WITHIN THE CONTRACT OF THE EXISTING CONDITIONS.

ELECTRICAL LEGEND

GENERAL NOTES

- ME CUARANTEE THE ELECTRICAL CONTRACTOR SHALL LEAVE THE ENTIRE FLECTRICAL SHALL WITHOUT CHARGE REPLACE ANY WORK OR MATERIALS WHICH SHOULD AS FINAL ROCEPT FROM PROMISE WHICH WAS NOT THAN WITHIN ONE YOUR FROM THE OFFICE EDITOR FROM THE OFFICE STALL ROCEPTANCE SENERAL ACCEPTANCE SHEET FROM THE SHIPLE NOT SECOND FROM THE SHIPLE REPAIR AND ADJUSTMENTS OF ALL ELECTRICAL SYSTEMS AND EQUIPMENT, APPARATUS DEVICES LTC. INSTALLED BY HIM, AND DO ALL WORK NECESSARY TO ENSURE EFFICIENT AND PROPER FUNCTIONING, PRICE TO THE EXPIRATION OF THE GUARANTEE PERIOD, APPROXIMATELY IT MONTHS AFTER FINAL ACCEPTANCE OF THIS PROJECT, A POST CONSTRUCTION REVIEW OF THE
- 19 THE CONTRACTOR SHALL FURNISH PERSONNEL TO ASSIST THE OWNER IN THIS REVIEW ANY ADJUSTMENT'S REPAIRS OR REPLACEMENTS FOUND NECESSARY DURING REVIEW SHALL BE DONE BY THE CONTRACTOR, AT NO ADDITIONAL COST
- 20 THE FLECTIONS CONTRACTOR SHIFL BE RESPONSIBLE FOR AND SHALL PICUS
- IN THE BLOCTRICAL CONTRACTOR SHALL MAINTAIN AT THE SITE FOR THE CHINER. ONE COPY OF ALL DESIGNOS ACCENDE, APPROVAD SHOP DISAMINGS.
 INCORDE AND OTHER MODE ICATIONS, IN DOCUMENTAL MAD MARKED TO
 INCORD ALL DISAMINES MADE DURING CONSTRUCTION, THE SET OF DRAWINGS. AND OTHER INFORMATION SHALL BE OR LYERED TO THE DANGER AND CHIE DOP GIVEN TO THE ENGINEER LIPON COMPLETION OF WORK
- 22. ALL CONDUCTORS SHALL BE COPPER, CONFORMING TO THE LATEST
 BE LIBEREDITE OF THE NATIONAL ELECTRICAL CODE. STEHLEDLIFOR NO. 2 FINAL
 AND LARGER, BOLIC FOR NO. 10 AND AND EMALER.
- 25 ALL WANG SHALL BE INSTALLED IN CONOUT JEMT WITH STEEL COMPRESSION FITTINGS OR TYPE MC CABLE WHERE ALLOWED BY CODE: MINIMUM CONDUIT SIZE SHALL BE 3/4" ALL CONDUIT AND WIRING SHALL BE CONCEALED IN CEIUNGS AMODORWALE SALES SPECIFICALLY HOTEO DYNAMINE. DAMASE, EXETING
 WALLE WHERE BY USED WEDT WISE STUD ARE DISCOUNTS TO THE LACOF A NEW WINDOW CILLING, EVER SHALL SELECTED TAXE TO THE LACOF A NEW WINDOW DE CILLING, EVER SHALL SELECTED TAXE TO THE LACOF A NEW WINDOW DE CILLING, EVER SHALL SELECTED TAXE TO THE LACSHALL SELECTED.

 WHILE WHICH ARE PARALLEL AND PERPONDOLLAR WITH BUILDING LIVES.

ELECTRICAL LEGEND

POWER

NOTES: REPER TO ARCHITECTURAL GRAWNOS AND ELEVATIONS FOR EXACT

- WP WEATHER PROOF (HEMA 3R) ISOLATED GROUND
- GROUND FAULT INTERRUPTER
- WALL MOUNTED 204 DUPLEY RECEPTACLE (18" AFF DON)
- WALL ZOA UADRUPLEX RECEPTACLE /18" AFF UON-
- WALL WITD SPECIAL RECEPTACLE NEWS TYPE FER PLANS (2) PLOCE MOUNTED DIA CHERNING MEDICEPTACIE
 - CELING WOUNTED JUNCTION BOX
- 2
- D) DISCONNECT SWITCH - NON-FUSED FURED DISCONNECT BANTON FURE SOFT FEE PLANS
- O' COMMINATION STARTER/DISCONNECT SWITCH
- MOTOR REFER TO MECHANICAL PLANS FOR HORSEPOWER

GENERAL

INDICATES REVISION CLOUDED AREA CONTAINS THE REMISION

- SURFACE MOUNTED PANEL
- Overseen oncorrency on

A

- GROUND

ELECTRICAL LEGEND

ABBREVIATIONS

- A AMP AMPERES
 AB ABOVE
 AC ALTERNATE
 AFF ABOVE FINI
 ARCH ARCHITECT
 BEL BELOW
 BKR BREAKER
 CONDUCTOR ABOVE ALTERNATE CURRENT ABOVE FINISHED FLOOR ARCHITECTURAL, ARCHITECT GENERAL CONTRACTOR GROUND FAULT INRERRUPTER ISOLATED GROUND INCAND INCANDESCENT
 KAIC KILOAMP INTERRIPTING CUI
 AVA KILOVOLT AMPERES
 KW KILOMATTS
 LT(S) UG CEILING
- DIRECT CURRENT DISCONNECT SWITCH DISCONNECT SWITCH
- ELECTRICAL EMERGENCY NOT TO SCALE POLIPMENT
- FIRE ALARM CONTROL PANEL
 FIRE ALARM CONTROL PANEL
 FIRE ALARM ANNUNCIATOR PANEL
 FIXTURE
 FULL LOAD AMPERES

PROCESTED PLANSAGE.

INDICATES ROOM NUMBER

BRANCH CIRCUIT HOMERUN

DGS

DGS (DEPARTMENT OF GENERAL SEPACES)

ANCE BALLY & MAGOCIATES

CONSULTING STRUCTURAL ENGINEER

MODISEDROW AVENUE NAM AMERIKATON DE 20012 E 4 DITMA 2001 E 1200 MAS 2207

623) EVECUTIVE BULEVARD HORRIV BETHESDA WO 2011 2008 T THE RV DWG T NO 618-2449

MEV

AMT

10 G F (1922) NO SUITE 6 470 WASHINGTON DC 20092 F 62222 2014 656 F 6224 2016 9951

- CENTIMETER ENGLOSED WOLDED CASE ENFICH MECHANICAL MOUNTING HEIGHT
- MAIN LUGS ONLY MILLIMETER ELECTRICAL CONTRACTOR NOUNTED EXHAUST FAN NATIONAL ELECTRICAL CODE

- PANEL
 RECEITACLE
 ROOM
 TELL
 TYPICAL
 UNLESS OTHERWISE NOTED
 VOLTS
 WATTS
 WITH

LIGHTING

- NOTE REFER TO LIGHTING FIXTURE SCHEDULE FOR FIXTURE TYPE A CAPITAL LETTER ADJACENT TO FIXTURE HOICATES TYPE
- LOWER CASE LETTER INDICATES SWITCHING
- NOICHTEE NIGHT LIGHTING UNINNTO HET FIRTURE.
- BHADED CRICLE INDICATES / IXTURE ON EMERGENCY CRICLIT
- WALL MOUNTED FIXTURE
- OCT POLE MOUNTED PORTURE EMOLE HEAD
- EMERGENEY DATTERY PACILICAL FUTURE
- CELLINGAMALL MOLINTED EXIT SIGN SINGLE FACE PROVIDE DIRECTIONAL ARROWS PER PLANS
- CELENOVALL MOUNTED EXIT SIGN COURSE FACE, PROVOE
- DIRECTIONAL ARROWS PER PLANS
- 39A 1F. 120V TOOGLE TYPE USHT SWITCH
- SLY LOWYOUTAGE LIGHT SWITCH
- Sv
- TODGLE TYPE MOTOR STARTER WITH THERMAL DVERLOAD
- WALL MOUNTED OCCUPANCY SENSOR, WATTSTOPPER DW-100 DR ATTECNETIE: U.A. œ
- DUAL RELAY WALL MOUNTED DOCUMENCY SENSOR WATTSTOFFER EW-300 OR APPROVED E MAIL
- CEILING MOUNTED OCCUPANCY SENSOR WATTSTOPPER DT-355 OF 63
- APPROVED C UN.
- CELLING MOUNTED DAYLIGHT BEHOOR.
- HOH BIT LINE YOU AGE PASSIVE INFRINCED OCCUPANCY SENSOR 0 WITH PROTECTIVE GASE WATTETOPPER HEXIBLE WITH PROTECTIVE CASE OF MYSSOUTHE TIME

SUBMISSION SCHEDULE PERMIT SET

DATE

DATE

07-17-2015

- REVISION SCHEDULE
- NO DESCRIPTION

PROJECT:

DYRS GYMNASIUM RENOVATION

1000 MOUNT OLIVET ROAD, NE

SHEET TITLE:

ELECTRICAL COVER SHEET

PROJECT NO: 1310 JULY 17, 2015 SCALE:

SHEET NO:

E001




LIGHTING FIXTURE SCHEDULE

TYPE SYMBOL		DESCRIPTION MANUFACTURE	MANUFACTURER AND	D LAMP DATA			VOLTS	NOTES
TPE	21MBOL	DESCRIPTION	CATALOG NUMBER		NO. WATTS TYPE		VOLIS	NOTES
	9)	6" LED RECESSED DOWNLIGHT	ATLANTIC LIGHTING (LTN-CLP20-25 -2		20	160	277	MOTE 1
	_	LED STRIPS MOUNTED ABOVE ACQUISTICAL PANELS	CALI #1,849)*#XV*(LCD-35 03X)-5W DRY-XX*	:	6WFT	LEO	277	H\$18 1.22

- BEEL AND STEED THAT DE HANDE FOR KNICT LOCATION OF FUTURES.
- FINAL SELECTION OF LIGHT FIXTURE ARE TO BE PROVIDED BY THE ARCHITECT THESE POSTURES ARE SUGGESTED JICHT PATURE FOR THE APPLICATION INTERIORS.
 - FIXTURE LENGTH SHALL BE PER DRAWING COORDINATE WITH ARCHITECT FOR
 - EXACT SIZE COORDINATE WITH ARROHTECT FOR FINISH




7 EXISTING PANEL SCHEDULES

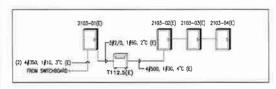

6 EXISTING PARTIAL RISER DIAGRAM




5 GYMNASIUM EAST ELEVATION

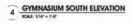



3 GYMNASIUM WEST ELEVATION

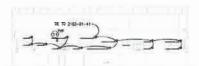

2 GYMNASIUM NORTH ELEVATION



0

 \bigcirc (3)

03

0

T1125-

ELEC ROOM 2103

(5)

(3) 2163-64-41 (B) 0,000

GYMNASIUM ELECTRICAL PLAN

GENERAL NOTES

REFER TO ECOI FOR CENERAL NOTES, SYMBOL LEGEND AND LIST OF ABBREVIATIONS

(I) SPECIFIC NOTES

- DISTING OTHERS HIM HID LIGHT FORTURES TO REMAIN. CONTINUATION SHALL CLEAN AND RE-LAWF ALL FORTURES (TYPICAL OF 15) AND SHALL LIMIES CERTAIN THAT ALL THE LIGHT FIXTURES ARE IN WORKING CROKEN, SEE HOTES 2 MID 3 BIELDIN FOR ADDITIONAL DISTINLS.
- THIS PIXTURE HAS NOISY BALLAST, CONTRACTOR SHALL REPLACE BALLAST.
- ROLL—UP DINDER WINCH MOTOR CROUIT, PROVIDE MOTOR RATED TOGGLE SWITCH AS SHOWN COORDINATE FINAL LOCATION WITH ARCHITECTURAL DRAWNOS, CONNECT TO MOT—LOCK SWITCH, SE NOTE 5 BELDER

- IS PROVICE DIMER SHITDLES FOR THE COMMUNITY "Y" MIS A".

- 13. PROVICE 3912, 19120 IN 3/4" CONCUT.

- 18. PROVIDE 2#10, 1#100 IN 3/4" CONDUIT.
- 19. REPLACE 20A/IP CIRCUIT BREAKER TO 30A/IP.
- 20. 20A PLISED DISCONNECT SWITCH, CCORDINATE EXACT INSTALL LOCATION IN FIELD.

DGS



AMT



SUBMISSION SCHEDULE DATE PERMIT SET 07-17-2015

DATE REVISION SCHEDULE

DYRS GYMNASIUM RENOVATION

1000 MOUNT OLIVET ROAD, NE WASHINGTON, DC 20002

SHEET TITLE:

GYMNASIUM ELECTRICAL PLAN

JULY 17, 2015 SCALE:



E101

STRUCTURAL NOTES

DESIGN LOADS

ROOF FLOOR

102 PYDIVLGADS

SROUND ENOW LOAD SNOW ENSORINE FACTOR THERMAL FACTOR SNOW IMPORTANCE FACTOR FLAT ROOF SNOW LOAD

3 LATERAL LOADS

NIND LOACE PER BC 200

LI, THATE DESCRIPTION OF SHEET CONTROL OF SHEET WAS DESCRIPTION OF SHEET WAS DESCRIPTION OF SHEET CONTROL OF 26 995 5 80 999

ANIMAC LONDS PER ISC 3013

COOME INDUSTANCE FACTOR
BIGGORIAN CONTROL STATEMENT ON THE CONTROL STATEMENT ON THE STATEME

SOL BEARING

MASONRY

TO JO CONDITTE HANDWAY SHALL, SHIPE ADELY IN ACCORDANCE WITH A STAIC HAS AND HAVE BETTY, SOUTH JULIES OTHERWISE HOUSE

to a 125 E# #0 123 6 51 -0 053 는da +C 박고 호 는d + 의 C58

DOZINARY RENFORSED MAGDINY SHEAR WALLS (ENDTING) ORDINAL REST ORDING
ORDINAL REST ORDING
SEQUENCE AT SERVE FORCE PROOBUILD

- 2 HOLLOW CONCRETE MASONRY UNITS SHALL BE SRACE VI CONFORMING TO ASTY C-90
- 3 CONCRETE HAS CARY UNITS 5HALL 39 WITH LIGHT CONCRETE
- 4 PL HORT SEARCE STARS ELOCA START OF START STAR
- E PRONIDE A MINIMUM OF 3 COURSESS OF MOUD BRICK OR ONE COURSE IOON SOUD BLOCK UNDER WALL BEARINGS ENDS OF ALL JOSTS AND BLASS THE FUL. WIDTH OF THE WALL, JALESE NOTED.
- E. PROVIDE 100% BOLD MASOVRY DOWN TO PODTINGS BELDW GRACE AND UNDER ALL BEAMS AND UNITED BEARNS ON MASOVRY, LINLESS NOTED
- N BEARNG WALLS PROVIDE SOUD BRICK OR 100% SOUD CONCRETE BLOCK ENTENDING & BEYOND WALL DEMINISS THE FULL WALL THICKNESS DOWN TO THE FLOOR, LINLESS NOTED.
- 8 ALL FORTIONS OF BEARING WALLS HAVING A HORIZONTAL CROSS SECTION OF JISD FT, OR LESS SHALL BE OF SOUIC MASONRY DOWN TO FOOTINGS
- 9. PROVOE HORZONTAL MASONRY REINFORCING AT 16 O.C. IN ALL MASONRY WALLE LINESSE NOTED
- TO THEN OF LETTICAL CONTROL FORTON ALL MAKENING WHALE BROCKET DE LINESSONETIES
- 11 AL MORTAR JOINTS IN MASONRY WALLS INCREDICTAL & VERTICAL) SHALL 35 FLLED 100% WITH MORTAR IS SHOUT SHALL BY SAVO AND CITIENT & BASIS OF CITIENT PRINCIPION WAS
- 12 PROVIDE MASONRY TES BETWEEN I BRICK VENEER WALL INDITIES STILL STUD WILL AS 125 F ST VERTICAL AND 24 FOR CONTAL

STRUCTURAL STEEL

- # SHALL BEIN ACCORDANCE WITH THE LATEST AREC SPECS FOR DESIGN PABRICATION AND ERECTION OF STRUCTURAL STEEL FOR BULLINGS.
- L STRUCTURAL STEEL SHALL CONFORM TO ASTM ASSIS SPACESO, STRUCTURAL TURING SHALL CONFORM TO ASTM ASSO SRACE BIAND STEEL FIFE COLUMNS SHALL CONFORM TO ASTM ASSO
- MELDING SHALL BE CONE IN ASCORDANCE WITH THE WINDOWS OF STREET STORE SHALL BE CONE OF STREET STORES ARE ARE SANGUED IN BUILDING SOND TRUET AND STORES THE STORES ARE SANGUED IN BUILDING SOND TRUET AND STORES THE STORES ARE SANGUED IN BUILDING SOND TRUET SOND TRUET STORES ARE SANGUED IN BUILDING SOND TRUET SOND TRUET STORES ARE SANGUED IN BUILDING SOND TRUET SOND CHATTED WELDERS DN.Y.
- 4 SHOP AND RELD CONNECTIONS SHALL BE WELDED OR MAGE WITH 3 4" STEEL HIGH STRENGTH BOLTS IN ACCORDANCE WITH ASTMINASE OR AUGO
- SURPRIMARILEMS, SPECIAL PROCESSION ROLLOW ACT CONTROL AND PROCESSION AND PROCESSION OF THE PROCESSION
- 6. NO HOLDS 2-ALL TELEGRAPHIC IN FLANCISTS OF THE VYOLUNGESS IMPROVED SMITH ENCASES.
- THE OWNER SHALL RETAIN THE SERVICES OF A QUALIFIED INSPECTOR TO INSPECT ERECTED STEEL, AND CONNECTIONS
- 5 NO FELD CUTTING OF THE STEEL HEMBERS SHALL 36 FERHITTED WITHOUT FACE A JIH GROWTON OF THE STRUCK RAL ENGINEER
- B PROVIDE STEEL SICREEN ANGLES ALONG BODE OF CONCRETE SLAB WHERE RESURED
- 10 ALL STEEL TO BE FERMANENTLY ENFOSSION TO WEATHER OR SIZE SHALL BE HOT OP SALVANGED
- BUBHT FOR APROVALAL STEE, SHOP CRAMINGS AND CALCLARIONS SOMED AND SEALED BY A ROTESSON ALL SANDLER REGISTERED IN THE BLUTCH GROUND ALL DWITWO WESAS FOR THE REMAINS.
- ALL SEAM CONNECTION SHALL SE DESIGNED FOR THE HANMUM SHEAR CAPACITY
- 22 ALL Y. L. PENTENTON WILES SHALL SE TESTIO SY LUTENOVICHENCO
- THE SPECKGATONS JUST WANTED
- 15 ALL STEEL BRECTION SHALL BE COMPLETED INCLICING ALL BRACING BEFORE OTHER TRACES START THEIR WORL
- IR. NA STOP PLATE O- NA SEE THIS.

PRE-EXISTING CONDITIONS

SENSIAL CONTRACTOR SHALL FIELD MEASURE LOCATION OF ALL EVISTIAS CONDITIONS, AND NUTEY ARCHITECT OF ANY DISCREPANCES

- INSPECTION FOR ALL STRUCTURAL TOTAL OF THE NOTICE OF THE APPLICABLE BUILDING COTTO.
- 2 THE DWINERS TESTING ASSISTS SHALL PERFORM ALL INSPECTIONS AND TESTING
- 2. ALL CONCRETE WORK EHOUND ON THESE DRAWNES AND SPECIFIED IN THE EFFICIFICATIONS SHALL BE INSPECIFIED IN ACCORDANCE WITH ACLISIS QUITEST EDITION, CORRES OF RELD REPORTS CONCRETE MIXES CONLINED TESTS AND DIMES DATA SHALL SE SENT TO THE ACKNITICET ENCINERA AND DIMINISE.
- ALL TIGHT AND LAST TISTING OF CONCRETE SHALL CONCRET TO THE LANGET ARRESTED REPROPERTY.

GENERAL

- ALL DETAIL SECTION AND NOTES SHOWN ON DRAWINGS ARE INTENDED TO SETYPICAL AND SHALL APPLY TO SMILAR STUATIONS SLEEWHERE LINESS NOTED.
- 2 DONOT DONE DAMANOS
- 3 REFER TO ARCHITECT, AND MECHANICAL DRAWINGS FOR LOCATIONS AND DIFFERENCE OF OPENINGS SLEDY BS, 2005 REVIEWS FINANCE DEPRESSIONS DOOR AND DIFFER SUCH PROJECT GROUPEMENTS NOT SHOWN DAYSING, CT. ALL, ZNAWINGS.
- 4 CONTRACTOR SHALL PROVIDE TEMPORARY BRACING AS REQUIRED TO PROPERLY CONSTRUCT THE SULDING
- 3 AL HANSES FOR MEIONA ICAL PRINS, DUCTIVORIC, AND EQUIPMENT SHALL SECON REGISER TO THE STRUCTURAL MEMBERS THE HANSERS SHALL SELOCATED SLOT HAND DO NOT PRODUCE EQUIVALENT LINEOZAL CARD CARD MORE THAN SI POR SUBMIT SHOP DRAWNOSS FOR HANSER YOR AND LAYOUT FOR ARROYS AND LAYOUT FOR
- E. PROMDE ALL CUPS INSERTS TRIS ANCHOR STRAPS HANGERS, BOUTS AND OTHER PASTENERS AS RECURSO.
- THE CONTRACTOR SHALL VERPY ALL DIMENSIONS PROR TO STARTING CONSTRUCTION AND ANY DISCREPANCY SHALL BE BROUGHT TO THE ATTENTION OF THE ARCHITECT
- 8 NO PART OF THE BUILDING SHALL BILLUGED AS A STAYING AREA RESULTING IN A LOAD JUNDER THE LIMITED LOADED AREA] THAT ENGLISES 75% OF THE DESIGN SINE LOAD
- \$ WILL TORMANON, AND SHORN J SEQUENCE THE KESPONEBULTY OF THE SON TRACTION

SYMBOLS



NEW FOOTNG

AR4 25A* EX EXETING BEAM

MEW DIET





WELD SYMBOL





ABBREVIATIONS

MODERO, T ADDITIONAL ADDITIONAL BANKE BANKE BOTTO CONTES, LON' CONTES, DIA DWG DWLS EA EA EA TOWNER TO COMMENT TO THE TOWNER TO THE TOWNER TO THE TOWNER TO THE TOWNER TOWNE 40202523435FF40# EXECUTO STREET BORDERS

WELSEE WAR HEAR

TMENT OF GENERAL SERVICES)



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CONSIST TRAIL SECTION ENGINEER
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D.OBA, ENGINEERING SOLUTION

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DATE SUBMISSION SCHEDULE NO DESCRIPTION

REVISION SCHEDULE

NO DESCRIPTION

DYRS GYMNASIUM RENOVATION

WASHINGTON, DC 20002


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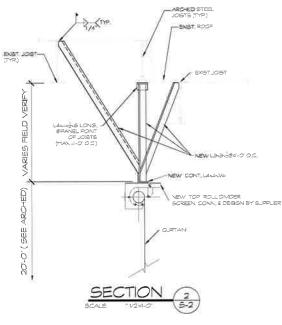
SHEET NO:

STRUCTURAL NOTES

PROJECT NO: -JULY 17, 2015 SCALE: AS NOTED

DATE



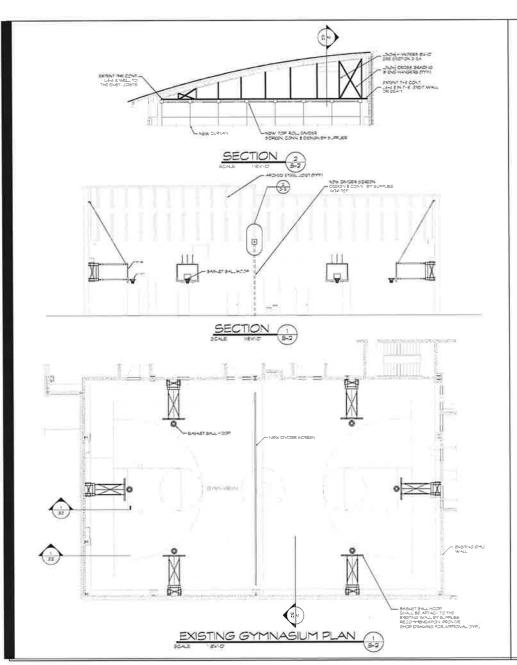



REVISION SCHEDULE	DATE
NO DESCRIPTION	

DYRS GYMNASIUM RENOVATION

1000 MOUNT CLIVET ROAD, NE WASHINGTON, DC 20002


SUBMISSION SCHEDULE


SHEET TITLE:

FLOOR PLAN & SECTION

PROJECT NO: —
JULY 17, 2015
SCALE: AS NOTED

S-2

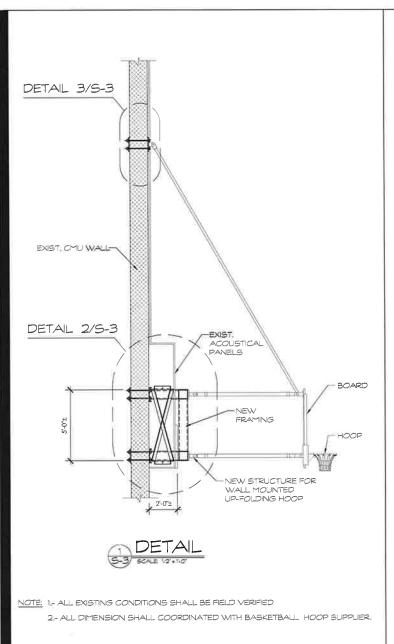

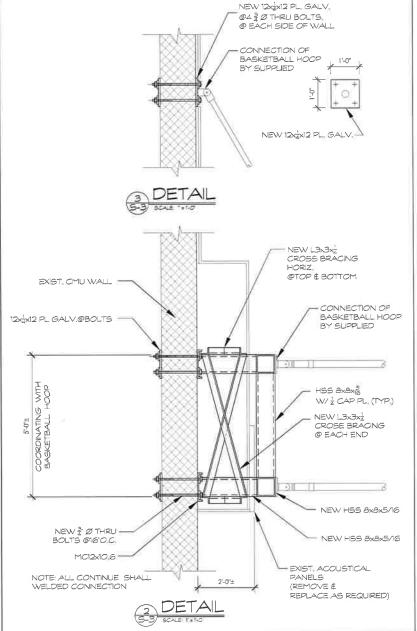

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DGS (DEPARTMENT OF GENERAL SERVICES)

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SUBMISSION SCHEDULE

NO DESCRIPTION

REVISION SCHEDULE

DYRS GYMNASIUM

SECTION & DETAIL

RENOAVTION

PROJECT NO: -

SCALE: AS NOTED

JULY 17, 2015

SHEET NO:

1000 MOUNT OLIVET ROAD, NE WASHINGTON, DC 20002

NO DESCRIPTION

PROJECT:

DATE

S-3

AMT

VICINITY MAP



LOCATION MAP



- THE SCOPE OF WORK OF THIS PROJECT IS LIMITED TO IMPROVING THE FXISTING COURTYARDS OF THE EXISTING BUILDING MARKED AS COURTYARD #1 AND COURTYARD #2.
- EXISTING BUILDING IS UNTOUCHED IN COURTYARD IMPROVEMENTS,
- THE SCOPE OF WORK IN THE CORTYARD INCLUDES CREATING A 10'-0' WINDE AND 110' F HOUR OFFINING IN AN DESTING 35'-9' LOW AND 30'-9' HOUR HOULD LOAD BEARING MASONINY DIVIDING WALL BETWEEN COURTYARD BY AND COURTYARD ZETEMPORARY SUPPORTS FOR NEW LINTELS WILL BE INSTALLED AND INDICATED ON THE STRUCTURAL DRAWINGS, A ROLL UP GRILLE IS PROVIDED AT THE OFFINING TO EMBLE SECURING COUNTYARD #1 IN CASE IT IS REQUIRED.
- 4. AT THE END OF THE COURTYARD #2 EXISTING FENCE WALL AND DOOR ARE REPLACED BY A 25'-9' LONG AND 15'-0' HIGH MASONRY WALL WITH AN ALARMED EXIT DOOR AND SECURITY GRILLE.
- ARCHITECTURAL, STRUCTURAL, CIVIL, LANDSCAPING AND ELECTRICAL IMPROVEMENTS ARE INDICATED ON EACH DISCIPLINE DRAWINGS.

BUILDING DATA: THE SCOPE OF WORK IS LIMITED TO COURTYARDS ONLY AND NO WORK IS CARRIED INSIDE THE BUILDING.

THE FOLLOWING CURRENT CODES GOVERN THE DESIGN CRITERIA:

2012 INTERNATIONAL BUILDING CODE, 2012 INTERNATIONAL PLUMBING CODE 2012 INTERNATIONAL ENERGY CODE 2012 INTERNATIONAL FIRE CODE 2011 NATIONAL ELECTRIC CODE 2011 NEPA 101 LIFE SAFETY CODE

JURISDICTION: DISTRICT OF COLUMBIA

1000 MOUNT OLIVET ROAD, NE WASHINGTON DC 20002 BUILDING LOCATION:

BUILDING DESCRIPTION:

THE EXISTING BUILDING IS A THREE STORIES MASONRY BUILDING AROUND THE OURTYARDS AND IS USED AS YOUTH REHABILITATION SERVICES (DYRS), NO WORK IS BEING DONE INSIDE THE BUILDING.
THE USE OF THE COURTYARDS IS FOR FULLY SUPERVISED AND CONTROLLED EXTERIOR

ACTIVITIES FOR RELAXATION, SMALL GROUP MEETINGS, DISCUSSIONS AND PLAY

USE GROUP: GROUP B (ACCESSARY TO THE MAIN BUILDING)

NOT APPLICABLE BUILDING AREA: NOT APPLICABLE TYPE OF CONSTRUCTION: NOT APPLICABLE TYPE OF SPRINKLER-

ALLOWABLE STORIES AND HEIGH; NOT APPLICABLE

OCCUPANT LOADING: LESS THAN 50 (SIGNAGE LIMITING THE OCCUPANT LOAD TO 49 IS INS

LIST OF DRAWINGS

COVER SHEET & LIST OF DRAWINGS ABBREVIATIONS & SYMBOLS GENERAL NOTES

C-1.0 C-2.0 C-3.0 C-3.1 C-3.2 C-4.0 C-4.1 C-4.2 C-5.0 C-6.0 C-6.1 C-6.2 C-6.3 C-6.4

COVER SHEET
EXISTING CONDITIONS PLAN
DEMOLITION PLAN
EROSION AND SEDIMENT CONTROL PLAN

EROSION AND SEDIMENT CONTROL NOTES EROSION AND SEDIMENT CONTROL DETAILS SITE DEVELOPMENT PLAN

SITE GEOMETRY LAYOUT PLAN AND DETAILS DETAILS

SITE GEOMETRY LAYOUT PLAN AND DETAILS DETAILS HARDSCAPE DETAILS SITE UTILITY PLAN STORMWATER MANAGEMENT PLAN STORMWATER MANAGEMENT DETAILS STORMWATER MANAGEMENT DETAILS STORMWATER MANAGEMENT DETAILS STORMWATER MANAGEMENT CALCULATIONS STORMWATER MANAGEMENT MANTENANCE SCHEDULES STORMWATER MANAGEMENT MANTENANCE SCHEDULES


ARCHITECTURE
AE-01 EXISTING FLOOR PLAN & SCOPE OF WORK

AD-01 DEMOLITION PLAN A01-01 COURTYARD PLAN

A01-02 WALL OPENING & DETAILS
A01-03 DETAILS
A01-04 WALL PLAN, ELEVATION, SECTIONS, & DETAILS

S-1 STRUCTURAL NOTES
S-2 PROPOSED FOUNDATION & WALL PLAN
S-3 SECTIONS & DETAILS
S-4 SECTIONS & DETAILS

ELECTRICAL
E001 ELECTRICAL COVER SHEET
E101 COURTYARD ELECTRICAL PLAN

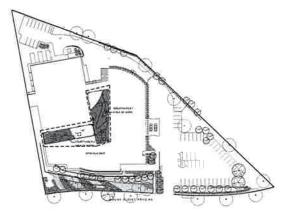





YOUTH SERVICES CENTER **COURTYARD** RENOVATION

1000 MOUNT OLIVET ROAD, NE WASHINGTON, DC 20002

CONSTRUCTION DOCUMENTS

OCTOBER 12, 2015

PROJECT TEAM



DEPARTMENT OF GENERAL SERVICES (DGS)

1250 U STREET, NW 4TH FLOOR WASHINGTON: DC 20009



LANCE BAILEY & ASSOCIATES, INC.

7800 GEORGIA AVENUE, NW., STE # 308 WASHINGTON, DC 20012 T: (301) 585-2283 F: (301) 565-2287 www.longotility.com



CONSULTING STRUCTURAL ENGINEER

MECHANICAL ELECTRICAL PLUMBI



GLOBAL ENGINEERING SOLUTION

CIVIL ENGINEERING





SHEET TITTLE

COVER SHEET & LIST OF DRAWINGS

PROJECT NO SUBMISSION DATE

SHEET NO DATE OF ORIGIN: AUGUST 20, 2015

CS-01

ABBREVIATION

ABOVE CIVIOUS CLOSES	AFF	DEPTH	DPT.
ABOVE FINISH FLOOR	ACCOM.	DETAIL	DET.
ACCOMODATE		DIAMETER	Ø.
ACCOUSTICAL	AC.	DIMENSION	DIM
ACCOUSTICAL TILE	AT,		DR.
ADJUSTTABLE	ADJ	DOOR	
ADJACENT	ADJ		DN.
ALTERNATE	ALT.	DOWN SPOUT	DS.
ALUMINUM	ALUM.		DL.
ANCHOR BOLT	AB.	DRAWING	DWG.
AND	å		
ANGLE	L	EAST	E.
APPROXIMATE	APPROX_	EACH	EA.
ARCHITECT	ARCHT.	ELECTRICAL	ELECT.
AREA DRAIN	AD.	ELECTRICAL WATER COOLER	EWC.
ASBESTOS	ASB.	ELEVATION	EL/ELEV.
ASPHALT	ASPH.	EMPLOYEE	EMP.
ASSISTANT	ASSIST	EQUAL	EQ.
ASSOCIATE	ASSOC	EQUIPMENT	EQUIP.
AT	@	EXHAUST	EXH.
•••	•	EXISTING	EXIST.
BASEMENT	BSMT.	EXPANSION BOLT	EXP.BT.
BATHROOM	В.	EXPANSION JOINT	EJ.
BEAM	BM	EXTERIOR	EXT.
BEARING	BRNG	EXTERIOR INSULATED FINISH	EIFS.
BED ROOM	BR.	SYSTEM	
BEYOND	BYND.	OTOTEM	
BITUMINOUS	BIT.	FACE OF COLUMN	FC
BLOCK	BLK.	FACE OF FRAME	FF.
BLOCKING	BLKG	FACE OF MASONRY	FM.
BOARD	BD	FACE OF WALL	FW.
BOLTS	BT.	FINISHED	FIN
BOTTOM	BOT.	FIRE EXTINGUISHER	FE.
BOTTOM OF WALL	BUI.	FIRE EXTINGUISHER CABINET	FEC.
	BRK.	FIRE PROOFING	FP.
BRICK	BLDG.	FIXTURE	FIX
BUILDING	вше,	FLASHING	FLASHG
	CAB	FLOOR	FL.
CABINET		FLOOR DRAIN	FD.
CAULKING	CLKG. CLNG	FOOT/FEET	FT.
CEILING			FTG
CEILING SPACE	C.S.	FOOTING	
CENTER LINE	CL	FOUNDATION	FDN.
CENTER TO CENTER	CC.	FREE AJR	FA.
CERAMIC	CER.	FREEZER	FRZR.
CERAMIC TILE	CT	FURNITURE/FIXTURE/EQUIPMENT	F/F/E.
CHANNEL	[-		
CLEAR	CLR.	GALVANIZED	GALV.
CLOSET	C/CL	GENERAL	GEN.
COLUMN	COL	GLASS	GL
COMMUNICATION	COMM	GRADE	GD.
CONCRETE	CONC.	GYPSUM	GYP.
CONCRETE MASONRY UNIT	CMU	GYPSUM WALL BOARD	GWB.
CONDITION	COND,		
CONSTRUCTION	CONST	HARDWARE	HDW.
CONTINUOUS	CONT.	HANDICAPPED	HC.
CONTRACTOR	CONTR	HIGH POINT	HP.
CONTROL JOINT	CJ	HEIGHT	HGT.
COOLER	CLR	HOLLOW METAL	HM.
			HORIZ.
COUNSELOR	COUNS	HORIZONTAL	NURIZ.
	COUNS, CFLG	HORIZONTAL HOUR	HR

1011	
INCH	"/IN
INCLUDED	INCL
INFORMATION	INFO
INFORMATION IMPACT RESISTANT GYPSUM BOARD	IRGB
INSIDE DIAMETER/DIMENSION	ID.
INSULATION	INSUL
INTERIOR	INT
JANITOR'S CLOSET	JC
JOINT	JT
JUNCTION	JCT
KITCHEN	K.
KITCHEN/LAUNDRY	K/L
LAVATORY LENGTH, LOUVER LIGHT LIGHT WEIGHT LOCATION LOCKERS LOW POINT LONG LEG VERTICAL LAMINATED VENEER LUMBER	LAV L.T. LTWT LOC LOC LP LLV LVL
MACHINE MANAGER MANUFACTUREIR MASONRY, MASON MASONRY OPENING MATERIAL MAXIMUM MECHANICAL METAL MINIMUM MISCELLANFOLIS	MACH, MGR, MFR, MAS, MO, MATL, MATL, MECH, METAL, MIN, MISC.

MISCELLANEOUS MOP BASIN

NORTH NOT TO CONTRACT NOT TO SCALE NUMBER

OFFICE
ON CENTER
OPENING
OPPOSITE
ORIENTED STRAND BOARD
OUTSIDE DIMENSION

ĹŤ.	
LTWT:	RADIUS
LOC	RECREATION
LOC	REFRIGERATOR
	REINFORCING
LP. LLV.	REQUIRED
	ROOF
LVL,	
	ROOF DRAIN
	ROOM
MACH,	SCHEDULE
MGR.	SECTION
MFR.	SHEET
MAS	SHOWER
MO.	SIMILAR
MATL.	SOUTH
MAX,	SPECIFICATION
MECH	SQUARE
METAL	SQUARE FOOT/FEET
MIN.	SQUARE INCH
MISC	START POINT OF THE CEILING
MB	STEEL
	STORAGE
N.	STRUCTURE
NTC.	SURFACE
NTS	OUT ACC
NO./#	
NODE	TELEPHONE
OFF.	THRESHOLD
OC.	THROUGH
OPNG	TILE/TOP
OPP.	TOILET
OSB.	TOP OF CURB
OD.	TOP OF JOIST
	TOP OF PARAPET
	TOP OF STEEL
	TOP OF WALL
	TOP AND BOTTOM
	TYPICAL

PAINT
PAINTED
PAIR
PAIR
PAIR
PAIR
PERCENT
PLASTIC VALL COATING
PLASTIC VALL COATING
PLASTIC VALL COATING
PLATE GLASS
POINT
POUNDS
POUND PER SQUARE INCH
PRECAST CONCRETE
PROJECTION

QUARRY TILE

PNT PTD PR PARA,

% PLAM PWC PL PLMB'G

PLMB'G PLYWD PL, GL. PT, LBS PSI PRE_CONC PROJ

Q.T.

R REC. REF. REINF. REQ.D. RF. RD. SCH. SECT. SHW. SIM. S. S. C. S.

TEL THR. THRU.

T.
TOIL/T
TC.
TJST
TOP
TOS
TOW/TW
T & B
TYP

UNO

VAPOR BARRIER
VENTILATION/VENTILATO
VENDING MACHINES
VERIFIED IN FIELD
VERTICAL
VESTIBULE
VINYL COMPOSITE TILE
WATER CLOSET
WATER PROOF
WEIGHT
WEST/WITH
WIDE FLANGE
WIDTHWASHER
WITHOUT
WOOD

DGS (DEPARTMENT OF GENERAL SERVICES)

USEN (DEPARTMENT OF GENERAL SERVICES)

WASHINGTON, DC 20009

LANCE BAILEY & ASSOCIATES

7800 GENERA WASHINGTON, DC 20010

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ELECTRICAL ENGINEER

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GLOBAL ENGINEERING SOLUTION 522 WISCONSIN AVENUE, NV. SUITE 300 WASHINGTON ID (2001) 1, (200) 495-7148 P. (200) 495-7147

10 G STREET, NE SUITE # 430 WASHINGTON, DC 20002 T; (202) 289-4545 F; (202) 289-5051



SUE	MISSION	SCHEDULE	DATE
NO	DESCRIP	TION	
REV	ISION SC	HEDULE	DATE
NO	DESCRIP	TION	
PRO	OJECT:		
Ċ	OURT	I SERVIC YARD 'ATION	ES CENTER
		OLIVET ROAD, NE N, DC 20002	
SHE	ET TITLE:		
ΑE	BREV	IATIONS 8	SYMBOLS
PRO	DJECT NO:	1310	
	DJECT NO: TOBER 12,		
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G-01


MATERIAL INDICATIONS

111112	BRICK MASONRY	$\geq \leq$	(CONTINUOUS)
42	FIRE RATED CMU WALL UL#U905		ROUGH LUMBERWOOD BLOCKING (DISCONTINUOUS)
	RIGID INSULATION		PLYWOOD
	MORTAR/GYPSUM/EIFS		EARTH
	CONCRETE	**************************************	BUT INSULATION
	CMU MASONRY		STEEL (LARGE SCALE)
#	GLASS	XIVICYT	CARPET
	DRYWALL PARTITION		SPLIT FACE CMU/SGFT
TTC	CAULKING		CERAMIC/QUARRY TILE
888	GRAVEL		EXISTING WALL & SLABS (PLANS & SECTIONS)

SYMBOLS

	SYMBULS
ė,	HANDICAPPED STANDARD
7) 5°	CHANGE IN ELEVATION OF CEILING, FLOOR ETC.
01	ROOM NUMBER
01	STOREFRONT/CURTAIN WALL DETAIL NUMBER
◆ EL.107.00	ELEVATION DESIGNATION
A	GLAZING TYPE
(A)	FIXTURE ACCESSORY NUMBER
₫	WALL TYPE
CAY	ALIGN
●	DOOR NUMBER
100	EXISTING DOOR & FRAME NUMBER
	DOOR & FRAME NUMBER

UNLESS NOTED OTHERWISE

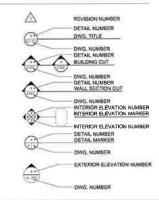

GENERAL NOTES

THE FOLLOWING NOTES ARE APPLICABLE FOR THIS PROJECT. PROJECT COMPRISES OF IMPROVEMENTS AT THE INTERIOR COURTYARD #1, PROJECT CONSISTS OF CMIL, LANDSCAPING, STRUCTURAL, ARCHITECTURAL, MECHANICAL, ELECTRICAL, AND PLUMBBING WORK ONLY.

- SITE VERIFY ALL EXISTING DIMENSIONS AND CONDITIONS INDICATED ON EXISTING CONDITIONS DRAWINGS, PRIOR TO FABRICATION AND/OR INSTALLATION OF THE NEW WORK UNDER THIS CONTRACT.
- 2. ABBREVIATIONS THROUGHOUT THE CONTRACT DOCUMENTS ARE TO BE READ SIMILARLY WITH OR WITHOUT PERIODS
- 3. ALL WORK SHALL BE PERFORMED IN STRICT ACCORDANCE WITH LOCAL AND NATIONAL CODES AND STANDARDS, ANY ITEMS REVISED IN THE CONTRACT DUCUMENTS THAT CONFLICT WITH CODES ARE TO BE NOTED PRIOR TO BIDS,
- 4. ITEMS AND CONDITIONS NOTED OR DETAILED ARE APPLICABLE AND BINDING TO SIMILAR CONDITIONS ON ALL DRAWINGS, FOR CONDITIONS OFF NOTED OR DETAILED, CONTRACTOR SHALL PROVIDE MATERIAL AND LABOR OF EQUAL QUALITY AND PERFORMANCE TO OTHER SIMILAR CONDITIONS ON THE JOB.
- 5. REFER TO CIVIL, PLUMBING AND ELECTRICAL DRAWINGS FOR ADDITIONAL NOTES PERTAINING TO THEIR PARTICULAR TRADES AND FIELD CHECK AGAINST ANY CONTROL BY WAYNESS, CABERAL CONTRACTOR SHALL CONTRACTAR WORK OF ALL TRADES & REPORT TO THE ACHITECT ANY CONFLICTS BETWEEN EXISTING CONDITIONS AND NEW WORK, PROIGE TO THE FABRICATION AND INSTALLATION OF NEW WORK.
- ANY AREAS OR SPACES NOT CLEARLY DEFINED OR INDICATED BY NOTES SHALL BE REVIEWED WITH THE ARCHITECT PRIOR TO PROCEEDING WITH ASSUMPTIONS. BIDS ARE TO ACCOMMODATE MOST STRINGENT SCENARIO/OPTION/ASSUMPTION.
- 7, ELECTRICAL SWITCHES, QUITLETS OR OTHER WALL MOUNTED ACCESSORIES SHALL BE INSTALLED IN LOCATIONS WHICH ARE SHOWN ON DRAWINGS, CONTRACTOR TO COORDINATE LOCATIONS PRIOR TO FABRICATION AND INSTALLATION OF ANY RELATED ITEMS IN CASE OF AMBIGUITY CONSULT WITH THE ARCHITECT;
- 8. ELECTRICAL SWITCHES, EXPOSED ELECT. ITEMS OR OTHER ELECTRONIC CONTROLS IN THE NEW WORK SHALL BE MOUNTED AT THE SAWE HEIGHT FROM ELOCK AS EXISTING IN A LINDROWN CODERLY FASHION ALL SUCH ITEMS AND SHOWN ON DWGS. EXISTING LOCATION OF ALL ITEMS ARE TO BE CONFIRMED WITH ARCHITECT ON SITE PRIOR TO INSTALLATION.
- ALL COLORS AND FINISH MATERIALS TO BE APPROVED BY THE OWNER AND THE ARCHITECT. BIDS ARE TO ACCOMMODATE SELECTION FROM MFGRS FULL RANGE OF COLORS, FINISHES AND FABRICATION.
- 10. DIMENSIONS FOR ALL WALLS SHOWN ON PLANS ARE NOMINAL. THE CONTRACTOR SHALL USE ACTUAL DIMENSIONS SHOWN ON WALL TYPES SHEET FOR CONSTRUCTION, DO NOT SCALE DRAWINGS.
- 11. DIMENSIONS AT MASONRY WALLS ARE TO FACE OF WALL, U.O.N.
- 12. CONTRACTOR SHALL APPLY FOR, PAY FOR, AND OBTAIN ALL NECESSARY PERMITS OTHER THAN THE BUILDING PERMIT
- 13. CONTRACTOR SHALL DISCONNECT AND CAP ALL UTILITIES THAT WILL BE AFFECTED BY WORK UNDER THIS CONTRACT PRIOR TO BEGINNING ANY WORK ON THIS PROJECT, RECONNECT AS REQUIRED FOR FULLY FUNCTIONING SYSTEMS.
- 14, CONTRACTOR SHALL PROTECT EXISTING BUILDING AND ELEMENTS FROM DAMAGE DURING DEMOLITION AND CONSTRUCTION INDICE THIS CONTRACT, IN CASE OF ANY DAMAGE, CONTRACTOR SHALL CORRECT THE DAMAGE TO THE SATISFACTION OF THE ARCHITECT AND THE OWNER, AT NO COST TO THE OWNER,
- 15. UNLESS NOTED AS EXISTING OR RELOCATED, ALL CONSTRUCTION IS TO BE ASSUMED NEW AND FURNISHED AND INSTALLED BY THE CONTRACTOR
- 16. ALL WORK SHALL BE IN COMPLIANCE WITH ALL APPLICABLE CODES AND GOVERNMENT RECILLATIONS INCLUDING BUT NOT LIMITED TO BE OXIZ. WHERE SPECIFIED OR BIOLOTISE BEQUIREMENTS OF MORE CURRENT VERSIONS OF CODES, REGULATIONS, ETC. CONFLICT WITH THAT OF THE DC GOVERNMENT, THE MOST STRINGENT OF THE TWO SHALL GOVERN.
- 17. CONTRACTOR TO BECOME FULLY FAMILIAR WITH CONTRACT DOCUMENTS PRIOR TO BIDDING, ANY ABBREVIATIONS, TYPOS, LANGUAGE MIS-USES, UNFAMILIAR TEXT, NOTES, WORKDINESS, DETAILS, ETC NOT UNDERSTOOD SHOULD BE BROUGHT TO THE CONTRACTING OFFICER'S ATTENTION PRIOR TO BIDDING.
- 18. DRAWINGS ARE TO PROVIDED FOR DESIGN INTENT, CONTRACTORS BID SHALL INCLUDE VERIFYING EXISTINGCONDITIONS AND MAKING NECESSARY ADJUSTMENTS TO THE SATISFACTION OF THE OWNER/ARCHITECT.
- 19. COORDINATE SITE ACCESS, STAGING, STORING, MATÉRIALS, WORK HOURS, WITH THE DGS PROJECT MANAGER PRIOR TO BIDDING.



DGS (DEPARTMENT OF GENERAL SERVICES) 1250 U STREET, NW WASHINGTON, DC 20000



LANCE BAILEY & ASSOCIATES 7800 GEORGIA AVENUE, N WASHINGTON, DC 20012

STRUCTURAL ENGINEER



CONSULTING STRUCTURAL ENGINEER NORTH BETHESDA MD 20852-3909 T: 301-616-0648 P: 301-616-0649

FLECTRICAL ENGINEER

GES

GLOBAL ENGINEERING SOLUTION 5225 WISCONSIN AVENUE, NW, SUITE 30 WASHINGTON, DC 20015 T; (202) 495-7745 F; (202) 495-7747

CAN ENGAGER





SUBMISSION SCHEDULE DATE NO DESCRIPTION REVISION SCHEDULE NO DESCRIPTION

YOUTH SERVICES CENTER COURTYARD RENOVATION

1000 MOUNT OLIVET ROAD, NE WASHINGTON, DC 20002


SHEET TITLE:

PROJECT:

GENERAL NOTES

PROJECT NO: 1310 OCTOBER 12, 2015 SCALE: AS NOTED SHEET NO:

G-02

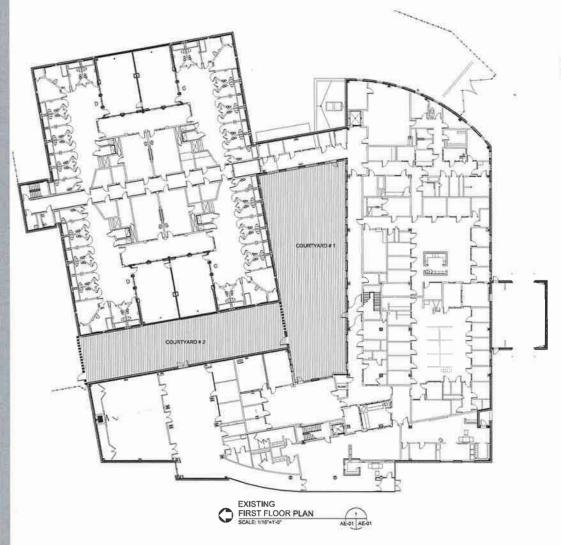

LEGEND GENERAL SCOPE OF WORK

COURTYARD 1 & 2 (AREA OF WORK)

1. WALLS:

RESIME WALL BETWEEN TWO COURT YARDS WILL

RESIMEN AND BE STRUCTURALLY MODIFIED AND

ARCHITECTURALLY REPARADE MOTORIZED METAL

ROLL UP GRILL WILL BE PROVIDED IN THE

OPENING, LARGE OUTDOOR TV WILL BE INSTALLED ON COURT YARD 2 SIDE OF THE WILL BETWEEN COURTYARD 1 AND COURTYARD 2. SEE SHEET 2/40-102 PROVIDE NEW SITE FURNISHINGS INCLUDING SEATING, TABLES, PILLARS, ET, CT, CT, EXISTING ELEMENT IN CONFLICT WITH THE NEW DESIGN IST OB ERMOYDED.

COURTYARD 1 IS TO BE UPGRADED WITH NEW LIGHTIMS AND PAYEMENT. 2, OUTDOOR TV: 3. SITE FURNISHINGS: STRUCTURAL ELEMENTS

1. WALLS; NEW OPENING TO BE CREATED IN THE EXISTING WALL BETWEEN THE COURTYARD I & COURTYARD 2 AND A NEW WALL TO BE CONSTRUCTED AT THE END OF COURTYARD 2 NOTE 1 SEE DÉTAILED SCOPE OF WORK ON THE DRAWINGS.

DGS

DGS (DEPARTMENT OF GENERAL SERVICES)
1250 U STREET, NW.

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7600-DDOMORE AVENUE, NAV. WRISHINGTON, DC 20012 T; (201)060-2263 F; (201)080-2087

STRUCTURAL ENGINEER



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ELECTRICAL ENGINEER



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CML ENGINEER



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SUB	MISSION SCHEDULE	DATE
NO	DESCRIPTION	
REV	ISION SCHEDULE	DATE
NO	DESCRIPTION	

YOUTH SERVICES CENTER COURTYARD RENOVATION

1000 MOUNT OLIVET ROAD, NE WASHINGTON, DC 20002

SHEET TITLE:

EXISTING FLOOR PLAN & SCOPE OF WORK

PROJECT NO: 1310 OCTOBER 12, 2015 AS NOTED SHEET NO:

AE-01

DEMOLITION KEY NOTES:

ITEMS TO BE DEMOLISHED

1 WALLS NEW OPENING TO BE CREATED IN THE EXISTING WALL IN THE COURTYARD #1 SALVAGE BRICK FOR RE-USE. SE STRUCTURAL DRAWINGS FOR TEMP SUPPORTS,

© CONCRETE WALKWAY

CONCRETE WALKWAY TO BE DEMOLISHED

METAL FENCE & DOOR

METAL FENCE & DOOR TO BE DEMOLISHED


GENERAL DEMOLITION NOTES:

BEFORE STARTING DEMOLITION, WALK THE SPACE WITH THE ARCHITECT TO EXPLAIN THE PROCESS AND PROCEDURE OF DEMOLISHING THE ITEMS DESIGNATED TO BE DEMOLISHED AND REMOVED.

- PROTECT WALLS AROUND THE DEMOLITION AREAS WITH SUITABLE MATERIALS TO PREVENT FROM DAMAGE DURING DEMOLITION.
- IN CASE OF DAMAGE TO FINISHES AND SURFACES OF THE ITEMS TO REMAIN, CONTRACTOR SMALL REPAIR AND FIX DAMAGED ITEMS WITH NEW TO MATCH THE EXISTING AT NO ADDITIONAL COST TO THE OWNER AND ACCEPTABLE TO THE ARCHITECT.
- SEAL PROJECT WORK AREA FROM OTHER AREAS OF THE BUILDING TO PREVENT DUST TRAVELLING OUTSIDE OF THE WORK AREA.

NOTES:

- 1. SEE CIVIL ENGINEERING DRAWINGS FOR CIVIL WORKS DEMOLITION.
- 2. SEE ELECTRICAL DRAWINGS FOR ELECTRICAL DEMOLITION.
- COORDINATE WITH DGS PROJECT MANAGER FOR TIMING OF WORK AND ENTRY (EXIT REQUIREMENTS TO THE WORK AREA,

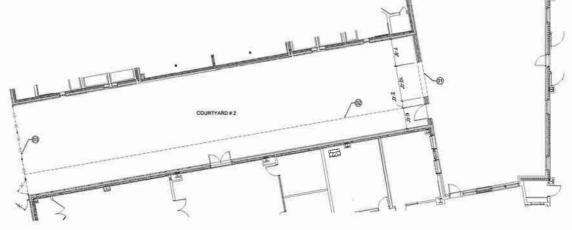



AD-01 AD-01

DGS DGS (DEPARTMENT OF GENERAL SERVICES) 1260 U STREET, MW. HARMOND DIS. DC 20008



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COURTYARD # 1

LANCE BAILEY & ASSOCIATES 7600 GEORGIA AVENUE, NW WASHINGTON, DC 20012 T: (301)665-2283 F: (301)565-2287



CONSULTING STRUCTURAL ENGINEER

ELECTRICAL ENGINEER



GLOBAL ENGINEERING SOLUTION 525 WISCONSIN AVENUE, NW. SLITE 300 WASHINGTON, DC 20015 T; (202) 495-7748 F; (202) 495-7747

CAN ENGINEER



+0 C-STREET +# SUFE # 430 WASHINGTON, DC 20002 T; (202) 259-4545 F; (202) 269-5051



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REV	VISION SCHEDULE	DATE
NO	DESCRIPTION	

YOUTH SERVICES CENTER COURTYARD RENOVATION

1000 MOUNT DLIVET ROAD, NE WASHINGTON, DC 20002

SHEET TITLE:

DEMOLITION PLAN

PROJECT NO: 1310 OCTOBER 12, 2015 AS NOTED SCALE: SHEET NO:

AD-01

MANUFACTURERS' SPECIFICATIONS:

THE FOLLOWING MANUFACTURERS, MODEL NUMBERS AND SPECIFICATIONS ARE PROVIDED FOR GUALITY CONTROL AND MORNAMASHIP ON THE PROJECT, METRIALS MEETING THE SAME OR BETTER IN QUALITY MAY BE USED ON THE FROJECT IF APPROVED BY THE ARCHITET, ALL SUBSTITUTIONS MUST RECEIVE ARCHITETS WRITTEN APPROVAL PRIOR TO

COURTYARD ROLL-UP GRILLE (C01):

- MOTORIZED ROLL UP GRILLE SHALL BE MODEL 678 MANUFACTURED BY "OVERHEAD DOOR INDUSTRY" OR, EQUAL
- 2. FINISH ON ALL MATERIALS SHALL BE ALUMINUM MILL FINISH POWDER COATED TO MATCH EXISTING WALL COLOR,
- 3. PATTERN SHALL BE STRAIGHT LATTICE.
- 4. BOTTAM BAR, GUIDE HOOD AND FACIA SHALL BE EXTRUDED ALUMINUM,
- 5. MOUNTING SHALL BE ON THE COURTYARD-2 FACE OF THE WALL.
- 6. OPERATION SHALL BE ELECTRIC BY WALL MOUNTED RMX OPERATOR
- SUBMIT MANUFACTURER'S PRODUCT DATA SHEETS, SHOP DRAWINGS AND RECOMMENDED INSTALLATION INSTRUCTIONS FOR ARCHITECT'S REVIEW AND APPROVAL PRIOR TO PROCURING MATERIALS.
- 8. ON COMPLETION, CLEAN UP ALL AREAS AND SURFACES OF DUST, DIRT AND RUBBISH,

CURTYARD VERTICAL LED LIGHT ENCLOSURE (C02);

- ENCLOSURE FRAMING TUBES SHALL BE HOT ROLLED GALVANIZED MILD STEEL SQUARE TUBES A500 IN SIZE
- LIGHT ENCLOSURE SHALL BE PERFORATED STAINLESS STEEL SHEET 1/8" THICK WITH 1/2" ROUND ON 11/16" STAGGERED HOLES SHAPED AS INDICATED ON THE DRAWINGS, ALL ENCLOSURE EDGES SHALL BE CAPPED BY A 2" WIDE "U" SHAPED 1/16" THICK STAINLESS STEEL TRIM WELDED ON BITHER SIDE OF THE ENCLOSURE.
- 11, ENCLOSURE CAP SHALL BE MADE OF STAINLESS STEEL 1/8" THICK METAL IN THE SHAPE INDICATED ON THE
- 12. FINISH ON ALL TUBES, PERFORATED ENCLOSURE, CAP, BASE PLATE, HARDWARE AND ATTACHMENTS SHALL BE POWDER COATED TO MATCH EXISTING WALL COLOR.
- 13. SUBMIT MANUFACTURER'S PRODUCT DATA SHEETS AND RECOMMENDED INSTALLATION INSTRUCTIONS FOR ARCHITECTS REVIEW AND APPROVAL PRIOR TO PROCURING MATERIALS.

OUTDOOR TV

14. OUTDOOR TV SHALL BE 80"NxG DS-700 OUTDOOR TV AS MANUFACTURED BY SKYVIEW COMPANY.

COURTYARD-2 FIXED SECURITY GRILLE IN EXTERIOR WALL:

THE SECURITY GRILLE SHALL BE ARCHITECTURAL SECURITY GRILLE DESIGN TYPE METRO AS MANUFACTURED BY AMETRO MANUFACTURING CORPORATION. THE BASK 3ZE SHALL BE 11/16" AND THE MESH SIZE SHALL BE 2:716'S X-316'F POWDER COATED TO EXISTING MASONRY WALL COLOR,

A01-01 A01-0

PLANTING AREA

COURTYARD-2 BLAST RESISTANT STEEL DOOR & FRAME IN EXTERIOR WALL:

- 16. FRAME SHALL BE 3 PSI BLAST RESISTANT (TESTED TO ASTM E330) PRESSED GALVANISED STEEL FRAME FOR EXTERIOR USE AND SIZES INDICATED ON THE DRAWINGS OR, TO MATCH THE EXISTING DOODR FRAME (D-0), FRAME SHALL BE EASTER PRINTED MET BLIFT DESIGNED COATING. FACTORY PAINTED WITH RUST RESISTING COATINGS.
- 17. FRAMES SHALL BE ANCHORD INTO MASONRY BY FOUR GALVANISED STEEL MASONRY ANCHORS ON EITHERSIDE
- 18... DOOR SHALL BE 3 PSI BLAST RESISTANT (TESTED TO ASTM E330) GALVANIZED STEEL CORE FOR EXTERIOR USE REINFORCED
 FOR BLAST RESISTANT AND DOOR HARDWARE, DOOR SHALL BE TORY PAINTED WITH RUST RESISTANT COATINGS.
- 19. DOOR LOCKING DEVICE SHALL MATCH THE EXISTING (D-0) DOOR LOCKING DEVICE AND HOOKED UP TO THE EXISTING SECURITY SYSTEM OF THE DETENTION CENTER.
- 20. HINGES SHALL BE 4 1/2" x 4 1/2" GALVANIZED STEEL EXTERIOR USE QUALITY SUPER HEAVY WEIGHT HINGES.
- 21, PROVIDE FLOOR PLATE AS NECESSARY BY THE DOOR
- 22. CAULK ALL JOINTS BETWEEN MASONRY AND THE FRAME WITH CAULKING COMPOUND MATCHING TO THE FRAME COLOR,
- 23. FIELD PAINT DOOR AND FRAME TO MATCH SECURITY GRILLE COLOR IN THE NEW WALL.
- 24 SUBMITTAL: PRODUCT DATA, SHOP DRAWINGS, TEST DATA
- 25. CONDUCT A PRE-INSTALLATION MEETING AND PROVIDE TESTING AND BALANCING OF THE OPERATION ON COMPLETION.

LEGEND

VERTICAL LIGHTING ENCLOSURE (TYPICAL) SEE DWG SHEET ACT-ACT

- VERTICAL LIGHTING ENCLOSURE (C02)
- FLOOR MOUNTED LED LIGHTING
- VERTICAL LIGHTING WITH
 DOWNSPOUT ENCLOSURE



PUBA

* * *

DGS

1250 U STREET, NW,

LANCE BAILEY & ASSOCIATES

STRUCTURAL ENGINEER



CONSULTING STRUCTURAL ENGINEER 629 EXECUTIVE BULEVARD HORTY BETHESON, MS 2002-2000 T; 301-416-0049 F; 301-416-0049

DGS (DEPARTMENT OF GENERAL SERVICES)

GES

GLOBAL ENGINEERING SOLUTION 5225 WISCONSIN AVENUE NW SUITE 700 WASHINGTON DC 20015 T; (202) 495-7745 F; (202) 495-7747

CHE ENGINEER AMT

WASHINGTON DG 20002 T; (202) 289-4545 F; (202) 289-5



SUBMISSION SCHEDULE	DATE
NO DESCRIPTION	
REVISION SCHEDULE	DATE
NO DESCRIPTION	
PROJECT:	

YOUTH SERVICES CENTER COURTYARD RENOVATION

1000 MOUNT OLIVET ROAD, NE WASHINGTON, DC 20002

SHEET TITLE:

COURTYARD PLAN

PROJECT NO: 1310 OCTOBER 12, 2015 AS NOTED SCALE: SHEET NO:


A01-01



VERTICAL LIGHTING WITH

FLOOR MOUNTED LED LIGHT FIXTURE (TYP) SEE DETAIL 6/401-03

EXISTING

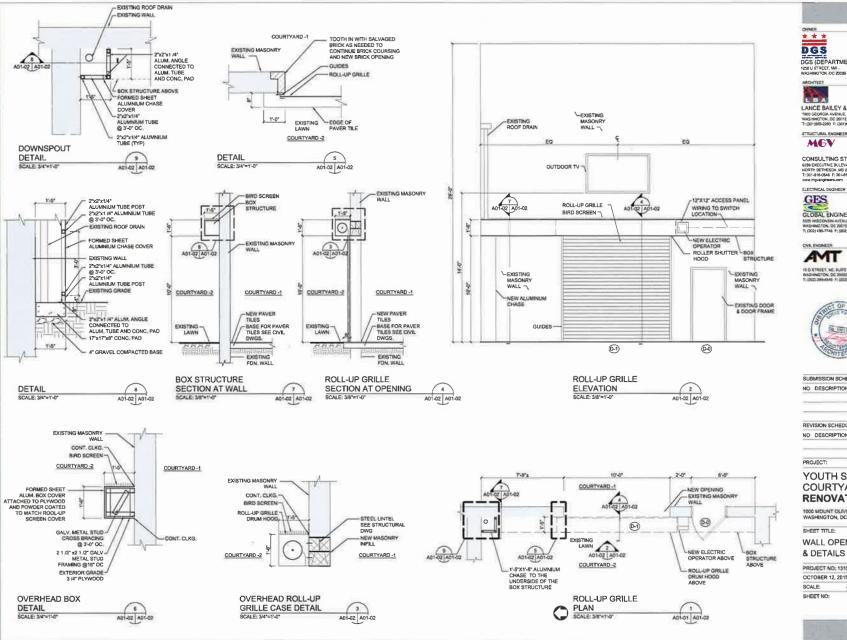

* * *

DGS

DGS (DEPARTMENT OF GENERAL SERVICES) 1250 U STREET, NW WASHINGTON DC 2000S

LANCE BAILEY & ASSOCIATES



CONSULTING STRUCTURAL ENGINEER 6296 EXECUTIVE BULEVARD NORTH BETHESDA MD 20182-0308 T: 301-316-0566 F: 301-316-0649

ELECTRICAL ENGINEER



GLOBAL ENGINEERING SOLUTION NAVENUE, NW. SUITE 300

CAN ENGAGER

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10 G STREET, NE, BUTTE # 438 WAZHANGTON, DC 20002 TI, (200) 289-4549 F; (200) 289-5097



SUBMISSION SCHEDULE	DATE
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PROJECT:	

YOUTH SERVICES CENTER COURTYARD RENOVATION


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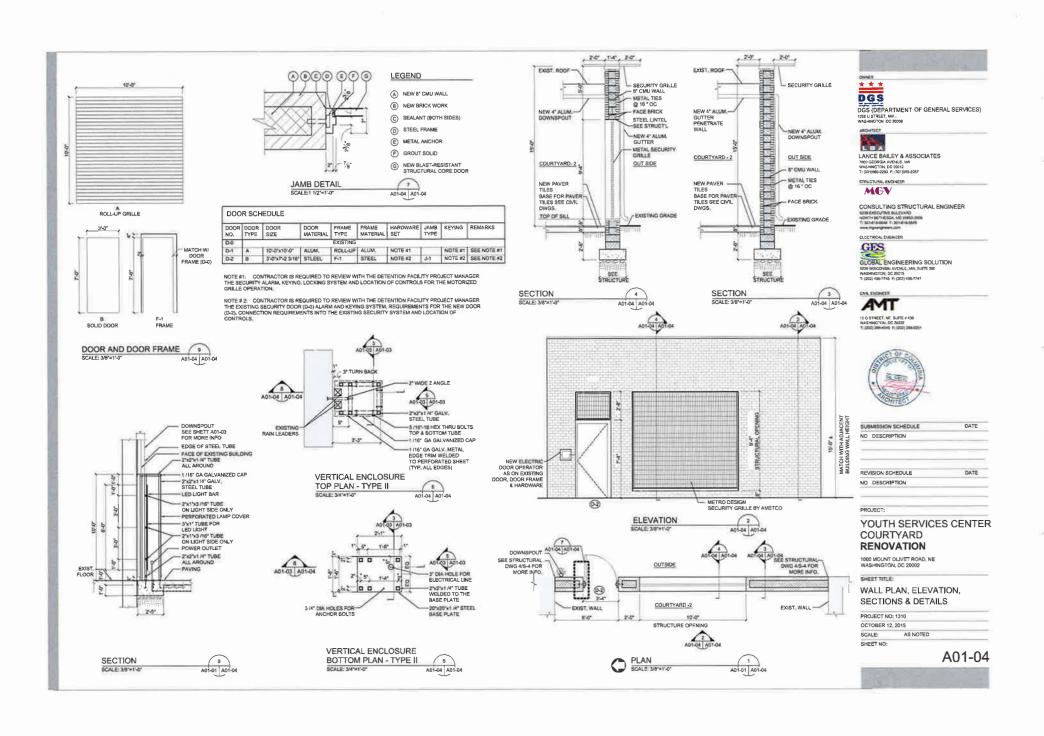
SHEET TITLE:

WALL OPENING & DETAILS

PROJECT NO: 1310 OCTOBER 12, 2015 SCALE:

A01-02



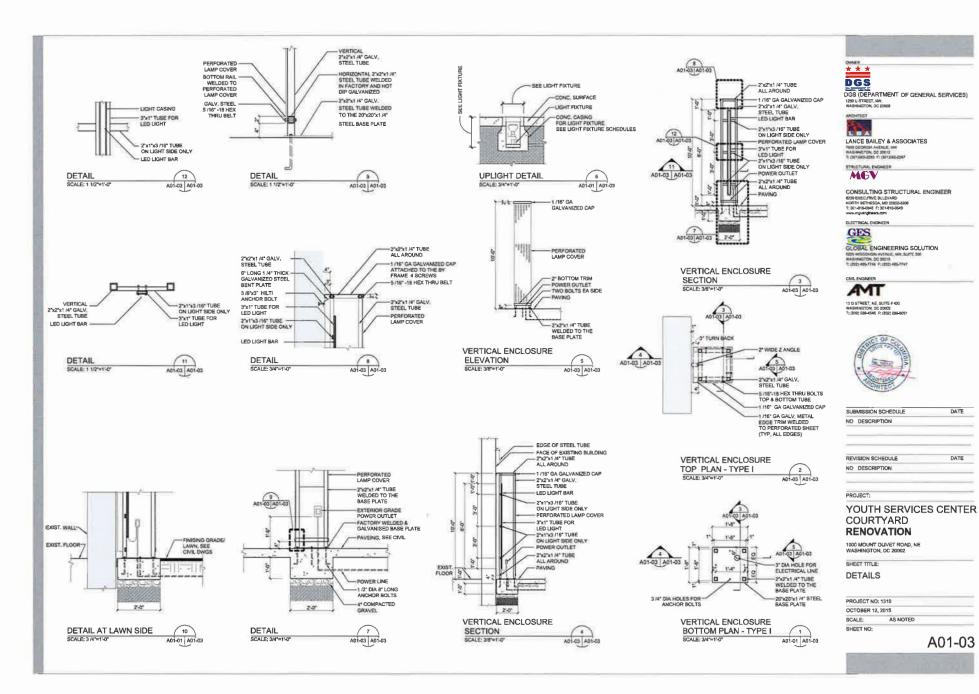



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- F INE ORBITE CONCRETE PAYORS SHALL BE HER THE DETAILS SHOWN ON OVER C-4.7 AND C-4.2

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- VAD ABOADE ENCOLH LEVYSIUM RHEEK LAND ENGADZED WORK ID ENGLING ESVDE.
- PUMPING ARRANGERENTS, AND/OR CONNECTIONS AS REQURING TO MANTAIN DRAINAGE. CONSTRUCTION, PROVIDE TEAPORARY FACURITES,
 - CHADING & DRAINAGE NOTES
 - 6. CONTACT HE COOT REPORTED TO STITUTURE IF HUBLIC SPACE FLANDESS (STREET LORIZE STOR SALVACED ITBUS, STONE CUR. STONE CUR. SHOWN TO BE DEMOURSHED ARE REQUIRED TO STALVACED ITBUS.
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- ALL RESTREATION W PUBLIC SPACE SHALL BE IN ACCOMPANCE WITH DOD'S STANDARD SPECIFICATIONS FOR HIGHWAYS AND STRUCTURES.
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- 12. MANTAN TRE DEPARTMENT, EMERGENEY, SERVICE, DELIVERY, AND PEDESTRAN (NICLUDING ADA). ACCESS TO THE SURROUN (FOY) LOW STATEMENT HEM SHEPASHW THE HEM TOWNSHOOD IN THE THING HOLDSHEEPING THE
- REBEZZATURE Y1 JAC COMAPZION OL CONCIDENCIÓN DILAYAL ISODI JAS VASSANE CORCILIONOLDON YVIEZ MAR ZEL OL BECONO, PZ-BRE1, DAYMAIGS ZHITE BE ISONOED 10 JAC OMPCAJZ WYNILYDN Y ROBINGÓ RADA C CONCILIONOLD NEW RENNEMBER DE SED MEN HIT CONCILIOCICED EXPLINEET YCCOMBYLETA MEYGRABED'. MAKE LIETO YOTHZINENIZ YZ NEGZZENIA 10 MEZI ÉKIZINE CONDUIONZ MHEN YNIZHOZED BA JAC QWELK,Z KENSTZUNIAE
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- WORK REQUIRED TO GRAMM PERMITS, PLEME ANY AND MLL GC ACREST PERMITS NOT PROVIDED WITH THE CONSTRUCTION ODCLARATS, INCLUDING ZIVADYGOZ VYO CORNETA MULH VITI KEONIEDI BINITONO MZNECUJONZ MODIEŁ JAE ENONEES IŁ DIZCHENYOTZ EDZI, MUJH JAE LAYMZ CONDAYCIJOS SHITT ENONEE Y DCHTCHWZED ZINGALJON JO LIETO AESIĘŁ BEOYECI BEORDSŁA BOYNONIA, ŁOB CONCINITULION NEB DC VEDNCA
- ANT, ILC AND THE ENCHERS OF RECORD ARE NOT RESPONSIBLE FOR JOB STE SAFETY. SEPERATION, OR ANY DAMAGE OR INJURY SUSTAINED DURING CONSTRUCTION BY ANY PERSON, MAINEY SUSTAINED ON OR ADMACENT TO THE STE
- COMBY, MENT MICE AUTHAL REGULESMENTS FOR HALLA FOCKLIGHT.

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DEPENDENT SILE CONSTRUCTION NOTES

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PROPERTY INFORMATION NOTIFICE AGENCIES

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SHOULING & DEFINITIONS

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SCYCE: 1_=Z000. VICINITY MAP



WASHINGTON, DISTRICT OF COLUMBIA LOT 0034 SQUARE 4049 1000 MOUNT OLIVET ROAD, NE

LOCATION OF SITE DYRS COURTYARD & GYMNASIUM RENOVATION GENERAL UTILITY NOTES.

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- STE RUNOIT FROM DISTURBED MEETAS SHALL BE FILTURED THROUGH A SECIMENT CONTRO, MEASURE (FIRE THE APPROVED ESC PLAN) PRINCE TO
- INSTALL PROTECTION ON ALL EXISTING AN ALL EXISTING AND PROPOSED INLETS ON AND ADJACENT TO THE LIMITS OF DISTURBANCE.
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- BOORSED FOR INTUINIVE INSTALLATION OF PROPOSED MINOVENEUTS. DEPOSTED ON THE DEMOLITION PLAN. TOCKIDIN YND SCHTE JAG COMJENCIAS IS SEGONOSTE LOG JEG DEMOTIJON BENOME THO BENEVEZNENI OL YTT ENZING LEVIJAKE YE ILLEN ID BE YBYNDONED OK DEMOTIZON OLEZ SHONN SOLDON YNDBEGENNY YNDBONED OK DEMOTIZON OLEZ SHONN SOLDON YNDBEGENNY YNDBONED OK DEMOTIZON OLEZ SHONN YNDBEGENNY YNDBONED OK DEMOTIZON OLEZ SHONN YNDBEGENNY YNDBONED OK DEMOTIZON OLEZ SHONN YNDBONED OL

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CONSTRUCTION DOCUMENTS SET 9/21/15 SUBMISSION SCHEDULE

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ENCHMEERS CERTIFICATE

SHEET NO:

A/N :3JA34 9102/12/6 PROJECT NO: 113-506

SHEET TITLE: SYCHING LON' DC 50005 DOO MOONT OLIVET ROAD, NE

REVISION SCHEDULE

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RENOVATIONS

CENTER COURTYARD DYRS-YOUTH SERVICES


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DOS (GEPARTMENT OF GENERAL SERVICES)

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REVISION SCHEDULE DATE

CONSTRUCTION DOCUMENTS SET 9/2/1/15

REVISION SCHEDULE DATE

PROJECT:

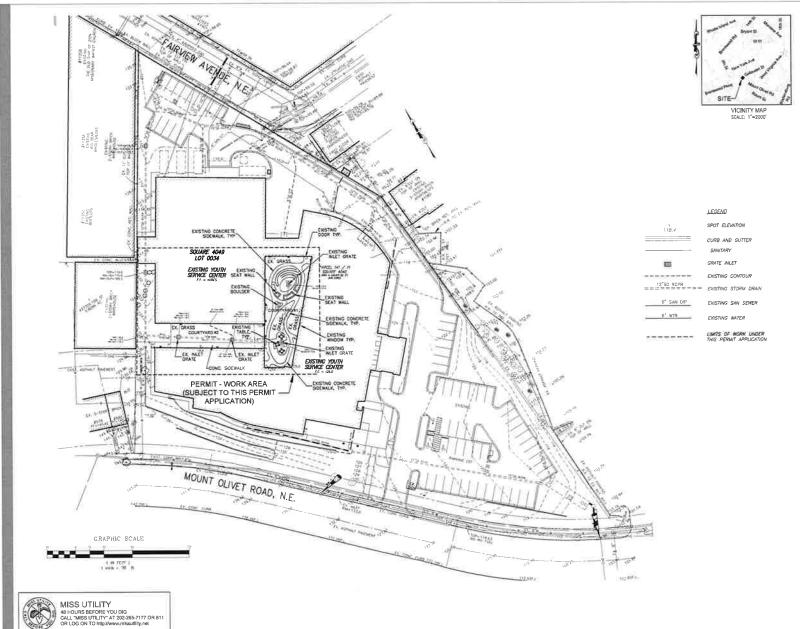DYRS-YOUTH SERVICES

CENTER COURTYARD RENOVATIONS

1000 MOUNT OLIVET ROAD, NE WASHINGTON, DC 20002


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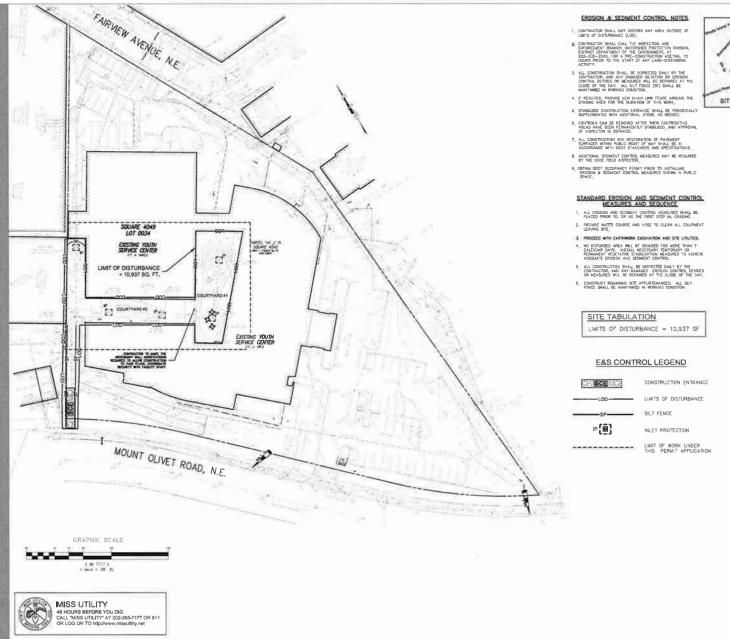
SHEET NO:

EXISTING CONDITIONS PLAN

PROJECT NO: 113-506 9/21/2015 SCALE: 1 IN. = 30 FT.

C-1.0



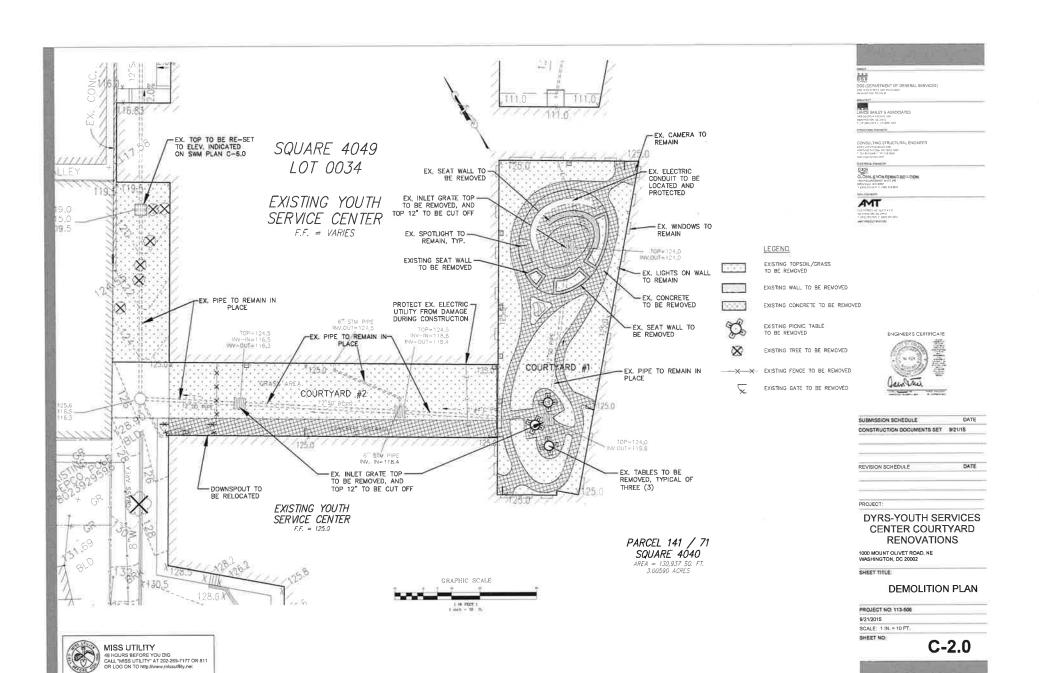



VICINITY MAP SCALE: 1"=2000"

DOS (DEPARTMENT OF GENERAL SERVICES)

RESIDNE JARUTSURTE ONT JURISCO

Author Donle

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SUBMISSION SCHEDULE DATE CONSTRUCTION DOCUMENTS SET 9/21/15 DATE PROJECT:

DYRS-YOUTH SERVICES CENTER COURTYARD RENOVATIONS

1000 MOUNT OLIVET ROAD, NE WASHINGTON, DC 20002

SHEET TITLE:

EROSION AND SEDIMENT CONTROL PLAN

PROJECT NO: 113-506 9/21/2015 SCALE: 1 IN = 30 FT.

SHEET NO:

C-3.0

DOEE SOIL EROSION AND SEDMENT CONTROL PLAN GENERAL NOTES:

- FOLLOWING INTIAL LAND DISTURBANCE OR RE-DISTURBANCE, PERMANET OR INTERIM STABILIZATION MUST BE COMPLETED WITHIN SEVEN (7) CALENDAR DAYS FOR THE SURFACES OF ALL PRIMITER CONTROLS, DWGS, SWALES, DOTOSES, SEMENTER SEPECTS, AND SCRIPTS OF CALENT THAN THEE CONTROLS OF ALL PRIMITERS OF THE SURFACES OF ALL PRIMITERS OF THE SURFACES OF THE SURFACE OF THE SURFACES OF THE S
- 2. ESC MEASURES SHALL BE IN PLACE BEFORE AND DURING LAND DISTURBANCE, [21 DCMR § 543,6]
- 3. CONTACT DOER INSPECTION (202) 535-2977 TO SCHEDULE A PRECONSTRUCTION MEETING AT LEAST THREE (3) BUSINESS DAYS BEFORE THE COMMENCEMENT OF A LAND-DISTURBING ACTIVITY. [21 DOMR § 503.7 4].
- A COPY OF THE APPROVED PLAN SET WILL BE MAINTAINED AT THE CONSTRUCTION SITE FROM THE DATE THAT CONSTRUCTION ACTIVITIES BEGIN TO THE DATE OF FINAL STABILIZATION AND WILL BE AVAILABLE FOR DOCE INSPECTORS. [2] DOMR 8 542.15]
- 5. ESC MEASURES SHALL BE IN PLACE TO STABILIZE AN EXPOSED AREA AS SOON AS PRACTICABLE AFTER CONSTRUCTION ACTIVITY HAS TEMPORARILY OR PERMANENTLY CEASED BUT NO LATER THAN FOURTEEN (14) DAYS FOLOWING CESSATION, EXCEPT THAT TEMPORAY OR PERMANENTLY STABILIZATION SHALL BE IN PLACE AT THE END OF EACH DAY OF UNDERGROUND UTILITY WORK THAT IS NOT CONTAINED WITHIN A LARGER DEVICE/MENT STIEL (22) DOUR 8 540.00
- STOCKPILED MATERIAL BEING ACTIVELY USED DURING A PHASE OF CONSTRUCTION SHALL BE PROTECTED AGAINST EROSION BY ESTABLISHING AND MAINTAINING PERIMETER CONTROLS AROUND THE STOCKPILE [27 DOMR § 543,16 (A)].
- STOCKPILED MATERIAL NOT BEING ACTIVELY USED OR ADDED TO SHALL BE STABILIZED WITH MULCH, TEMPORARY MEGETATION, HYDRO-SEED OR PLASTIC WITHIN FIFTEEN (15) CALENDAR DAYS AFTER ITS LAST USE OR ADDITION, [2] COMER § 543.16 (B)]
- PROTECT BEST MANAGEMENT PRACTICES FROM SEDIMENTATION AND OTHER DAMAGE DURING CONSTRUCTION FOR PROPER POST CONSTRUCTION OPERATION. [21 DCMR § 543.5]
- REQUEST A DOSE INSPECTOR'S APPROVAL AFTER THE INSTALLATION OF PERIMETER EROSION AND SEDIMEN' CONTROLS, BUT BEFORE PROCEDING WITH ANY OTHER EARTH DISTURBANCE OR GRADING, [2] DOWN § 5.42.12 (A)]
- 10. REQUEST A DOEE INSPECTOR'S APPROVAL AFTER FINAL STABILIZATION OF THE SITE AND BEFORE THE REMOVAL OF EROSION AND SEDIMENT CONTROLS. [21 DCMR § 542.12 (9)]
- FINAL STABILIZATION MEANS THAT ALL LAND-DISTURBING ACTIVITIES AT THE SITE HAVE BEEN COMPLETED AND ETHER OF THE FOLLOWING TWO CRETERS HAVE BEEN METH, (1) A UNIFORM (FOR EXAMPLE, EMENT) STRIBBUTED, WITHOUT LINES BEARS AREAS PERSONAL VECTATIVE, COVER THAT A DESIGN OF SEVENTY FERCENT (702) OF THE MATTHE BECKGROUND, VECTATIVE, COVER FOR THE AREA HAS BEEN ESTRIBLESTED ON ALL UMPRICE MARKES AREAS MATE CONTROL OF STRUCTURES, OR (2) COUNTAINT FRANKENT SHAWED AREAS AND AREAS MATE SHAWED BEEN ESTRUCTURES, THE USE OF REPRIAR, OASIONS, OR COUTTAINED, 12) DOINT 80 PATE (2) (2) (3), 12, 17).
- FOLLOW THE REQUIREMENTS OF THE UNITED STATES ENVIRONMENTAL PROTECTION AGENCY APPROVED STORMMATER POLLUTION PREVENTION PLAN (SWPPP) AND MAINTAIN A LEGIBLE COPY OF THIS SWPPP ON SITE. (21 DOM'S \$4.5.10 (B))
- 13, POST A SIGN THAT NOTIFIES THE PUBLIC TO CONTACT DIDGE IN THE EVENT OF EROSION OR OTHER POLLUTION, THE SIGN WILL BE PLACED AT EACH ENTRANCE TO THE SITE OR AS DIRECTED BY THE DOSE INSPECTOR, EACH SIGN WILL BE NO LESS THAN 18 X 24 INCHES IN SIZE AND MADE OF MATERIALS THAT WILL WITHSTAND WEATHER FOR THE DURATION OF THE PROJECT, LETTERNIG WILL BE AT LEAST I INCH IN MEDIOT AND EASY RELOADS OF THE PUBLIC FORM A DISTANCE OF THILLY EXTENDED IN THE SIGN MUST ORICIT THE PUBLIC IN SUBSTANTIALLY THE FOLLOWING FORM TO REPORT ENGINE, DOCTS TELEPHONE MADER OF STEMPHONE POLITION, AND THE SITE OF STEMPHONE SITE ASSOCIATION SITE ADDIRECT ON STEMPHONE MADER (302-35S-2977), DOCTS TELEPHONE SITE ASSOCIATION SITE ADDIRECT MADER (302-35S-2977), DOCTS TELEPHONE SITE ASSOCIATION SITE ADDIRECT.
- A RESPONSIBLE PERSON MUST BE PRESENT OR AVAILABLE WHILE THE SITE IS IN A LAND-DISTURBING PHASE. THE RESPONSIBLE PERSON IS CHARGED WITH BERING AVAILABLE TO (A) INSPECT THE SITE AND ITS ESC MEASURES AT LEAST ONCE DIMENSION AND AFTER A RAINFALL EVENT TO DENTIFY AND REMODY EACH POTENTIAL OR ACTUAL EXOSON PROBLEM, (B) RESPOND TO EACH POTENTIAL OR TO DESCRIPT AND A COURSE OF THE POTENTIAL OR ACTUAL EXOSON PROBLEM. A RESPONSIBLE OR SITE OF THE POTENTIAL OR ACTUAL EXOSON PROBLEM. A RESPONSIBLE PERSON SHALL BE (A) UCENSED IN THE DISTRET OF COLUMBIA AS A CYM. OR GEOTEO-NEAL DISONED, A LAND SINE-YOU, OR RACHITCH OR (G) CERTIFICT THOUGH AT TRANSPORT PROBLEM. A RESPONSIBLE PERSON SHALL BE (A) UCENSED IN THE OSTER OF COLUMBIA AS A CYM. OR GEOTEO-NEAL DISONED ON A COURSE ON EROSON POOR PROBLEM. A RESPONSIBLE PERSON SHALL SERVED ON SITE PROOF OF PROPESSIONAL LICENSION OF ON THE PROPERTY OF A COURSE ON EROSON FOR THE PERSON SHALL RESPONSIBLE PERSON

VEGETATIVE STABILIZATION PERMANENT AND TEMPORARY SECOND STORMS AND MUSCHING

I. SITE PREPARATION

PERMANENT OR TEMPORARY STABUIZATION SHALL BE COMPLETED WITHIN (A) SEVEN CALENDAR DAYS AS TO THE SUMFACE OF ALL SEDIMENT CONTROL PRACTICES SUCH AS DIVERSIONS, GRADE STABUIZATION STRUCTURES, BERNE, DIKES, GRASES WATERWAYS, SEDIMENT BASINS, PERMETER SLOPES, AND ALL SLOPES GREATER THAN 3 HORZONTAL TO 1 VERTICAL (2:1) AND (3) FOURTEEN DAYS AS TO ALL DITHER DISTINGED OR GRADED AREAS ON THE PROCEST STA

B. SEEDING PREPARATION AND SEEDING APPLICATION

THE TOP LATER OF SALE SHALL BE LOSSEDD LIVED AND FEBRUARD OF RANGE, DESIGN OR RANGE AND STREET AND RESIDENCE SECTION. CLAY AREAS MIS SORVEY BY D. 3 TO 1 GRADE SHALL BE LOOSE AND FRANCE TO A DOPH OF AT LEAST 3 INCHES SLOPES STEEPER THAN 3 TO 1 SHALL HARK THE TOP 1-3 MEANES OF SOIL LOOSE AND FRANCE TO A DOPH OF AT TLAYS 3 MICH. SLOPES UP TO 3 TO 1 GRADE SHALL BE LOOSE AND FRANCE TO A DOPH OF AT LEAST 3 MICH. SLOPES AND THE ADDRESS OF A DOPH OF AT LEAST 3 MICH. STANDARD AND ADDRESS OF A DOPH OF AT LEAST 3 MICH. STANDARD AND ADDRESS OF A DOPH OF AT MICH. STANDARD SCHOOL AND THE ADDRESS OF SALL LOOSE AND TRAINED EFFORM.

APPLY SEED UNIFORMLY WITH A CYCLONE SEEDER, DRILL CULTIPACKER, SEEDER OR HYDROSEEDER ON A FIRM MOIST SEEDBED.

DATES:

LIME AND FERTILIZE ACCORDING TO SOIL TESTS; IN LIEU OF SOIL TEST APPLY THE FOLLOWING:

1 TON PER ACRE OR 46 LB/1,000 (TEMPORARY) 10-10-10 OR EQUIVALENT AT 1,000 LBS PER ACRE OR 23 LBS PER 1,000 SQ. FT. (PERMANENT AND SODDING)

N SERVICES CONTROL PRACTICES, SEFFONG

"KENTUCKY 31" TALL FESCUE 6D LBS/ACRE OR 1,38 LBS/1,000 SQ FT AND SEED: ITALIAN (ANNUAL) RYEGRASS 40 LBS/ACRE OR 91 LBS/1,000 SQ FT

1/2 - 10/31 5/1 - 8/14 WITH IRRIGATION.

TEMPORARY SECOND: PER DROWNG SEASON

ITALIAN OR PERENNIAL RYECRASS 40 LBS/ACRE OR 92 LBS/1,000 SQ FT

2/1 ~ 4/30 AND B/15 - 11/30 DATES:

MILLET 4D LBS/ACRE OR 0.92 LBS/1,000 SQ. FT.

VI. PERMANENT, SEEDING.

A. RESIDENTIAL AND HIGH MAINTENANCE AREAS

KENTUCKY BLUEGRASS, "PLUSH", "BIRKA", "PARADE", "VANTAGE", "COLUMBIA", "MERION", "ADQUAM", "SCHOLUE", ANY THREE VARETIES AT 30 LBS, TO MAKE 9 LBS/ACRC OR 2 LBS/ACRC SQTT., AND RED FESCUE - "PENNLAWN" OR JAMESTOWN 10 LBS/1000 SQTT.,

DATES: 2/1 - 4/30 AND 8/15 - 10/31

"KENTUCKY 31" TALL FESCUE 220-260 LBS/ACRE OR 5-6 LBS/1,000 SQ. FT.

"KENTUCKY 31" TALL FESCUE 40 LBS/ACRE OR 0.92 LBS/A.000 E0 FT, AND "NITERSTATE" SERICEA LESPEDEZA (NOCULATED)20 LBS/ACRE OR 0.46 LBS/A.000 S0. FT.

DATES: 2/1 - 4/30 AND 8/15 - 10/31

C. GENERAL AND LARGE ACREAGE

"KENTUCKY 31" TALL FESCUE 60 LBS /ACRE OR 1.38 LBS/1.000 SQ FT.

ALL SEEDINGS REQUIRE MULCHING. USE MULCH ONLY DURING NON-SEEDING DATES UNTIL SEEDING CAN BE DONE.

MULCH SHALL BE UNROTTED, UNCHOPPED SMALL GRAIN STRAW APPLIED AT A RATE OF 1 TO 2 MULCH SHALL BE UND-90 LBS/LOOS SAFT, 20 BALS MALE CRAM STRAW APPLED AT A RATE OF 11 DE TONS/ACRE DO TONS/ACRE DO SAFT, 22 BALS SAM MULCH MATERIALS SHALL BE RECLITIVELY FREE OF ALL KINDS OF WEED BEDS AND SHALL BE FREE OF FROMBIED NOXIOUS WEEDS. SPREAD MULCH WAS SHALL BE FREE OF FROMBIED NOXIOUS WEEDS. SPREAD MULCH WAS SHALL BE ACCOMPLISHED BY MEDIATELY WAS SHALL BE FREE OF THE SAFT BE COOKED SHALL WAS A WA

HOURD WHICH RINDER SHALL BE RAPID CURING CUTBACK ASPHALT APPLIED AT A RATE OF 200 GAL/ACRE OR 5 GAL PER 1,000 SQ FT. SLOPES 8 FEET OR MORE HIGH USE 348 GAL/ACRE OR 8 GAL /1,000 SO FT

VII. SODDING

CLASS OF TURFGRASS SOD SHALL BE MARYLAND OR VIRGINIA STATE CERTIFIED OR MARYLAND OR VIRGINIA STATE APPROVED SOD. SOD SHALL BE HARVESTED, DELIVERED AND INSTALLED WITHIN A PERSOD OF SE HOURS. SOD IS TO BE LAD WITH THE LONG EDGES PRAGLLEL TO THE CONTOUR WITH STRACEGRED JOINTS WITH ALL RODS INGTHEY ABUTHEN AND NOT OVERLAPPING. SOD SHALL BE ROLLED AND THOROUGHLY WATERED WITHIN EIGHT HOURS OF INSTALLATION. DALLY WATERNOT TO MAINTAIN A HOME DEPTH OF MOSTURE FOR THE FIRST WEEK IS REQUIRED IN THE ABSENCE OF RAINFALL. SOD IS NOT TO BE APPLIED

IX. MAINTENANCE

A IRRIGATION - WHEN SOIL MOISTURE BECOMES DEFICIENT, IRRIGATE TO PREVENT LOSS OF STAND OF PROTECTIVE VEGETATION.

B. REPAIRS — IF STAND IS INADEQUATE FOR EROSION CONTROL, OVERSEED AND FINITULZE USING HALF OF THE RATES ORIGINALLY APPLIED. IF STAND IS OVER 50% DAMAGED, REESTABLISH FOLLOWING ORIGINAL RATES AND PROCEDURES

USE OF THIS INFORMATION DOES NOT PRECLUDE MEETING ALL OF THE REQUIREMENTS OF THE 1987 DISTRICT OF COLUMBIA DEPARTMENT OF CONSUMER AND REGULATORY AFFAIRS STANDARDS AND SPECIFICATIONS FOR SOIL EROSION AND SEDIMENT CONTROL VEGETATIVE PRACTICES.

STANDARD EROSION AND SEDIMENT CONTROL NOTES:

- SEDIMENT AND EROSION CONTROL MEASURES SHALL BE INSTALLED SEDIMENT AND EROSINO CONTROL MEASURES STALL BE INSTALLED BEFORE THE START OF ANY EXCAVATION AND/OR CONSTRUCTION AS PER STANDARDS AND SPECIFICATIONS FOR SOIL EROSION AND SEDIMENT CONTROL FOR THE DISTRICT OF COLUMBIA. IF AN ON-SITE INSPECTION REVEALS FURTHER EROSION CONTROL MEASURES ARE NECESSARY, THE SAME SHALL BE PROVIDED,
- ALL DEBRIS IS TO BE REMOVED FROM SITE AND DISPOSED OF AT A LEGAL OFF-SITE LOCATION
- ALLEYS, STREETS, AND SIDEWALKS SHALL BE SWEPT CLEAN AT ALL TIMES DURING DEMOLITION, EXCAVATION AND CONSTRUCTION
- ALL CATCH BASINS AND DRAIN AREAS SHALL BE PROTECTED DURING FYCAVATION AND CONSTRUCTION.
- IF ANY CATCH BASINS OR DRAINS BECOME CLOGGED AS A RESULT OF DEMOLITION, EXCAVATION OR CONSTRUCTION THE CONTRACTOR SHALL BE RESPONSIBLE FOR ITS CLEANING
- WHEN SEDIMENT TRAP/SEDIMENT TANK HAS REACHED 67% CAPACITY. CLEANING OUT OF SAME IS REQUIRED
- ANY STOCKPILING, REGARDLESS OF LOCATION SHALL BE STABILIZED AND COVERED WITH PLASTIC OR CANVAS, AFTER ITS ESTABLISHMENT AND FOR DURATION OF THE PROJECT.
- AFTER RAZING OR DEMOLITION, THERE IS THE NEED FOR CROUNDCOVER TO PREVENT EROSION AND SEDIMENT RUNOFF FROM OCCURRING SUCH AS APPLYING SEED, SOO, PAVE, BRICKBAT, MIJI CH. FTC.
- THE SITE'S APPROVAL LETTER, APPROVED EROSION AND SEDIMENT CONTROL PLANS, DAILY LOG BOOKS AND TEST REPORTS SHALL BE AVAILABLE AT THE SITE FOR INSPECTION BY AUTHORIZED OFFICIALS OF DORA RESPONSIBLE FOR PROJECT,
- TEMPORARY SEDIMENT CONTROL DEVICES MAY BE REMOVED. WITH TEMPORARY SEDMENT CONTROL DEVICES MAY BE REMOVED, MITH PERMISSION OF DCRA INSPECTOR, WITHIN THIRTY CALENDAR DAYS FOLLOWING ESTABLISHMENT OF PERMANENT STABILIZATION IN ALL CONTRIBUTORY DRAINAGE AREAS, STORMWATER MANAGEMENT STRUCTURES USED TEMPORARILY FOR SEDIMENT CONTROL SHALL BE CONVERTED TO THE PERMANENT CONFIGURATION WITHIN THIS TIME PERIOD AS WELL
- VECETATIVE STABILIZATION SHALL BE PERFORMED IN ACCORDANCE WITH THE DORA STANDARDS AND SPECIFICATIONS FOR SOIL EROSION AND SEDIMENT CONTROL. REFER TO APPROPRIATE SPECIFICATIONS FOR TEMPORARY SEEDING, PERMANENT SEEDING, MULCHING, SODDING AND GROUND COVERS.
- SEDIMENT REMOVED FROM TRAPS (AND BASINS) SHALL BE PLACED AND STABILIZED IN APPROVED AREAS, BUT NOT WITHIN A REPOSED FOR THE PROPERTY WILLIAMS OR TREE-SAVE AREA WHEN PUMPING SEDIMENT LADEN WATER, THE DISAPAGE MUST BE DIRECTED TO A SEDIMENT TRAPPING DEVICE PRIOR TO RELEASE FROM THE SITE. A SUMPT IMAR BE USED IF SEDIMENT TRAPS THEMSELVES ARE BEING PUMPED DUT.
- WHERE DEEMED APPROPRIATE BY THE ENGINEER OR INSPECTOR. SEDIMENT BASINS AND TRAFS NAMY VEED TO BE SURROUNDED WITH AN APPROVED SAFETY FENCE. THE FENCE MUST COMPORN TO LOCAL ORDINANCES AND REGULATIONS. THE DEVELOPER OR OWNER SHALL CHECK WITH LOCAL GUILDING OFFICIALS ON APPLICABLE SAFETY REGULATIONS. THE DEVELOPER OR OWNER SHETY REQUIREMENTS. WHERE SAFETY FENCE IS DEEMED APPROPRIATE AND LOCAL ORDINANCES DO NOT SPECIFY FENCING SIZES AND TYPES, THE FOLLOWING SHALL BE USED AS A MINIMUM STANDARD. THE SAFETY FENCE MUST BE MADE OF WELDED MISS TANDARD. THE SAFETY FENCE MUST BE MADE OF WELDED WIS HAVE APART THAN 1 FETT, THAN MEST OPENINGS NO GREATER THAN 2 NICHES IN WIDTH AND 4 INCHES IN HEIGHT WITH A MINIMUM OF 14 CAUGE WIRE. SAFETY FENCE MUST BE MAINTAINED AND IN GOOD CONDITION AT ALL TIMES. WHERE DEEMED APPROPRIATE BY THE ENGINEER OR INSPECTOR
- SEDIMENT CONTROL FOR UTILITY CONSTRUCTION FOR AREAS OUTSIDE OF DESIGNED CONTROLS OR AS DIRECTED BY ENGINEER OR DCRA INSPECTOR:

 - CALL "MISS UTILITY" AT 202-255-7177, OR 811, 48 HOURS PRIOR TO THE START OF WORK, EXCAVATED TRENCH MATERIAL SHALL BE PLACED ON THE HIGH SIDE OF THE TRENCH, (B)
 - HIGH SIDE OF THE TRENCH, TRENCH, TRENCHES FOR UTILITY INSTALLATION SHALL BE BACKFILLED, COMPACTED AND STABILIZED AT THE END OF EACH WORKING DAY, NO MORE TRENCHES SHALL BE OFENED THAN CAN BE COMPLETED THE SAME DAY, UNLESS;
 TEMPORARY SILT FENCE SHALL BE PLACED IMMEDIATELY DOWNSTREAM OF ANY DISTURBED AREA INTENDED TO REMAIN DISTURBED FOR MORE THAN ONE DAY.

OFF-SITE SPOIL, WASTE, OR BORROW AREAS IN THE DISTRICT OF COLUMBIA OR ON FEDERAL PROPERTY MUST HAVE PROOR APPROVAL BY DORA: ALL WASTE AN BORROW AREAS OFF-SITE MUST BE PROTECTED BY SEDMENT CONTROL MEASURES AND STABILIZED IN ACCORDANCE WITH THE ORDINANCES AND REGULATIONS OF THE JURISDICTION WHERE THE SPOIL, WASTE, OR BORROW AREA IS LOCATED/STABILIZED

SITE INFORMATION: DATA 130,937 S.F. 10,937 S.F. TOTAL AREA OF SITE AREA DISTURBED BUILDING AREA TOTAL CUT TOTAL FILL 47.336 S.F. 500 CU YDS* 420 CU YDS*

* OFFSITE WASTE/BORROW TO BE SUBMITTED BY AREA LOCATION CONTRACTOR FOR APPROVAL THESE NUMBERS ARE FOR PERMIT PURPOSES ONLY AND NOT FOR BODING.

DGS (DEPARTMENT OF GENERAL SERVICES), NEW HINST FOR I MY STAFFLOOD Wed SHIRT ON US 18800

LANCE BALLY & ASSOCIATES

DONOULTING STRUCTURAL ENGINEER

L 301 BJ#UMB I JOJ 018 0840 NORIUM DELLICOM MD 30971 JOSE 8396 CASCRILLOS BRICANNO 8396 CASCRILLOS BRICANNO

CITTOIR PROPERTY

GE. GLOBAL ENGINEERING SOLUTION

FISH FICEARD DRIVE SUITE SIN POS-VILLE NO 20150 1 CB19374 JB21 F (2012/16/08/1

AMT



SUBMISSION SCHEDULE DATE CONSTRUCTION DOCUMENTS SET 9/21/15 REVISION SCHEDULE DATE PROJECT

DYRS-YOUTH SERVICES CENTER COURTYARD RENOVATIONS

1000 MOUNT OLIVET ROAD, NE WASHINGTON, DC 20002

SHEET TITLE:

EROSION & SEDIMENT CONTROL NOTES

PROJECT NO: 113-506 9/21/2015 SCALE: N/A SHEET NO:

C-3.1




CONSTRUCTION SPECIFICATION

- 1. LENGTH MIN, OF 50' RAMP x 30' RAMP FOR SINGLE RESIDENCE LOT.
- 2. WIDTH 10' MINIMUM, SHOULD BE FLARED AT THE EXISTING ROAD TO
- 3. GEOTEXTILE FABRIC (FILTER CLOTH) SHALL BE PLACED OVER THE EXISTING GROUND PRIOR TO PLACING STONE.
- 4. STONE CRUSHED AGGREGATE (2" TO 3") OR RECLAIMED OR RECYCLED CONCRETE EQUIVALENT SHALL BE PLACED AT LEAST 6" DEEP OVER THE LENGTH AND WIDTH OF THE ENTRANCE.
- 5. SURFACE WATER ALL SURFACE WATER FLOWING TO OR DIVERTED TOWARD CONSTRUCTION ENTRANCES SHALL BE PIPED THROUGH THE ENTRANCE, MAINTAINING POSITIVE DRAIMAGE. PIPE INSTALLED THROUGH THE STABILIZED CONSTRUCTION ENTRANCE SHALL BE PROTECTED WITH A MOUNTABLE BERN WITH 51 SLOPES AND MIN, OF 6' OF STONE OVER THE PIPE, PIPE HAS TO BE SIZED ACCORDING TO THE DRAIMAGE. WHEN THE SCE IS LOCATED AT A HIGH SPOT AND HAS NO DRAIMAGE TO CONVEY, A PIPE WILL NOT BE MECESSARY. PIPE SHOULD BE SIZED ACCORDING TO THE SIZED ACCORDING THE S ACCORDING TO THE AMOUNT OF RUNOFF TO BE CONVEYED. A 6" MIN.
- 6. LOCATION A STABILIZED CONSTRUCTION ENTRANCE SHALL BE LOCATED AT EVERY POINT WHERE CONSTRUCTION TRAFFIC ENTERS OR LEAVES A CONSTRUCTION SITE. VEHICLES LEAVING THE SITE MUST TRAVEL OVER THE ENTIRE LENGTH OF THE STABILIZED CONSTRUCTION
- 7. MAINTENANCE THE ENTRANCE SHALL BE MAINTAINED IN CONDITION WHICH WHILD PREVENT TRACKING OR FLOWING OF SEDMENT ONTO PUBLIC RIGHTS—OF— MAY THIS MAY REQUIRE PERIODIC TOP DESSNOW WITH ADDITIONAL STONE AS CONDITIONS DEMAND AND REPAIR AND/OR CLENGUT OF ANY WEASTES USED TO TRAP SEDMENT, ALL SEDMENT SPILLED, DROPPED, WASHED OR TRACKED ONTO PUBLIC RIGHTS—OF—MAY MUST BE REMOVED IMMEDIATELY.
- 8, WASHING WHEELS SHALL BE CLEANED TO REMOVE SEDIMENT PRIOR TO ENTRANCE ONTO PUBLIC RIGHT-OF-WAY WHEN WASHING IS REQUIRED, IT SHALL BE DONE ON AN AREA STABILIZED WITH STONE WHICH DRAINS INTO A APPROVED SEDIMENT TRAPPING DEVICE,
- 9. PERIODIC INSPECTION AND NEEDED MAINTENANCE SHALL BE PROVIDED AFTER EACH RAIN.

STANDARDS AND SPECIFICATIONS FOR DUST CONTROL

- THE CONTRACTOR SHALL CONDUCT OPERATIONS AND MAINTAIN THE PROJECT SITE SO AS TO MINIMIZE THE CREATION AND DISPERSION OF DUST, DUST CONTROL SHALL BE USED THROUGHOUT THE WORK AT THE SITE.
- THE CONTRACTOR MUST PROVIDE CLEAN WATER, FREE FROM SALT, DIL AND OTHER DELETERIOUS MATERIAL TO BE USED FOR ON-SITE DUST CONTROL.
- THE CONTRACTOR SHALL SUPPLY WATER SPRAYING EQUIPMENT CAPABLE OF ACCESSING ALL WORK AREAS.
- THE CONTRACTOR SHALL BMPLEMENT STRICT DUST CONTROL MEASURES DURING ACTIVE CONSTRUCTION PERIODS ON-SITE. THESE CONTROL MEASURES MIL GENERALLY CONSIST OF WARTER APPLICATIONS THAT SHALL BE APPLIED A MAMMAM OF ONCE PER DAY DURING DRY WEATHER OR MORE DITEN AS REQUIRED TO PREVIOUS DUST HASSIGNS,
- FOR WATER APPLICATION TO UNDISTURBED SOIL SURFACES, THE CONTRACTOR
- ${\rm A_{\odot}}$ APPLY WATER WITH EQUIPMENT CONSISTING OF TANK, SPRAY BAR, PUMP WITH DISCHARGE PRESSURE GAUGE,
- C DISPERSE WATER THROUGH NOZZLES ON SPRAY BAR AT 20 PSI, MINIMUM, KEEP AREAS DAMP WITHOUT CREATING NUISANCE CONDITIONS SUCH AS
- FOR WATER APPLICATION TO SOIL SURFACES DURING DEMOLITION AND/OR EXCAVATION, THE CONTRACTOR SHALL:
- A. APPLY WATER WITH EQUIPMENT CONSISTING OF A TANK, PUMP WITH DISCHARGE GAUGE, HOSES AND MIST NOZZLES
- B₀ LOCATE TANK AND SPRAYING EQUIPMENT SO THAT THE ENTIRE EXCAVATION AREA CAN BE MISTED WITHOUT INTERFERING WITH DEMOLITION AND/OR EXCAVATION EQUIPMENT OR OPERATIONS. KEEP AREAS DAMP WITHOUT CREATING NUISANCE CONDITIONS SUCH AS PONDING.
- C. APPLY WATER SPRAY IN A MANNER TO PREVENT MOVEMENT OF SPRAY BEYOND THE SITE BOUNDARIES.

DETAIL 1 - STABILIZED CONSTRUCTION ENTRANCE

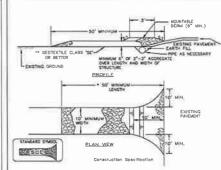

- 1. LENGTH MINIMUM OF 50' (*30' FOR SINGLE RESIDENCE LOT).
- 2. WIDTH 10' MINIMUM, SHOULD BE FLARED AT THE EXISTING ROAD TO PROVIDE A TURNING RADIUS GEOTEXTILE FABRIC (FILTER CLOTH) SHALL BE PLACED OVER THE EXISTING GROUND PRIOR TO PLAGING STONE. "THE PLAN APPROVAL AUTHORITY MAY NOT REQUIRE SINGLE FAMILY RESIDENCES TO USE GEOTEXTILE.
- 4. STONE CRUSHED AGGREGATE (2" TO 3") OR RECLAIMED OR RECYCLED CONCRETE EQUIVALENT SHALL BE PLACED AT LEAST 6" DEEP OVER THE LENGTH AND WIDTH OF THE ENTRANCE.
- SUPPLIES AND ALL SEASON ENTER CHANGE FOR MORNING THE DEPARTMENT OF THE DEPARTMENT OF
- LOCATION A STABILIZED CONSTRUCTION ENTRANCE SHALL BE LOCATED AT EVERY POINT WHERE CONSTRUCTION TRAFFIC ENTERS OR LEAVES A CONSTRUCTION SITE, VEHICLES LEAVING ENTRANCE LIST TRAVEL OVER THE ENTIRE LENGTH OF THE STABILIZED CONSTRUCTION

U.S. DEFARMANT OF ADMINISTRATE PAGE NATIONAL PROTECTION DIVISION NATURAL REDUNCT COMMENSATION SERVICE A - 1 - 3 DETRICT OF COLUMNS OFFARMANT OF HEALTH

SILT FENCE

Sill Fence Design Criteria

Supe Steepness	(Maximum) Slope Length	(Maximum) Silt Fence Length
Flatter, then, 50:1	unlimited	unlimited
50:1 to 10:1	125 feel	1,000 feet
10:1 to 5:1	100 feet	750 feet
2:1 to 3:1	60 feet	500 feet
3:1 to 2:1	40 feet	250 feet
2 Y and steaper	20 feet	125 feet

Note: In areas of less than 2% slope and sandy soils (USDA general closelfication system, soil Close A) maximum slope length and six fence length will be unlimited, in these areas a six fance may be the only perimeter control

U.S. DEPARTMENT OF ADRICULTURE PAGE BATEKSHID PROTECTION DIVISION BATEKSHID PROTECTION DIVISION BETWEEN ACCOUNTS OF HEALTH


STANDARDS AND SPECIFICATIONS FOR STREET SWEEPING

- STREETS WITHIN ONE MILE SHALL BE INSPECTED DAILY, ANY DROPPED SOIL. DUST AND YOR DERRIS SHALL BE REMOVED
- VACUUM TYPE STREET CLEANER SHALL BE USED TO EFFECTIVELY REMOVE TOTAL DUST AND DIRT ON PAVED SURFACES.
- 3| ROADS SHALL BE SWEPT ON A WEEKLY BASIS (MINIMUM) DURING ALL ON AND OFF SITE HAULING OPERATIONS FOR UP TO ONE MILE ALONG HAUL ROUTES.

ESC DETAILS NOTES:

- 2 COORDINATE ESC MEASURE WITH THE DDGE INSPECTOR, INSTALL ADDITIONAL MEASURES AS REQUIRED BY THE DDGE INSPECTOR,
- 3, ESC DETAILS SHOWN ON THIS SHEET MAY NOT BE REQUIRED FOR THIS SPECIFIC PROJECT AND ARE INCLUDED IN THE EVENT THE DODE INSPECTOR REQUIRES ADDITIONAL ESC MEASURES TO BE INSTALLED.
- 4. SPECIFICATIONS FOR ESC MEASURES ARE INCLUDED IN THE ESC NOTES AND DETAILS AND ARE NOT REFERENCED IN THE PROJECT SPECIFICATIONS REFER TO DOCE STANDARDS &

DETAIL 4 - SILT FENCE

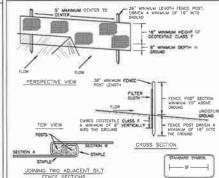


CONSTRUCTION SPECIFICATIONS

- 1. FENCE POSTS SHALL BE A MINIMAN OF 38" LONG DRIVEN IS" MEMANA MITO THE CROWNED. WOOD POSTS SHALL BE 11/2" IN 1/2" SQUARE (MINIMAN) QUIT, OR 13/4" DAMETER (MINIMAN) ROUND AND SHALL BE OF STAND CHALLIFF HARDWOOD STEEL POSTS WILL BE STANDARD T OR U SECTION WIDGHTING NOT LESS PHAN 1,00 POIND HER NIEGAR POOL
- - RESELT MODULUS 20 LASAN (New.) 1237 457W 0-4395 O.S CAL/FT /ANNUTE (MAK.) TEST: ASTM D-5141 FLIEFING DIFFOUNCY FEX (NIN.) MEST WESTER DESIGN
- A MESS ENDS OF SCOTEFFEE FARMS COME TOO THERE THEY SHALL ME CHARLAPPEE FOLDED AND SCAPLED TO PROCEENT SEGMENT SHAPES.
- 4. SET FENCE SHALL BE INSPECTED AFTER EACH RAINFALL EVENT AND MAINTAINED WHEN BULGES OCCUR OR WHEN SECREENT ACCUMULATION REACHED 30% OF THE FABRIC.


U.S. SCHARGOUT OF AURODOLUME PAGE WATERSHED PROTECTION OWNSON

AND RESOURCE SOMEWHATEN MEMORE \$ 5.5.3 DISTRICT OF DOLUMBIA DEPARTMENT OF HEALTH

DETAIL 6B - AT GRADE INLET PROTECTION

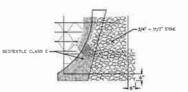

PLAN/CUT AWAY VIEW

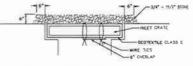

CROSS SECTION WAX. DRAINAGE AREA = 1/4 ACRE

- grate and wrop with Geotextile Class E to completely cover all openings, then set grate back in place
- 2. Place $3/4^\circ$ to $11/2^\circ$ stone, $4^\circ-6^\circ$ thick on the grate to secure the labric and provide additional filtration.

M.S. SCHARMONT OF ADRIGUATED PAGE NATERSHED PROTECTION DIVISION NATURAL RESOURCE CONSERNATION SCHWICE # - 3 - 8 DISTRICT OF COLUMBIA DEPARTMENT OF HEALTH



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SUBMISSION SCHEDULE DATE CONSTRUCTION DOCUMENTS SET 9/21/15 DATE REVISION SCHEDULE DYRS-YOUTH SERVICES

CENTER COURTYARD RENOVATIONS


1000 MOUNT OLIVET ROAD, NE

EROSION & SEDIMENT CONTROL DETAILS

PROJECT NO: 113-506 SCALE: N/A SHEET NO:

C-3.2



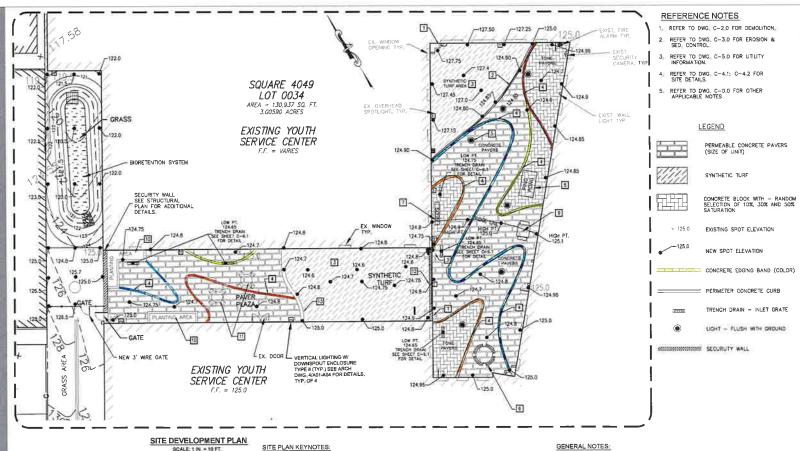

GRAPHIC SCALE

48 HOURS BEFORE YOU DIG CALL "MISS UTILITY" AT 202-265-7177 OR 811 OR LOG ON TO http://www.missufility.net

MISS UTILITY

SITE PLAN KEYNOTES:

- 1 WALL EXTRUSION COLOR ACCENT FEATURE REFER TO ARCHITECTS PLAN FOR DETAILS
- 2 CONCRETE PERIMÉTER CURB REFER TO DETAIL ON CIVIL DWG, C-4,1
- 3 SYNTHETIC TURF (STAGE) SURFACE REFER TO DETAIL ON CIVIL DWG C-51
- 4 CONCRETE EDGING WITH MIXED COLOR HUES TO MATCH INTERIOR POD COLORS
- 5 LIGHT FIXTURE REFER TO ELECTRIC PLANS FOR ADDITIONAL INFORMATION, TYP. OF 6
- 6 ROUND TABLE FOR 12 PERSONS REFER TO DETAIL ON CIVIL DWG. C-4.2
- 7 NEOS ELECTRONIC GAME FOR CHILDREN REFER TO DETAIL ON CIVIL DWG C-4/2
- 8 PING PONG TABLE, SECURED TO FLOOR SEE DETAIL ON CIVIL DWG, C-4,2
- 9 GAME TABLE TO BE SECURED TO FLOOR SEE DETAIL ON CIVIL DWG C-4.2
- 10 6" CONCRETE PLANTER AREA (SEE DETAIL ON C-4.1)
- 11 ROUND TABLE FOR 4 PERSONS REFER TO DETAIL ON CIVIL DWG C-4.2
- 12 SECURITY ROLL UP DOOR
- 13 14" RAISED CONCRETE SEAT WALL (SEE DETAIL ON C-4.1)

- CONTRACTOR TO ENGAGE AN UNDERGROUND UTILITY LOCATION SERVICE TO LOCATE, IDENTIFY, AND MARK ALL UNDERGROUND UTILITY LINES PRIOR TO UNDERTAKING ANY EXCAVATIONS.
- 2 ALL CONCRETE WALK, CURB AND GUTTER SHALL CONFORM TO DDOT STANDARDS AND SPECIFICATIONS.
- 3. ALL STORM DRAIN WORK AND MATERIALS AND METHODS SHALL CONFORM TO STANDARDS AND SPECIFICATIONS OF DOWNTER
- 4. CONTRACT MISS UTILITY AT 202-265-7177 FOR MARKINGS OF EXISTING UNDERGROUND UTILITIES BEFORE EXCAVATING ANY WORK.
- 5 CONTRACTOR TO TEST PIT FOR LOCATION AND DEPTH OF EXISTING GAS AND ELECTRIC BEFORE EXCAVATING FOR ANY WORK DEPICTED ON THIS PLAN.
- 6. SEE THE COVER SHEET FOR ADDITIONAL NOTES THAT APPLY TO THIS PHASE OF WORK,

DGS (DEPARTMENT OF GENERAL SERVICES)
post inin smelt not after load
we sensition on more

ARCHITECT

LANCE BAILEY & ASSOCIATES

FINISHED TO 20012

1 001/M5/283 F DEL/M-1387

CONSULTING STRUCTURAL ENGINEER

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1765 PECANDONIC SELECTION
BECKMILE NO 2002
1 (201) 216-2011 C (201) 216-0011

AMT

ENGINEERS CERTIFICATE



SUBMISSION SCHEDULE DATE CONSTRUCTION DOCUMENTS SET 9/21/15 DATE REVISION SCHEDULE

DYRS-YOUTH SERVICES CENTER COURTYARD RENOVATIONS


1000 MOUNT OLIVET ROAD, NE WASHINGTON, DC 20002


SHEET NO:


SITE DEVELOPMENT PLAN

PROJECT NO: 113-506 9/21/2015 SCALE: 1 IN = 10 FT

C-4.0

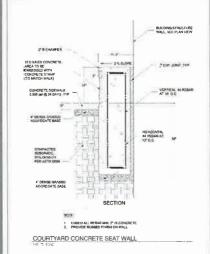

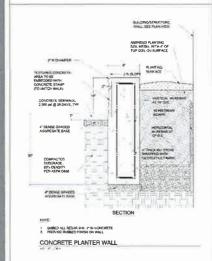

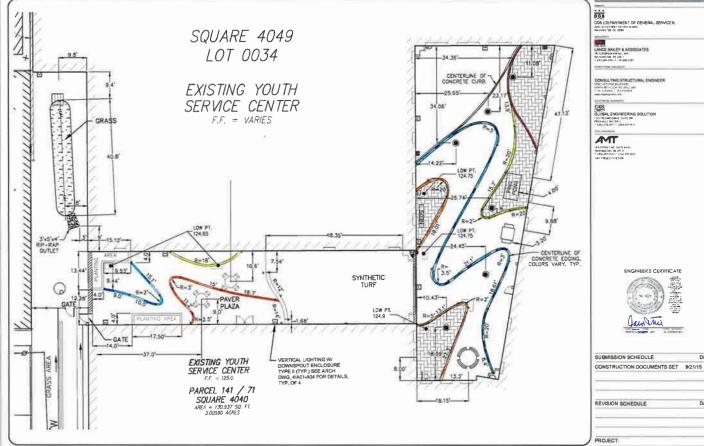

GEOMETRIC LAYOUT PLAN SCALE: 1 IN = 10 FT.



DYRS-YOUTH SERVICES CENTER COURTYARD RENOVATIONS

ENGINEER'S CERTIFICATE

1000 MOUNT OLIVET ROAD, NE WASHINGTON, DC 20002

SHEET TITLE:

SITE GEOMETRIC LAYOUT PLAN AND DETAILS

PROJECT NO: 113-506 9/21/2015 SCALE 1 IN . = 10 FT. SHEET NO:

C-4.1

DATE

DATE









DOS (DEPARTMENT OF GENERAL BENVICES) which would be it at a service of the servic

E3HC-CCU fref BUCKVARD UCENIC EXTRICTOR ND JUHIS TRAN SEL GET ORD F T TO AND GRAD THE BOOKER FROM THE SEL GRAD U.S. FOR THE SEL GRAD

1, 1811 (1994) 1 (1934) 16 92/Vol. (1996) 0,844 1 (1934) 16 1801 (1994) 1844 1 (1934) 168

CMF EMONEÇA L HD15392441 - 1533H742441 BOCHMTC AD 2003

100 22011 RF \$110 443 WASHING LG 2010 1 (101) 241 450 ((2010)

NEOS ROUND TABLE

Neos Electronic Game:

Product: ROUND TABLE Available From: Playworld Systems Inc. 1000 Buffalo Rd Lewisburg, PA 17837 PH: 570-522 3800

Notes:

Or approved equal
 Install per manufacturers recommendations

NEOS ELECTRONIC GAME

Neos Electronic Game:

Product: Electronic Wall


Available From: Playworld Systems Inc. 1000 Buffalo Rd. Lewisburg, PA 17837 PH; 570-522 9800

Notes:
1. Or approved equal
2. Install per manufacturers recommendations


CONCRETE PING PONG TABLE

Product: Concrete Table Tenns Auxiliative From. Brawsto Outstoor Products LLC 1196 Echo Dr. Roseburg, OR 97470 PH: 541-573-0536

Dr approved equal
 Install per manufacturers recommendations

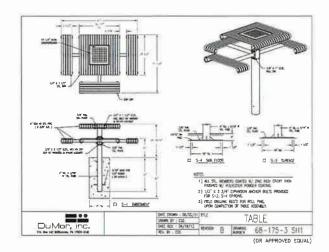

OUTDOOR GAME TABLE

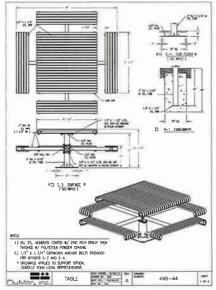

LARGE OUTDOOR SEATING TABLE

(OR APPROVED EQUAL)

ENGINEER'S CERTIFICATE

OLIVERY

OLIVER

REVISION SCHEDULE	
	DATE
PROJECT:	
DYRS-YOUTH SE	

1000 MOUNT OLIVET ROAD, NE WASHINGTON, DC 20002

SUBMISSION SCHEDULE DATE
CONSTRUCTION DOCUMENTS SET 9/21/15

SHEET TITLE:


HARDSCAPE DETAILS


PROJECT NO: 113-506
9/21/2015
SCALE: N/A
SHEET NO:

C-4.2

DATE



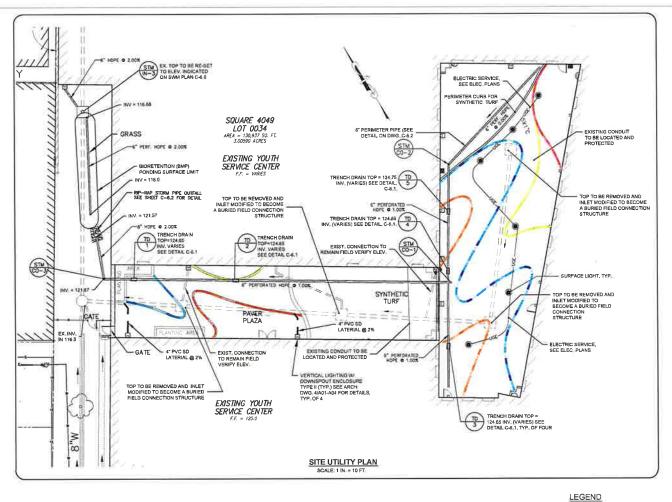

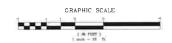

NEW STORM DRAIN LINE

NEW TRENCH DRAIN

EXISTING STORM DRAIN PIPE

EXISTING SURFACE LIGHT

Ε ΕΧΙSTING ELECTRIC CONDUIT

DOS (DEPARTMENT OF GENERAL SERVICES)
200 IN STOREY MA SHIPLICEDS
ASSENCED OF CLIFFIE

PROGCOPION PARENTE NAN WASHINGTON DC (2012) 1 (2012/95 2207 / (2012/95 2207

CONSULTING STRUCTURAL ENGINEER

RESTRICTION OF THE PROPERTY OF

1 (181) 21622 FT | (201) 216 PM |



SUBMISSION SCHEDULE DATE
CONSTRUCTION DOCUMENTS SET 921/15

REVISION SCHEDULE DATE
PROJECT:

DYRS-YOUTH SERVICES CENTER COURTYARD RENOVATIONS

1000 MOUNT OLIVET ROAD, NE WASHINGTON, DC 20002


SHEET TITLE:

SITE UTILITY PLAN

PROJECT NO: 113-506 9/21/2015 SCALE: 1 IN = 10 FT

C-5.0



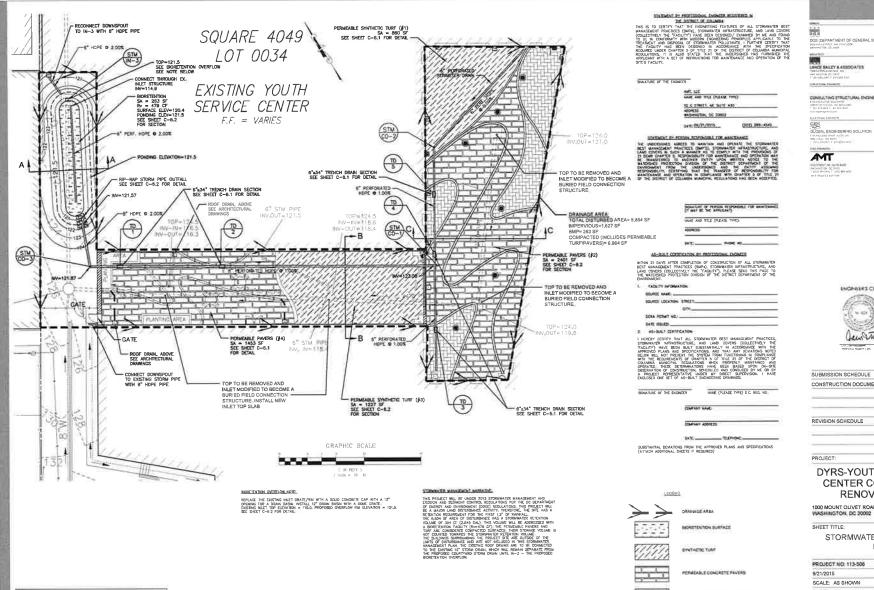

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48 HOURS BEFORE YOU DIG
CALL "MISS UTILITY" AT 202-265-7177 OR 811
OR LOG ON TO http://www.missutlity.net

DGS (DEPARTMENT OF GENERAL SERVICES) CONSULTING STRUCTURAL ENGINEER



DATE CONSTRUCTION DOCUMENTS SET 9/21/15 DATE


DYRS-YOUTH SERVICES CENTER COURTYARD RENOVATIONS

1000 MOUNT OLIVET ROAD, NE WASHINGTON, DC 20002

STORMWATER MANAGEMENT PLAN


CONCRETE PAVERS IMPERVIOUS

C-6.0

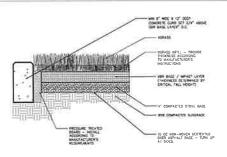


- DRAWINGS NOT TO SCALE; DO NOT SCALE DRAWINGS INSTALL PER MANUFACTURER'S SPECIFICATIONS. CONTRACTOR SHALL INSTALL SCREENING TO MEET THE REQUIREMENTS OF RIGHT ALL AREAS PER MANUFACTURER'S DESIGN TO MEET THE REQUIREMENTS FOR THE PLAY EQUIPMENT WITH THE HIGHEST ORTHITCAL FALL HEIGHT


XGRASS SYNTHETIC TURF SURFACE AND TRANSITION

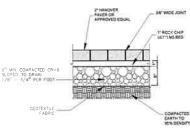


PERMEABLE PAVING OVER AGGREGATE

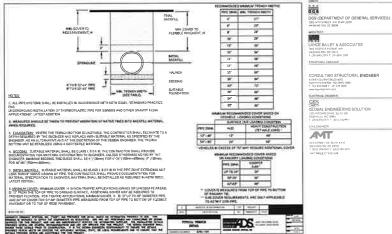

PIPE TRENCH DETAIL

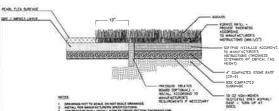


XGRASS SYNTHETIC TURF SURFACE AND TRANSITION

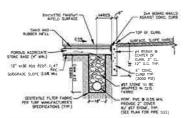

CENERAL NOTE: FOR LOCATION OF PERIMETER DRAIN FOR EACH COURTYARD AREA SHALL BE INSTALLED PER THE STORMWATER PLAN. THIS IS GENERIC DETAIL.

TYPICAL PERIMETER DRAIN
SECTION A-A'
NOT TO SCALE



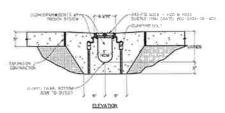

MODE

1. BISTALL BLACCORDANCE WITH NANUFACTURER'S SPECIFICATIONS.
2. ADD REBAR AS REQUIRED

3. STANLAND-CHAMBLE LENGTH IS 6°-0° (8°)


4. STANLAND CHAMBLE SLOPE S C 5°A

- FINISH SPECIFICATION

 1. GRATE FRAME BLACK PAINT STANDARD

 2. DUCTILE FROM GRATE LIEG-0-24-IDHADA ADA COMPLIANT

TRENCH DRAIN DETAIL

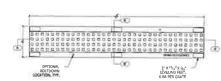



TRENCH DRAIN GRATE

1. PROVIDE ADA ACCESSIBLE URBAN ACCESSORIES TRENCH DRAIN OR APPROVED EQUAL.



SUBMISSION SCHEDULE

DYRS-YOUTH SERVICES CENTER COURTYARD RENOVATIONS

ENGINEER'S CERTIFICATE

Jan True

CONSTRUCTION DOCUMENTS SET 9/21/15

1000 MOUNT OLIVET ROAD, NE WASHINGTON, DC 20002


SHEET TITLE:


STORMWATER MANAGEMENT **DETAILS**

PROJECT NO: 113-506 9/21/2015 SCALE: N/A SHEET NO:


C-6.1


DATE

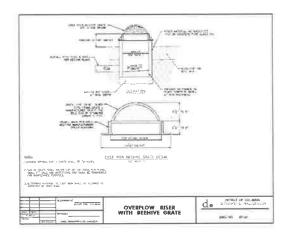


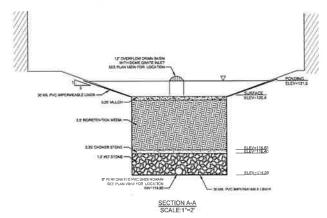



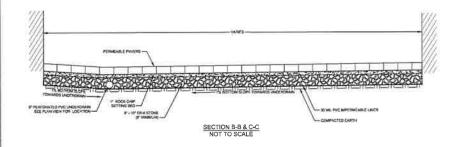


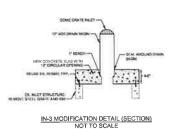

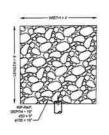



ENGINEER S CERTIFICATE

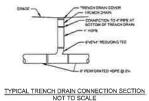

1000 MOUNT OLIVET ROAD, NE WASHINGTON, DC 20002 SHEET TITLE:

PROJECT:

UNDERDRAIN PERFORATION DETAIL

STORMWATER MANAGEMENT DETAILS PROJECT NO. 113-506 9/21/2015 SCALE: N/A SHEET NO.

DYRS-YOUTH SERVICES CENTER COURTYARD RENOVATIONS



C-6.2

Moretention .								
Harp Is Deline the Drahage Area				5WR	· PxHRex's	D+(Rext)C)	- DRUGE MINER D	A1 2 7.48
Total Drainage Area (SA) =	6854 SF			1-000	12			
Total Impervious Area (A) =	1890 SF		23.25N		- 0.95			
Impervious Area Vehicle Accessible -				R ₂	c = 0.25			
Total Compacted Cover Area (Ac)=	6701 SF	*	75.585	N-	4.0			
Total Natural Cover Area (As) =	0 SF		0.00%	7,8	E - Comers on Fe	ator New Of to G	AL.	
					2 - Convers on Fi	giner from the na. F		
STEP 2: Colorate Maximum Stormwate	r Retentio	n. Valu	me (SWR)			0		
Maximum Storm Event (P) =	1.7 in			Storage Volume	* SAX (Guess	V FARDIN - HE	uit: × Fatural *	CONSING STORA
Target SWRV =	492 CF		3678 GAL	who	re: nav	_{0:4} × 0.25		
					7.70%	m = 0.40		
STEP 3: Calculate Storage Volume Provi	ided							
Facility Surface Area, SA =	263	SF		Directla Check	Reg	5.20		
Depth of Media (dupps) -	3.5	FT			SACDA (KI = 3.0%	Gisteroore	June 2013)
Max Altowed Media Depth =	5.5	FT			owed Modia Depti			
Depth of Gravel (depose) =	1.5	FT					Culture sciences; replic	me, Additional
Subsurface Storage =	388	CF		med a depth will	met count toward	storage volume	requirement.	
Depth of Panding =	1.00	FT						
Ponding Storage a	411	CF		Secretarion	Paraling Area	Elevation Storage	e Curse	
Storage Volume Provided (5y) =	799 CF		5976 GAL	Firentian (N)	Area (sf)	Inc. Vol (cl)	Com this (et)	
Witt Underdrains be Provided?	YES			120.50	263	0	9	
SWIN Credited a	471.0		TIME GAL	121.50	559	411	411	

BIORETENTION CALCULATIONS

- DRAW DOWN CALCULATIONS
 t=(dxys2)/i
 t=(dxys2)/i
 t= MAXIMUM PRAWDOWN TIME (dxys)
 d= DEPTH OF RESERVOR LAYER (I)
 p= WOIL RATO
 p= WOIL RATO (X)
 t= WITLINATION RATE (t/dxy)
 t= 3 in/hr x itt/12in x 24tr/dxy = 6 tt/dxy
- l = (1.486 m 0.35 k 2)/6 = 0.165 doys X 24 hr/doy = 4 hr

Site Addre	SS	1000 N	Sount Divet Rest NE	Plan number	4864		
Stormwatz	er Management Plani	? Yes		Green Area Ratio	? No G	AR does not apply to t	nic property
Soll Emsio	Soll Ension and Sediment Control? Yes				e7 No		
Type of Ac	ype of Activity Major Land Disturbing				NOT AMOUNT	e lected within 2000)	DOUBLING
Is the entire	re sate in the CSS?	Yes					
	Total Area (sf)	Site Area	PROW	Carres Harrabers			
Natural	0	0		Detention req	mpeuseus ca	loulated with rational r	vershord?
Compacte	d 6,964	6,964		Pre-oevelopmen	1 70	2-year storm adjuste	d QN
Ingenies	1,527	1,627		Pre project	D	15-year storm adjust	ed CN #
BIAP	263	263				100-year storm adju	iced EN
Total	8,854	8 854					
Regulative	www.Seconomy (tota	d is the sum	of PROW and Parcel)	PROW (lt³) Pares	(fit ²) Total (ft ²)	Total (Galtons
SWRv					354	354	2.645
WOTV					D	0	D
On-sitte ret	tention achieved				479	479	3.536
On site tre	atment achieved				22	22	162
% of SWRs	r met on site				136%	L35.56%	135.56%
SRC alligible	Roy (all numbers in g	allons}					941

STORMWATER MANAGEMENT PLAN COMPLIANCE DATA

Site Orainage Area (D	(Right ad		Hataral (square (ma)	Compatted (square feat)		(met) (square (3/m	Marine de la companya	Brathic	(cobic	Valuese retained (cobic (mx)		Eryene doorne mijested Curve	Styres down adjusted Curve Number	storm adjusted Carve	Compliant
IS64-1	.0	3.854		6,564	1.627	293		354	U	429	22		C.		16/W

SITE DRAINAGE AREA COMPLIANCE DATA

IMP D	Турч		Hataral Square Squit	(Conspanded Inquites (Last)	(1941)	II	Project project success areas	From MAD's (code)	Man with man by Man (colds:	(cubic feet)	in the			
KL M	Tractional horetentus	9,854		6,964	2,625	26			50)	799	10% of storage	479	22	

SITE BMP COMPLIANCE DATA





SUBMISSION SCHEDULE	DATE
CONSTRUCTION DOCUMENTS SET	9/21/15
REVISION SCHEDULE	DATE

DYRS-YOUTH SERVICES CENTER COURTYARD RENOVATIONS

1000 MOUNT OUVET ROAD, NE WASHINGTON, DC 20002

SHEET TITLE:

STORMWATER MANAGEMENT CALCULATIONS

PROJECT NO: 113-506 9/21/2015 SCALE: N/A SHEET NO:

C-6.3



DODE STORWWATER MANAGEMENT GUIDERCOX BIORETENTION SPECIFICATIONS DOOR PERMEABLE PAYEMENT CRITERIA & CONSTRUCTION SEQUENCE

Permeable Paremeer Landscaping Criteria

Promotile pur caser sizes as I am as I lank-oppus and associated staff. It Homework large-cube ground his per caser as placemas, dood for carefully planned to use provide for you. An example the properties of the properties of

3.5.6 Permeable Payengus Construction Sequence

Expensive has share that proper association is absolutely critical to the effective operation of a permutable parameter system.

Soil Erosion and Sediment Countries. The following and convers and undersed control guidelines must be followed during construction:

- · All permeable pavement areas must be fully protected from sediment nurusion by salt frace or construction feneral, particularly if they are intended to infiltrate rimoff.
- Percentile provised area selected to inflation music music music metals the best of destribute dwarg construction to prevent seal comparison to termy expressed and loss of design additions are realise the area has been determined to large a lost CER and will require compartion during the premotile parameter contentation place). When it is indepuble to keep the proposed personalite pureness tooss surrole of the limits of destructures there are reveal possible concesses for the impacted sizes.
- If examinous in the proposed parametric previous in some was be to revised their.
 If examinous in the proposed parametric previous in the proposed of in controls are not districted any object in the control and proposed of the proposed proposed of the proposed parametric proposed of the proposed proposed of the proposed proposed of the proposed parameter the proposed parameter the proposed proposed of the proposed parameter the proposed parameter the proposed parameter the proposed parameter than the proposed parameter
- Alternatively, if it is infrasible to keep the proposed permemble pureament sters outside of
 the limits of destributes, and experiment of the unsa cannot be restricted common be size,
 them infligingues ress will be required prior to installation of the permeable pureament to
 construct that the design inflication rate is with persent. If these reveal the tors of design

DODE PERMEABLE PAYEMENT MAINTAINCE CRITERA

3.5.7 Permeable Parement Maintenance Criteria

Manuscance is a required and criscal element to ensure the long-term performance of permeable partenene. The most frequently cared monitorance problem is studies elongoing caused by organic moister and sediment. Periodic struct sweeping will remove a contembaled selement and help prevent clogging; however, it is also critical to ensure that surrounding hand areas remain

The following tasks mass be avoided on ALL permeable payements

- Sandmø
- * Re-sealms
- * Re-surfacion
- Power washing
- . Strenge of spirit pains containing used . Saurage of mulch or soil materials
- . Construction staging on trapporected parternent
- It is difficult to presente the specialic types or frequency of ministrance trivial that are needed to ministra the lighthologic frauthout of persistoke parameter content over time. The frequency of ministrance will depend largely on the provincent me, triffer lands and the stressmoothy than

One percentage maintenance task for large-scale applicances (e.g., perkage law) arrefres to common propriet on a ferguency common task for one and leadings encountered in the site.

- militation care, then deep tiling gracines may be oved to an effort to resoote those exics. In this case further resting nard be done to establish design rates exist before the permeabile part existed as
- Finally, if a scalar file to here the proposed personnel personnel area octaste of the large of demonstrate and error whose of the sent a must be entireful and unfiltration extra-reveal design parts; cannot be trackered, then a problemation of the SMAP will be
- Permeable povenient areas must be clearly marked on all construction documents and grading plans
- During constitution, case should be taken to strong tracking sediments onto any permeable
- pavement surface to aroud post construction clogging and long term manuferance procures which early compose content to congrue man any real manufactures content and any early of the first extended attractive to be a question for member are revisal as infillization component ment not be tend as the size of a temporary softment trap or thosis. If locating a temporary softment trap or bases no as a near member for personal premainr is uncondibile, the outcomes are parallel to those discussed for beavy opaqueness compaction.
- If it is possible restrict the invert of the sediment map or busin at least 1 floor above the final design elevation of the bortom of the argue-gave revervour course of the proposed permeable partners their transferring can be achieved with proper persoval of trapped achievement of these OFFICE constitutions.
- An alternate approach to deep tilling is to use an impermeable linear to protect the usuto soils from sedimenation while the sediment trap or basin is in use.
- . In each case, all sediment deposits in the excavated area must be carefully removed prior The show the province BMP including desirence (clemon, and subdiction).

DODE STORWWATER MANAGEMENT CUIDEBOOK BIORETENTION SPECIFICATIONS

The MATERIA DE CONTROL DE CONTROL

DOOR BIORETONTION MATERIAL SPECIFICATIONS

The state of	*periferent	-
Ffor Walte	. Lean Ch	Observational in adjacet for each of section of seather the property of the pr
Medale Lapon	Excaped stagistic luminoset back seek. In	N.in. + 7 on Kirrock began marker randoccord cha- liation had.
Marsatve Verlau Cretz	(ne ever come ar year peaved, don't mile year gameng, or mill cover	Light 7 to 1-leak hear of to reprove worth
Top Sort For Tod Coury	Language part per trong of tacker Pulse makes (F) and substitutes and T and managed speciments of pieces (C.	No. Bit dialisms surface by co
Commente or Christog Layer	As appropriate them, the complete and appropriate Class 2 learning to the foreign and appropriate of a first an extension of an appropriate of a first an extension from the complete and appropriate and appropriate properties and the sent	Experience of the dynamic transition is the time of the product to from a final product to the section of the section of the contract of the c
	Lat y) we have been of these time or y, which	B to the terrecest prominents
Entertore plene	True, is the mater where where the shadow markers and object, we have of all financing and the place that	As liquid 2 yackers, where a read tection rates analized trees
Spraps Lance exportable	To make white the transport of the state of the state of	or present per and water augment.
Enter Sales mopeonide	The appearant as a first and community Pri	Clarametry stee
т жене фициа. «Перирона», оже Одноги доски блефа	Unit 4 or 1 on the continue to 5 or 1, part, or injurished to 16 or 16 o	Lie die provinciati pape reductive dei aussiere die feromenome (so del empté into posiciation) apre 20 etraficia to devente, wate de sociolo diazio in respirate deglis es si standardis diazione, socialistation. Paradit 1 feat. arcelos, dispositingi via the dataritiment cantiferatione. Unavois dispressi proprio in the settium.
Free Manus	Yor Silvan 7-13 Emission Landsupray Consis	Label year armed a symbol a fer indexprogram and the accommissed prior

Signage, Removation work in health, advanced man should be executed, as absenting permanently seeked to designate in the absenced BMP. The street of strape should substrate an ware studies respect to the or many peed fourther except on regions. On the other except of regional constraints:

GOOK BIORETENTION CONSTRUCTION SPECIFICATIONS

Sall Energina and Sediment Controls. The following well eros to and subment control guidelines mass by followed during supermation.

- * All Riorgenton group must be fully projected by will force or any traction function Protection areas intended to infiliate mostly must continue to the finit of drawbamb during construction to prevent suit compaction by intervience and prices and loss of design additionance rate
- of littors can be sufficient to the sufficient to the sufficient to the sufficient of the littors of the littors of the littors of the littors of the sufficient to the control of the sufficient to the control of the sufficient to the sufficient t
- Antensainorde, i fi a la sidigazibit a si luegi the propried permecci a percenor associació de de face es de describeració, alle ricomania de la cesa o como le receivació de de del propriedo de la como de la cesa de el eficiación cesa e a del percent i il lasta de la cesa de la desperio infolación cesa de el eficiación cesa de la precenta de lasta de la cesa de la desperio de la cesa de el eficiación de la cesa del percenta de lasta de la cesa de la deligida de el esta del percenta de la cesa del percenta de la cesa de el esta del percenta de la cesa del percenta de la cesa de la cesa del percenta del percenta de la cesa del percenta de
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- . Restorain man nice to death, nested on all court other decisions and grating plan-A Large bordestroom applications many bet used an strail industrial traps on termin change contraction. However, there must be accompanied by major wall people desired on the control and advances controlly plate specification strail of the security assets of the control of the control control plate in the control of the facility can be for the control of the control of the facility can control of the control of the control of the facility can extrain an understand the plane of the control of the control of the facility can extrain a surface of the plane can also the control of the facility can extrain a surface of the control of

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Step 3; Layered Invadintion of Wellin Apply the reeds in U-lock lefts well to desired ten-cles when of the locateston arm is achieved Wal a few devices check for renderent and add-editional media, as rended, to achieve the design elevation.

DOOR BIOPETENTION MAINTENANCE SPECIFICATIONS

When its actions on a man are installed, it is the owner's respectablely to resolve they, or these meanings the practice, (1) be of sold about their manner renormance could. (2) and manner the long-term manner man plan, and (3) be adjusted to a manner and concerned or agreement, as described below.

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archerologic, the band-caping, template observes, and the type of sofface rever in the practices. A mesh real vary vary of common mer formance trails and shair Ecopology is provided in Table

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Nickas Protespirate	This year the wije publishment of refused This publishment of the supplied by being and decide as, but offer.
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RTMENT OF GENERAL SERVICES)

MOCHALEY & ASSOCIATES ##5+NOTO+ DC 2851/2 T 001 045-2303 C (201046-2287

REMOVE AND STRUCTURAL ENGINEER

SLOBAL ENGINEERING SOLUTION

AMT

ENGINEER'S CERTIFICATE

Jam Vici

DATE SUBMISSION SCHEDULE CONSTRUCTION DOCUMENTS SET 9/21/15 REVISION SCHEDULE DATE

DYRS-YOUTH SERVICES CENTER COURTYARD RENOVATIONS

1000 MOUNT OLIVET ROAD, NE WASHINGTON, DC 20002

SHEET TITLE:

PROJECT

STORMWATER MANAGEMENT MAINTENANCE SCHEDULES

PROJECT NO: 113-506 9/21/2015 SCALE: 1 IN = 10 FT

SHEET NO:

C-6.4

Many experts consider an annual, dry-weather sweeping in the spring mouths to be important. The contract for sweeping about depently that a vaccious sweeper be used that does not use water spary, since appraign gazy lead to subsurface clogging. Typical instancement in the same offined in

Table 3.15 Trained Management Tasks for Permeable Patement Practices

Trequest.	Monomance Torky		
After monilation	 Fast tar first 6 samella. (r Commune communes, the practice and CDA should be angiorned at least trace of the status or sen that exceed 12 such of ramfall Conduct are harving largest as exhibitations. 		
Occe every 1-1 mounts degree the growing sensors	Move grass to gold power applications.		
As meded	Statistion the CDA to premare execut. Descript any uniform relations dependent in permanent. Deplice in region our premiums multipost due to depresenting or qualiting.		
(क्रांच्यक्र क्रांच्य) इन्हें ट्यांड क्रांच्य	Medianatic meny pursuant will a maked other prespet to pre-ear absolute.		
Azzanily	Conduct a manufacture impaction Spot mend for grant applications		
Oscerney 2-3 years	* Present may mutualized ordinate to portendent soft and soften poors		
If clousted	Conduct manuscree under a reasserance street ruseper or a victum tweeper Perfore non necessary road manual.		



ELECTRICAL LEGEND

GENERAL NOTES

- THE WORK TO BE DONE SHALL INCLUDE THE FURNISHING OF ALL LABOR SATERIALS APPLICACES SOUTHERS TO COST THAT AT A TO TO
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 MODIFY FOR ELECTRICAL STATISHES AS HAVE AS SPECIATED AND SHOWN OF HERE.
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 PRIFTORISHED OR HITTALLED OF DITHESE AFFICIAND THE ELECTRICAL MODIFY, AND THE CONTROL AND THE ADDRESS OF OR THAT A THAT AND A STATISHES AND THE ADDRESS OF OR THAT A THAT AND A CONTROL AND THE ADDRESS OF OTHER
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 THAT AND THE ADDRESS OF THE
- 2. ALL ELECTRICAL WORK SHALL BE PERFORMED IN STRICT ACCORDANCE WITH THE LATEST ADOPTED NATIONAL ELECTRICAL CODE AND ALL OTHER LOCAL CODES AND AUTHORITIES HAVING JURISDICTION
- THE DRAWINGS WHICH CONSTITUTE A PART OF THIS CONTRACT, INDICATE THE THE DEWINDS, WINDOWS OF CHOURT AND LOCATIONS OF CHUTTER WHITCHES.

 PANELBOARDS, CONDUIT AND OTHER WORK, ALL ITEMS NOT SPECIFICALLY
 MENTONED HEREA WHICH KIE ACCESSORY TO MAKE A COMPLETE WORKING. INSTALLATION, SHALL BE INCLUDED AT NO EXTRA COST
- IT SHILL BE THE RESPONSIBLITY OF THIS CONTRACTOR TO EXAMINE AND TO COORDINATE WITH THE ARCHTECTURAL STRUCTURAL MICHANICAL PLUMBING AND FIRST PROTECTION CRAWINGS AND THE DRAWINGS OF ALL STHER TRACES IN ORDER TO BECOME FAMILIAR WITH ALL ASPECTS OF THE DESIGN AFFECTING
- CONTINUETOR SHALL COORDINATE MOUNTING HEIGHTS AND LOCATIONS OF ALL MAY ELECTRICAL DEVOCES WITH ARCHITECTURAL ELEVATIONS AND DRIBANASS HIGHOST OF COMMISSION OF MOUNTS INCLUDE BUT ARE NOT LIMITED TO RECEIPTACLES, SWITCHES FIXTURES AND TELEDATA OUTLIETS.
- E ALL SLEETINGAL MAYERIALS SHALL HE NEW EXCEPT INHERE SPECIFICALLY ALL SECTION AN ATENNAS SHALL BE ARE EXCEPT APPRICE AND A MATCH AS RESPONDED SHE BRUDE. AN ANTHANE SHALL BE (SETZED BY THE GOODWINTED LABORATORIS BIT. (A). DEFECTIVE COUNTRICT ANDONE SECURIORIS COMMON SHALL AND AND AND ATENDAD SHALL BE REPLACED ON REVAILED AN ANNABE METHAD THE APPROPRIA OF THE APPLICATION OF THE SOURCES WHERE APPLICABLE, ALL BOUPWINT SHALL BE IN ACCORDANCE WITH NEWS STANDARDS.
- 7 ALL WORK SHALL SE SUBJECT TO THE APPROVAL OF THE DANER OR GAMER'S
- 8 ALL WORK SHALL BE INSTALLED IN A NEAT AND WORKMANUKE MANNER.
- INSTALL A FIRE STOP OF ROCKWOOL FIBER OR SILICON FOAM SEALANT TO PROVIDE AN EFFECTIVE BARRIER AGAINST THE SPREAD OF FIRE AND SMOKE
 WHEN CONDUITS WHENAYS, AND OTHER ELECTRICAL BACKWAYS PASS. THROUGH PRIS NATSO PARTITIONS AND/OR SLASS.
- ID ALL CERTIFICATES OF APPROVAL SHALL BE IN TRIPLICATE DELIVERED 10 THE ENGINEER AND RECOME THE PROPERTY OF THE OWNER
- I CONTRACTOR SHALL VERIFY ALL EQUIPMENT REQUIREMENTS BEFORE INSTALLING CONDUIT OR CONDUCTORS FROM POWER SCURGE TO CQUIPMENT TERMINATION.
- 12. THE CONTRACTOR BHILL IS MAY SURE IN AREA OF PENETRATION PRIOR TO CORE DIRLING AND COORDINATE WITH EQUIPMENT IN DELING SPACE BELOW TO CHECK FOR ONSTRUCTIONS.
- 13. COMPUCTOR INSTALLATION, HOMERLASS TO THE PANEL BOARD MAY BE RUN.
- 14. PROVIDED ALL CONNECTIONS ARE IN ACCORDANCE WITH THE NATION ELECTRICAL CODE AND LOCAL ELECTRICAL CODE REQUIREMENTS, AND THE MAXAMENT AND THE CONTRACT OF THE WHILE AND THE CONTRACT SHALL BE INSTALLED IN ONE HACEWAY, ELIMINATE SPLICES WHEREVER POSSIBLE, AND WHERE MEDESSARY, SPLICE IN READLY ACCESSIBLE PALL JUNCTION OR OUTLET BOX
- IS MODERCATIONS TO EXISTING PANEL BOARDS THE ELECTRICAL CONTRACTOR SOURCE AT THE SET OF EACH PROPERTY THE ELECTRICAL CONTRACTOR SHALL PROVIDE NEW CRICKING THE SEARCHES AND SHEED SWITCHES HAS NOT SHEED SWITCHES AND SHEED SHALL SHEED SHE
- 16 INTERRUPTION OF ELECTRICAL POWER THE ELECTRICAL CONTRACTOR. SHALL COOKSIMATE ALL WORK HEIGHING INTERRUPTION OF ELECTRICAL POWER WITH THE BULLONG CHANGE AND SANLL OSTAN WRITTEN PERMISSION FROM THE BUILDING OWNER PRIOR TO SHUTTING DOWN POWER TO ANY SWITCHBOARD THE CONTRACTOR SHALL ALSO HIGH OWNERS TO ALL OTHER TRADES OF ALL DULED INTERREPTIONS OF POWER.
- F SITS VEST, PRIOR TO SUBMITTING HIS BIO, THE ELECTRICAL CONTRACTOR SHALL WISTTING STREAM PARILLARIZE HIRSELF WITH ALL EXECTING CONCRETIONS. THE ELECTRICAL CONTRACTION SHALL ROTHY THE AMONTHOS AND PREVENT EXCRETED IN ADMANDE OF ANY CONCRETIONS THAT DWAT THAT WOULD PREVENT. THE WORK HEREIN SPECIFIED OR SHOWN ON THE DRAWNGS FROM BEING PERFORMED. FAILURE TO SUPVEY THE SITE PRIOR TO BID AND START OF CONSTRUCTION WILL NOT RELIEVE THE CONTRACTOR OF THE RESPONSIBILIT FO WATELL DESIGN WITHIN THE CONTINUES OF THE EXISTING CONDITIONS

FLECTRICAL LEGEND

GENERAL NOTES

- HE CUMMANTEE THE ELECTRICAL CONTRACTION SHALL LEAVE THE ENTIRE ELECTRICAL SYSTEM ASTALLES LACOUR THIS DONTRACT IN PROPER ADDROXIC ORDER AND SHALL, WITHOUT CHARGE, REPLACE ANY WORK OR MATERIALS CHIE YEAR FROM THE DATE OF FINAL ACCEPTANCE. HENEFICIAL LISE SHALL NOT ONE THAN FROM THE ONE OF THIS ACCUPANCE, EXAMPLICALLY SEE SHALL MOVE ECONOMISTICAL OF HAIR ACCUPANCE OF THE ECONOMISTICATION SHALL OWNED THE USE YEAR GLUMANUTES PRINCIP, SET FOR THE PROPRIET OF ALL ELECTRICAL SYSTEMS AND GOODPHENT, AMENIANTIAL GOVERS, YET, MOTALLED BY MINE, AND ON ALL WORM INCCESSION, TO SHAULD BY MINE AND ON ALL WORM INCCESSION, TO SHAULD BY MINE OF THE COMMONION OF THE CAMMONIES RESIDED AND AND ALL WORM AND ALL PROJECT WALL BE MADE.
- THE CONTRICTOR BHALL FURNISH PERCONNEL TO ASSIST THE CANNER IN THE REVIEW, JANY ADJUSTMENTS, REMAIS OR REPLOCEMENTS FOUND INCCESSARY DURING REVIEW SHALL BE DONE BY THE CONTRACTOR, AT NO ADDITIONAL COST TO THE OWNER
- THE ELECTRICAL CONTRACTOR SHALL BE RESPONSIBLE FOR AND SHALL INCUR FINANCIAL RESPONSIBILITY FOR ANY DAMAGES CAUSED BY, OR RESULTING FROM DEFECTS IN HIS WORK.
- THE RESERVOIRSE CONTRACTOR WHILE MONITOR AT THE SITE, FOR THE DWINER. 1. THE BLECTHOLS CONTROLLED BINAL MAN, ATTHE STET, FOR THE OWING, MALE CONTROLLED BINAL STATE STEEL AND THE OWINGER. ADMINISTRATION OF THE OWINGER STATE STA
- 22 ALL CONDUCTORS SHALL SECONFIER CONFORWING TO THE LATEST BE UREMENTE OF THE NATIONAL ELECTRICAL CODE, STRANGED FOR NO. 8 AWG AND LARGER BOUD FOR NO 12 AND BYOLDER
- ALL MODING SHALL BE INSTALLED IN COMPART JENT WITH STEEL COMPART STOCK ALL WRING SHALL BE GETALED IN COARTY RAY WITH STEEL COMMISSION THITTINGS OR TYPE OF CARELY WHERE ALLOWED TO COOK, WHEN AN CONCOLUT IN EIGHALES MY ALL DOCKUT HAN WHINE SHALL BE CONCOLUTED IN ANDOR WALLE LIVELESS SPECIFICATLY NOTED OTHERWISE CHANNEL SKISTING WALLS WHERE RE LURED WHERE WIRING RUNS ARE EXPOSED ONE TO THE LADOR OF A NEW FINISHED CEILING, EMT SHALL BE USED, INSTALL ALL CONDUTE IN HUNG WHICH ARE PARKLES, AND PERPENDICULAR WITH BUILDING LINES.

ELECTRICAL LEGEND

POWER

- WP WEATHER PROOF (NEWA 3R
- GFI GROUND FAULT INTERRUPTER
- (I) WALL MOUNTED 26A DUPLEX RECEPTAGE 118" APPLICAN.
- WALTER GROWIPLES RECEPTACLE HE AFF UOSE WALL MTD. SPECIAL RECEPTACLE NEWS TYPE PER PLANS
- PLOOR MOUNTED TOA LACKURLEX RECEPTACLE 關
- Ø CEILING MOUNTED JUNCTION BOX
- WALL MOUNTED A METHON BOX DISCOMECT SWITCH - NON-FUSED
- PUSED DOCCHMECT SWITCH PUSE EL E PER PLANS. Ζh
- COMBINATION STANTENED CONNECT EWYOR.
- MOTOR REFER TO MECHANICAL PLANT FOR HORSEPOWER.
- INCREASE NO SETTINGUES.
- ENGLOSED GIRCUIT BREAKER

GENERAL

NOGATES PLAN NOTE.

A INDICATES REVISION, CLOUDED AREA CONTAINS THE REVISION

F ROCATES ROOM NUMBER

BRAND+ GROUT HOMENUN

ELECTRICAL LEGEND

ABBREVIATIONS

A AMP AMPERES GROUND
GGROUND FAULT INFERRUPTER
SOLATED GROUND FAULT INFERRUPTER
INCAND INCANDESCENT
KAIC KLOWP INTERRUPTING CURRE
CVA KLOWATTS
KKOWATTS
KKOWATTS ABOVE ALTERNATE CURRENT ABOVE FINISHED FLOO ARCHITECTURAL ARCHITECT

- ENCLOSED WOLDED CHIE SHETCH MECHANICAL MOUNTING HEIGHT CENTWETER MECH MECH DIRECT CURRENT DISCONNECT SWITC
- MLD DISCONNECT SWITCH MANULUCE ONLY SAME ELECTRICAL CONTRACTOR MALAMETER MIM MOUNTED
- EMERGENCY EQUIPMENT NTS NOT TO SCALE PH, Ø PASE EXIST EXISTING
- FIRE ALARM FIRE ALARM CONTROL PANEL RECEP MECEPTAGE
- FIRE ALARM ANNUNCIATOR PANEL TILEPLONE Partner
- FLA FULL LOAD AMPERES ON ESS OTHERWISE NOTED

EXHAUST FAN

ELECTRICAL

- LIGHTING NOTE: REFER TO LIGHTING FIXTURE SCHEDULE FOR FIXTURE TYPES. CANTAL LETTER ADJACENT TO FIXTURE INDICATES TYPE.
- NE. INDICATES NONT CONTING UNIONTO-EDITITURE.
- QUADED CIDCLE INDICATES EXTURE ON EMERGENCY CIRCUIT.
- WHILE MOUNTED PORTURE
- OCH POLE MOUNTED FIXTURE SINGLE HEAD
- ➡ EMERGENCY BATTERY PACK LIGHT FIXTURE CELHOWALL MOUNTED EXIT SIGN-SINGLE FACE PROVIDE
- DIRECTIONAL ARROWS PER PLANS.
- CELHIOWALL WOUNTED EXIT SIGH-DOUBLE FACE, PROVIDE DIRECTIONAL ARROAD PER FLANS.
- 20A IP 120V TOGGLE TYPE LIGHT SWITCH 25K, 1F, 120V KEY OPERATED LIGHT EWITCH
- See CONVOCTAGE CONTRACTOR
- Su TOGGLE TYPE MOTOR STARTER WITH THERMAL EVERLOAD
- WALL MOUNTED COOLPANCY SCHOOL WATTETOPPER DW-100 OR APPROVED C. UAL.
- DURL RELAY WILL MOUNTED DOCUPANCH SENSOR WATTETOPPER DWGCC DE APPROACO E UNA
- AU 3 CINCAPPARAD COL
- CELING HOUNTED OCCUPANCY SENSOR VANTETOPHER DT-355 OR APPROVED E UNI.
- CEILING MOUNTED DAYLIGHT SENSOR
- WITH PROTECTIVE CAGE WATTSTOPPER HES/OB-LS WITH PROTECTIVE CAGE OR APPROVED E UAL 0

LIGHTING FIXTURE SCHEDULE

TYPE	SYMBOL	DESCRIPTION	MANUFACTURER AND CATALOG NUMBER		LAMP D	ATA	VOLTS	NOTES
A TPE	SIMBOL	DESCRIPTION			NO. WATTS TYPE		VOLIS	District.
c	.0	NOROUNE LED PLOCE LIGHT	SOLERA LIGHTING SMSL-E-TP-XX		10	LED	24	MOTE 13.4
õ	40	VERTICALLY MOUNTED LED STRIP.	OILI ALSISTI HALEDO SKI 1000 BW WET SE		SWEET	(60	277	NOTE 1, 2

- GENERAL NOTES

 A E I LA LIGHTING FOXTURE MANUFACTURERS WILL BE COMPOSITED.

FINAL SELECTION OF LIGHT FIXTURE ARE TO BE PROVIDED BY THE ARCHTECT THESE FIXTURES AND SUGGESTED LIGHT FIXTURE FOR THE

- APPLICATION INTERIORD
 FIXTURE AND TRANSFORMER SHALL BE SUITABLE FOR GUTDOOR USE.
- COORDINATE FINISH WITH ARCHITECT

 LEG 277V RENOTE MOUNTED TRANSPORMER SHALL BE OUTDOOR NATED

NATIONAL ELECTRICAL CODE

DGS

TMENT OF GENERAL SERVICES)



BAILEY & ASSOCIATES

PRIOGEOPHICA AVENUE, NAV AASHINGTON DC 20012 F (PID1565-7285) F (2015/65-7207 MEY

GES

www.THEGES cars





SUBMISSION SCHEDULE

PERMIT SET 07-17-2015

DATE

DATE

REVISION SCHEDULE

NO DESCRIPTION

PROJECT:

DYRS COURTYARD RENOVATION

1000 MOUNT OLIVET ROAD, NE WASHINGTON, DC 20002


SHEET TITLE:

ELECTRICAL COVER SHEET

PROJECT NO: 1310 JULY 17-2015

SHEET NO

E001

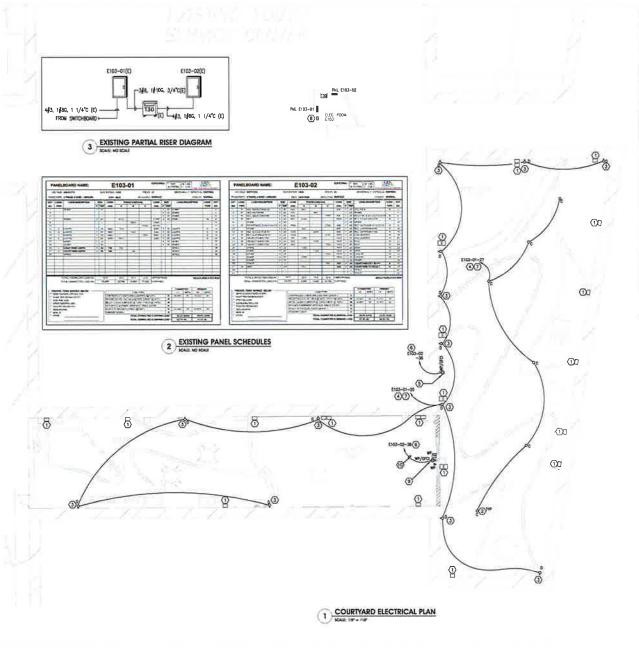

GENERAL NOTES

SPECIFIC NOTES

REFER TO EDOT FOR GENERAL NOTES, SYMBOL LEGEND AND LIST OF ABBREVATIONS.

DGS



ABOUTICE

ABOUTICE

LANCE BAILEY & ASSOCIATES

MISS GEORGE METILE MS

BY ASSOCIATES

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MEV

EXISTING EXTERIOR SECURITY LIGHT FIXTURES TO REMAIN, CONTRACTOR SHALL CLEM AND RE-LAMP ALL FORTURES AND SHALL MAKE COSTINAL THAT ALL THE LIGHT FIXTURES ARE IN WORKING KORLER

A. NEW TIME CLOCK, SITE NOTE 4 ABOVE.

CPCI RECEPTACLE, DATA AND TV OUTLET FOR OUTDOOR TV SCREEN. COOKDINATE FRAIL LOCATION WITH ARCHITECT PRIOR TO ROUGH-IN AND INSTALLARDIN.

10. 2∯10, 1∯10G N 3/4°C

CONSULTING STRUCTURAL ENGINEER



SUSWEDINENANE, MY BUTCO WARRANTON OF ZOTO (1) ZOTAS-FAS (2) ZOTAS-FAS

CML ENGINEET



TO STREET, NO BUTTLE PARK WASHINGTON DO DOOD TO COLD TRANSPORT OF DOOR TO SEED



SUBMISSION SCHEDULE

1 PERMIT SET

DATE 07-17-2015

REVISION SCHEDULE NO DESCRIPTION

DATE

PROJECT:

DYRS COURTYARD RENOVATION

1000 MOUNT OLIVET ROAD, NE

SHEET TITLE:

COURTYARD ELECTRICAL PLAN

PROJECT NO: 1310 JULY 17, 2015 SCALE: SHEET NO:

E101

STRUCTURAL NOTES DESKEN LØADS LIVE LOADS 2 5NOV LOADS SROUND SNOW LOAD SNOW EXPOSURE FACTOR THERMAL FACTOR SNOW IMPORT WICE FACTOR FLAT ROOF SNOW LOAD

3. LATERAL LOADS

WNO JUICE THE BOOKS

LLTIMATE DECKIN WIND SPEED NOMINAL DESKIN WIND SPEED WAD LEAVE HOSE FACTOR REK CATESORY WIND EXPOSITE CATESORY WIND EXPOSITE CATESORY WIND EXPOSITE CATESORY INTERNAL PRESSURE COETTOENT
MIN & MAN DEBKEN IN TO PRESSURE FOR
THE TAN WIND FORCE RESENTING SYSTEM
MIN & MAN WIND FRESSURE FOR COMPONENTS &
CLADING MATERIALS 19 PSF & 2 PSF 26 70 4 12 70 LATERAL RESISTING SYSTEM IS INCLUDING THE EXISTING SULDING

SEISMIC LCADS PER IBC 2012

SEBYC PROTEINAS FACTOR

SESYCE PROTEINAS FACTOR

SECTION RESERVES ACCELERATION

FACTOR SECTION RESERVES ACCELERATION

HAPPED SPECTRAL RESERVES COPPRESENTS

BASIC DESPRICACION CATEGORY

BASIC DESPRICACION CATEGORY

RESPONSE YOUTHAND TO PACTORS

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SOIL BEARING

1 ASSUMED 1500 PSF, SHALL BE VERIFED IN THE RELD

CONCRETE

- ALL CONCRETE CONFERCTION FEALL CONFORM TO THE ACI COST, ME COT
- Z8. JAY CONCRETE STRENGTH 5-ALL 86 AC POLLOWS STONS CONCRETE COURSE AGGREGATE SHALL CONFORM TO ACTIVISES FOR LACOD PB
- 3. ALL CONCRETE EMPOSES FOR THE MEATHER SHALL BE ARE ENTRANSO MITHER! IN

FOUNDATION

- ALL FOOTING SHALL BE PROJECT AT LEAST INDINING UNDISTURBED NATURIAL SOIL OR THE COMPACTED CONTROLLED FILL HAVING A BEARING VALUE AT LEAST EQUAL TO THAT SPECIFED IABOVE
- BOTTOM OF ALL DISTRICT FOOT NOR SHALL BE AT JOHN \$1 ST \$50.000 FINEHES SINGLE
- STOP SELVA, JAWYO HOLD TO POOP IS TO KOP DAMED TO MAJAHO CONTROLLAR
- ELEVATION OF BOTTOMS FOOTING HAVE BEEN ESTABLISHED FROM AN ALABLE INFORMATION AND SHALL BE CONSTRUED. AS WAYING ANY OF THE HINMUM REQUIREMENTS STATED
- $A_{\rm c}$ in a control of control of $A_{\rm c}$ and to be control of the control of the property of the proper
- 8 ALL DRITURNS CARTH LACOK POOTING THAIL SO RETLACED WITH SENSIFIED POLOCOD TH
- ALL BEARING STRATA SHALL BE AGEO, ATELY GRANES MINERS NO AGAINS SOCIATION SOCIATION STRATES NAMED
- NO EXCAVATION SHALL BE CLOSER THAN AT A SLOPE OF T [% HORZONIAL TO DNE VERTICAL) TO A FOOTING
- P. DO NOT MADE CONCRETE DANS PRODEN SON.
- 10 THE DIVINER SHALL RETAIN THE SERVICES OF A SOIL CONSULTANT APPROVICE BY THE ARCHITECT TO CHECK AND VERIEW THE REQUIRED SOIL BEARING PRESSURE OF EACH FOOTING

- ALL REINFORCING STEEL SHALL SONFORM TO ASTM: ABIS GRADE 60
- 2 WHILE WRITHSON OF HOME SALEW 1
- OF STANDARD PRACTICE FOR DETAILING REINFORCED CONCRETS STRUCT, RES ACIBIEL ATEST ACCITION
- 4 ALL CONTINUOUS REINFORCINS SHALL BE SPUCED WITH TYPE'B "SPUCE STAGGERED UNLESS NOTED OTHERWISE
- 5. IN THE SHARDS SLABS, ALL RENPORCES SHARD LOCKTED IN THE SEPTEMENT SHARD.
- 6 SLBMT FOR APPROVAL SHOP DRAWING SHOWING ALL REINFORCING STEEL AND LOCATIONS OF COLD JOINTS FOR EXTENT OF THE CONCRETE POUR

- 2 FORHED CONCRETE ENROSED TO BARTH / TIFOR BARS LARSEE THAN HE LIVE FOR HE AND SHALLOR BARS.
- 3 FEMAL CILLING ACT TOP REMOVED IN THE SARAGE SLASH VZ
- 3 NYRICH WOLF OF WALK TID TORON FACES DIVISION OF WARRENING
- 6. SUMED DIVERSIADI LALEZES CTHEMPSE NOTED, TO HAVE REMINDICEMENT AT HOLDERY

MASONRY

- SOUR CONCRETE HISCORY SHALL BY SENCE WIN NOCODE WICH WITH ABITH CHEE WICH HAY BY THE SOUR LOLESS CONSINER NOTES.
- 2 HOLLOW CONCRETE MASONRY UNITS SHALL BE GRADE Y CONFORMING TO ASTMIC-90.
- 3 CONDECTE HAICHEY UNITS SHALL SEWEN JOHT CONDECTE
- A. ALL HOSTIAN BY ALL SET THRE'S CONTORTING TO ABOUT OUR ABOUT DRIVES CONGRESSION USE THE THRE'S SELECTION.
- PROVIDE A MINIMUM OF 3 COURSES OF SOLID BRISK OR ONE COURSE YOUR SOUID BLOCK UNDER WALL SEARINGS ENDS OF ALL JOISTS AND SUASS THE FULL WISTH OF THE WALL LINLESS NOTES.
- PROVIDE 100% SOLID MASCHEY DOWN TO FOOTINGS BELOW GRADE AND UNDER ALL BEAMS AND UNTELS BEARNS! ON MASCHEY, UNLESS NOTED

- NESHARS WALLS FROMOS SOLD SECULOR CON SOLD CONDICTS SLOCAL DITORING BISCHOOL WALL SPENINGS THE TILL WALL THOMHOS DOWN TO THE TUDGE DUESD NOTES.
- 4. ALL PERTICING OF BEARING WALLS -AVING A HORLEGISTAL CROSS SECTION OF 4 SQ. FT, OR LESS SHALL BE OF SOUR MASONRY SOAN TO POOTINGS
- 9 PROVIDE HORIZON TAL MASC VRY REINFORDING AT 18" DIC IN ALL MASC VRY WALLS UI LESS NOTED
- CO PROVIDE VERTICAL CONTROL JOINTS IN ALL MASCHRY WALLS \$ 50-07 O.C., J.N.ESS NOTED
- TI ALL MORTAR JOINTS IN MASONRY WALLS (HORIZON" ALL & VERTICAL," SHALL BE FILLED ICON WITH MORTAR
- 12 GROUT SHALL BE SAND AND GEMENT, & BAGS OF CEMENT PER CUSIC YARD

B PROVIDE MASCARY TIES BETWEEN IF SRICK VENEER WALL AND THE STEEL STUD WALL SPACE TIES & IGN VERTICAL AND 24 HORIZON AL

- SHALL BEIN ACCORDANCE WITH THE LATEST ASCISPECS. FOR DESIGN FASRICATION AND PRECTION OF TESTING AND INSPECTION.
- 2 ALL STRUCTURAL STEEL SHALL CONFORM TO ASTM ASS2 SRADE SO STRUCTURAL TURING SHALL CONFORM TO ASTM ASCO GRADE BIAND STEEL FIRE COLUMNS DHALL CONFORM TO ASTM ASCI.
- ALL WELDING SHALL BE DONG IN ACCORDANCE WITH THE AMERICAN WELDING SOCIETY STANDARD CODE FOR ACCIAND SHALL BE PERFORMED BY CERTIFIED WILLDING WILDING TO THE AMERICAN LATEST CODE AND SHALL BE PERFORMED BY CERTIFIED WILLDING CONSTRUCTION.
- 4 SHOP AND FIELD CONNECTIONS SHALL BE WELDED OR THOSE WITH DATASES HIGH STRONGTH BOUTS WE ACCORDANCE WITH ANTW-4325 OR A490
- S. TSTANCH STEDIN PRODUCTION NEWS IN MISTER THAN DE TO PREPAT LARGE ARTERNAL
- 5 ACHOLOS SHALL SE LOCKYDD IN FLANZES OF SEAMS LINUSSE APPROVED BY THE ENGINEER.

- E. PROVIDE PHILL HORSEN AND USE ALONG SIGH OF CONCRESS SUMMERS REQUIRED.
- C. AL SITES TO BE PROPAGENT." INSCIRCT TO MEATHER OR SOLDHAL, BE FOR DECKNOTED
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- 12 HALDERY CONNECTION SHALD BE DESIGNED FOR THE HAWHAN SHE HE GATACITY.
- IS SEE SETS OF AND ASSET AND AS
- 14 ALL STEEL BRECTION SHALL BE COMPLETED, INCLUDING ALL BRACING BEFORE OTHER TRADES START THER WORK.

- PROVIDE UNLESS NOTED OTHERWISE FRE-CAST LISHTWEISHT CONCRETE UNTELLS FOR ALL OPENINGS AND RECEEDES IN CONCRETE HASONRY UNIT WALLS
- A DNEW A PLANTE FOR EACH FOR WALL THOUSER.
- B ONE SIX SILINTEL FOR EACH SIDE WALL THICKNESS

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- B __YKBYZKYYPQKQPQNAGB#F10BFF
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- 2 LABORATORY TESTS ARE TO BE PERFORMED ON THE FILL HATTERIAL PRIOR TO PLACING TO DETERMINE FITHE MATERIAL IS SUITABLE TO ACHIEVE SSY COMPACTION.
- 3. PROVIDE HELD TESTING DURNO SACHALL TO DETERMINE THAT THE HULLS CONTACTED TO SON

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- 2 WHIRE SHOULD IN KECURED ON SOTH HOSIS OF IN ALLS SHOULD SOTH HOSIS SMULTHARDURY
- 3 WHERE BACKFILL IS REQUIRED ON ONE SIDE OF WALL AND THE FRAMED FLOOR IS NOT IN PLACE SHORE THE WALL REPORE BACKFILL IS FLACED

- ARE TO BE PROVIDED DURNG CONSTRUCTION. AND AFTER CONSTRUCTION LEFT AS PERMANENT FUMPS AS REQUED BY RELD CONDITIONS.
- THE SIZE AND LOCATION OF THE SUMP FLMFS ARE TO BE DETERMINED IN THE RELD BASED ON THE AMOUNT OF MILTER ENCOUNTERED DURING CONSTRUCTION

PRE-EXISTING CONDITIONS

IN GENERAL CONTRACTOR SHALL FIELD MEASURE LOS ATION OF ALL EXISTING CONDITIONS, AND NOTIFY ARCHITECT OF ANY DISCREP ANGLES

SHEATHING, SHORING AND BRACING

SHALL BE DESIGNED SIGNED AND SEALED BY A PROFESSIONAL ENGINEER REGISTERED IN THE PROJECT URSDICTION AND ISLEMITED TO THE ENGINEER OF RECORD FOR AFRECA ALL SHOP DRAWINGS AND CALCULATION HUST SHAUN INSTALLATION DETAILS AND SEQUENCE OF OFFERSTORE.

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- 3. REPRODUCTION OF STRUCTURES DRIVENINGS FOR USE 45 SHOP DRIVINGS SHIPL, NOT BE FIRMHTED


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- THE CONTRACTOR SHALL VERBY ALL DIFENSIONS PRIOR TO STARTING CONSTRUCTION AND ANY DISCREPANCY SHALL BE BROUGHT FOR THE ATTENTION OF THE ARCHITECT
- 6 NS PARTICE THE BUILDING SHALL BE USED AS A STAGING AREA RESULTING NIA LOAD (LADER THE LIMITED
- 3. No FORMAGES, MIG GROWING DESIGN BETHE RESPONSIBLELY OF THE CONTRACTOR

ABBREVIATIONS





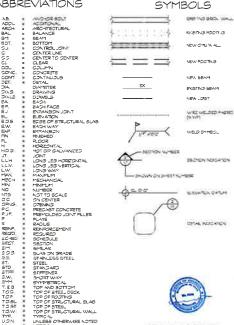

OS (DEPARTMENT OF GENERAL SERVICES)

MEV CONSULTING STRUCTURAL ENGINEER
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DATE SUBMISSION SCHEDULE NO DESCRIPTION REVISION SCHEDULE DATE NO DESCRIPTION PROJECT:

DYRS COURTYARD #1& #2 RENOVATION


1000 MOUNT OLIVET ROAD, NE WASHINGTON, DC 20002

SHEET TITLE:

SHEET NO:

STRUCTURAL NOTES

PROJECT NO: 1310 JULY 23, 2015 SCAUE:

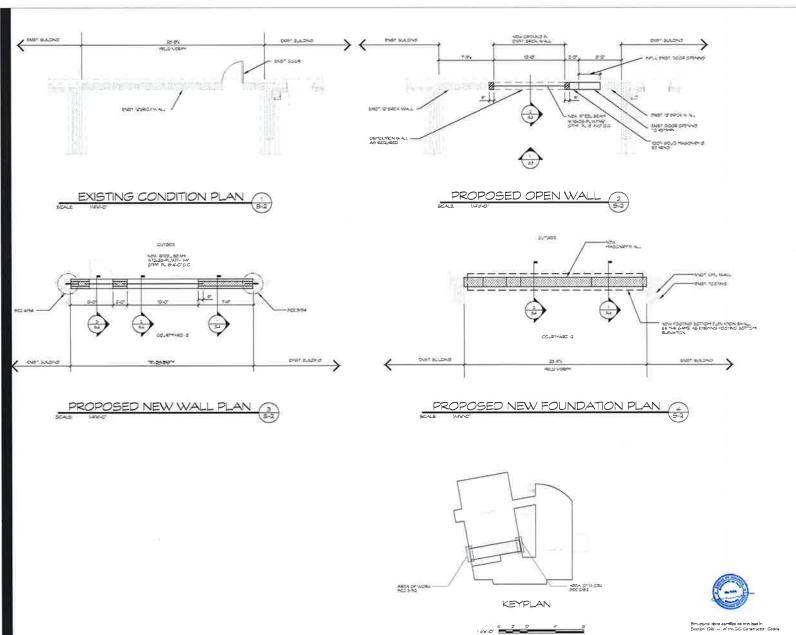

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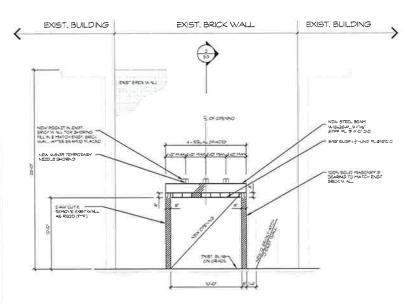
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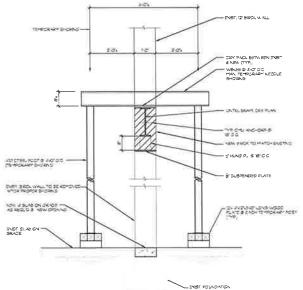
1000 MOUNT OLIVET ROAD, NE WASHINGTON, DC 20002

SHEET TITLE:

PROPOSED FOUNDATION & WALL PLAN


PROJECT NO: 1310 JULY 23, 2015 SCALE: SHEET NO:





TYPICAL SECTION (2)
SCALE 3/191-07 (5-3)



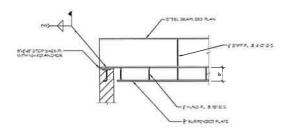

TYPICAL BEAM BEARING DETAIL (5)







DGS COS DEPARTMENT OF GENERAL SURVICES. CO. (1997) 100 CO. (1997) 101 CO. (1997)

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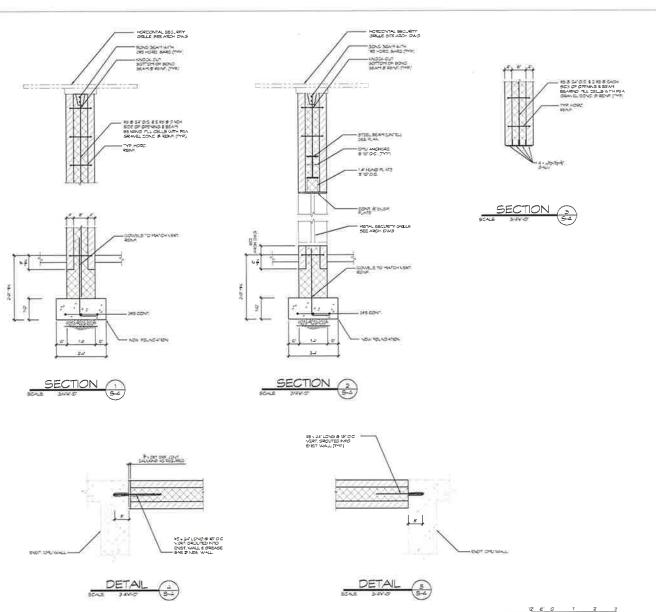
DYRS COURTYARD #1& #2 RENOVATION

1000 MOUNT OLIVET ROAD, NE WASHINGTON, DC 20002

SHEET TITLE:

SECTIONS & DETAILS

PROJECT NO: 1310
JULY 23, 2015
SCALE
SHEET NO:



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SUBMISSION SCHEDULE DATE
NO DESCRIPTION

REVISION SCHEDULE DATE
NO DESCRIPTION

PROJECT:

DYRS COURTYARD #1& #2 RENOVATION

1000 MOUNT OLIVET ROAD, NE WASHINGTON, DC 20002

SHEET TITLE:

SECTIONS & DETAILS

PROJECT NO: 1310
JULY 23, 2015
SCALE:
SHEET NO:



Attachment B

Form of Offer Letter and Bid Form

Mr. Christopher Weaver [DATE]
Page 1

Attachment B

[Contractor's Letterhead]

[Insert Date]

District of Columbia Department of General Services 2000 - 14th Street, NW, 8th Floor Washington, DC 20009

Attn:

Mr. Christopher Weaver

Acting Director/Chief Contracting Officer

Reference:

Invitation for Bids (IFB)

DCAM-16-CS-0040 - Renovation of DYRS Gymnasium and Courtyard

Dear Mr. Weaver:

On behalf of [INSERT NAME OF BIDDER] (the "Bidder"), I am pleased to submit this bid in response to the Department of General Services' (the "Department" or "DGS") Invitation for Bids (the "IFB") for the renovation of the DYRS gymnasium and courtyard at 1000 Mount Olivet Road, NE, Washington, DC. The Bidder has reviewed the IFB and the attachments thereto, any addenda thereto (collectively, the "Bid Documents") and has conducted such due diligence and analysis as the Bidder, in its sole judgment, has deemed necessary in order to submit its Bid in response to the IFB. The Bidder's bid and the Lump Sum Fixed Price are based on the Bid Documents as issued and assume no material alteration of the terms of the Bid Documents. (Collectively, the Bid and the Lump Sum Fixed Price are referred to as the "Bidder's Bid".)

The Bidder's Bid is as follows:

Bid

CLIN	DESCRIPTION	LUMP SUM FIXED PRICE
0001	Renovation of DRYS Gymnasium and Courtyard At 1000 Mount Olivet Road, NE	\$
	Total Lump Sum Fixed Price	\$

LUMP SUM FIXED PRICE IN WORDS:

Mr. Christopher Weaver [DATE]
Page 2

The Bidder, for CLIN 0001, must submit for each of the components of work (Divisions) listed on the Price Breakdown Form (Exhibit 1), the price of each division component. The sum of all the prices for each division component must equal the Lump Sum Fixed Price for CLIN 0001. In the event of discrepancies between or among the Lump Sum Fixed Price and the Price Breakdown of each division component, the Lump Sum Fixed Price shall control.

The Bidder acknowledges and understands that the Lump Sum Fixed Price is a firm, fixed price and intended to be Bidder's sole compensation for the services required under the contract and should include sufficient funding for all of the Bidder's costs associated with the work, including, but not limited to, labor, tools and equipment, materials and supplies, and overhead, insurance and profit. Failure to submit the complete Price Breakdown for CLIN 0001 shall not to any extent qualify the Bidder's commitment to complete the entire project at the above stated Lump Sum Fixed Price. The District may use the Price Breakdown as a guide during contract administration

The Bidder's Bid is based on and subject to the following conditions:

- 1. The Bidder agrees to hold its proposal open for a period of at least one hundred twenty (120) days after the IFB closing date.
- 2. Assuming the Bidder is selected by the Department, the Bidder agrees to enter into a contract with the Department on the terms and conditions described in the bid documents within ten (10) days of the notice of the award.
- 3. Both the Bidder and the undersigned represent and warrant that the undersigned has the full legal authority to submit this proposal form and bind the Bidder to the terms of the Bidder's proposal. The Bidder further represents and warrants that no further action or approval must be obtained by the Bidder in order to authorize the terms of the Bidder's proposal.
- 4. The Bidder and its principal team members hereby represent and warrant that they have not: (i) colluded with any other group or person that is submitting a proposal in response to the IFB in order to fix or set prices; (ii) acted in such a manner so as to discourage any other group or person from submitting a proposal in response to the IFB; or (iii) otherwise engaged in conduct that would violate applicable anti-trust law.
- 5. The Bidder hereby certifies that neither it nor any of its team members have entered into any agreement (written or oral) that would prohibit any Contractor, subcontractor or subconsultant that is certified by the District of Columbia Office of Department of Small and Local Business Enterprises as a Local, Small, Resident Owned or Disadvantaged Business Enterprise (collectively, "LSDBE Certified Companies") from participating in the work if another company is awarded the contract.

THE O	FFERORJ.		
Sincere	ely,		
By: Name: Its: Date:			

6. This Offer Letter Form and the Bidder's Bid are being submitted on behalf of [INSERT FULL LEGAL NAME, TYPE OF ORGANIZATION, AND STATE OF FORMATION FOR

Exhibit 1
PRICE BREAKDOWN FORM

CSI DIVISION NO.	DESCRIPTION	PRICE OF EACH DIVISION COMPONENT
Div. 01	General Requirements	
Div. 02	Existing Conditions (incl. abatement/demo. of exist. structure)	
Div. 03	Concrete	
Div. 04	Masonry	
Div. 05	Metals	
Div. 06	Woods and Plastics	
Div. 07	Thermal and Moisture Protection	
Div. 08	Openings	
Div. 09	Finishes	
Div. 10	Specialties	
Div. 11	Equipment	
Div. 12	Furnishings	
Div. 13	Special Construction	
Div. 14	Conveying Systems	
Div. 21	Fire Suppressions	
Div. 22	Plumbing	
Div. 23	Heating, Ventilation and Air Conditioning	
Div. 26	Electrical	
Div. 27	Communications	
Div. 28	Electronic Safety and Security	
Div. 32	Exterior Improvements	
Div. 33	Utilities	
	LUMP SUM FIXED PRICE	\$

• DIVISION means a discrete component of the work for which a separate price is requested. The sum of all components in the "Price Breakdown Form" must equal the Lump Sum Fixed Price.

Attachment C

Disclosure Statement

Disclosure Statement

The Offeror and each of its principal team members, if any, must submit a statement that discloses any past or present business, familiar or personal relationship with any of the following individuals:

D.C. Department of General Services

	Latrena Owens	Chief of Staff
	Camille Sabbakhan	General Counsel
	Carlos Sandoval	Supervisory Attorney Advisor
	Spencer Davis Yinka Alao	Deputy Director, Facilities Management
	YINKa Alao	Associate Director, Contracts and Procurement
A.		
	Please identify any past or p provided below. Use extra she	present business, familiar, or personal relationship in the space ets as necessary.
Β,	71	
		ent business, familiar, or personal relationship in the space below. Use
	extra sheets if necessary.	
	9	
	inquiry, the above represents familiar, or personal relations acknowledges and understand	best of my knowledge and belief and after making reasonable a full and accurate disclosure of any past or present business, ship with any of the individuals listed above. The undersigned s that this Disclosure Statement is being submitted to the False disclose a material relationship(s) may constitute sufficient grounds
	OFFEROR:	
	By:	
	Name:	
	Title:	
	Date:	

Attachment D

Tax Affidavit

GOVERNMENT OF THE DISTRICT OF COLUMBIA

Office of the Chief Financial Officer Office of Tax and Revenue



TAX CERTIFICATION AFFIDAVIT

THIS AFFIDAVIT IS TO BE COMPLETED OF THE DISTRICT OF COLUMBIA.	ONLY BY THOSE WHO ARE REGISTERED TO CONDUCT BUSINESS IN
Date	
Authorized Agent Name of Organization/Entity Business Address (include zip code) Business Phone Number	
Authorized Agent Principal Officer Name and Title Square and Lot Information Federal Identification Number Contract Number Unemployment Insurance Account No.	
release my tax information to an authorize seeking to enter into a contractual relation whether or not I am in compliance with the determining my eligibility to enter into a cauthorize that this consent be valid for one	
• •	th the applicable tax filing and payment requirements of the District of s hereby authorized to verify the above information with the appropriate
Signature of Authorizing Agent	Title
The penalty for making false statement is a or both, as prescribed by D.C. Official Code	a fine not to exceed \$5,000.00, imprisonment for not more than 180 days,

Attachment E

Subcontracting Plan Form



SBE SUBCONTRACTING PLAN

INSTRUCTIONS: All construction & non-construction contracts for government-assisted projects (agency contracts & private project with District subsidy) over \$250,000, shall require at least 35% of the amount of the contract (total amount of agency contract or total private project development costs) be subcontracted to Small Business Enterprises (SBE), if insufficient qualified SBEs to Certified Business Enterprises (CBE). The SBE Subcontracting Plan must list all SBE and CBE subcontracts at every tier. Once the SBE Subcontracting Plan is submitted for agency contracts, options & extensions, it can only be amended with DSLBD's consent. SUBMISSION OF SBE SUBCONTRACTING PLAN:

- ▲For agency solicitations submit to agency with bid/proposal.
- For agency options & extensions submit to agency before option or extension exercised.
- For **private projects** submit to DSLBD, agency project manager and District of Columbia Auditor, with each quarterly report. As private projects may not have awarded all contracts at the time the District subsidy is granted, the SBE Subcontracting Plan may be submitted simultaneously with each quarterly report and list all SBE/CBE subcontracts executed by the time of submission.

CREDIT: For each subcontract listed on the SBE Subcontracting Plan, credit will only be given for the portion of the subcontract performed, at every tier, by a SBE/CBE using its own organization and resources. COPIES OF EACH FULLY EXECUTED SUBCONTRACT WITH SBEs and CBEs (AT <u>EVERY TIER</u>) MUST BE PROVIDED TO RECEIVE CREDIT.

EXEMPTION: If the **Beneficiary (Prime Contractor or Developer)** is a CBE and will perform the ENTIRE **government-assisted project** with its *own organization and resources* and will NOT subcontract any portion of the services and goods, then the CBE is not required to subcontract 35% to SBEs.

BENEFICIARY (which applies	Prime Contractor or Developer) INFORMATION:
Company: Contact # Email address:	_
Street Address:	
✓all that applies, Company is: □ a SBE □ a CBE □ CBE Certification Number: □ WILL perform the ENTIRE agency contract or private pro □ WILL subcontract a portion of the agency contract or pri Company's point of contact for agency contract or private project:	oject with its own organization and resources
Point of Contact: Title:	
Contact # Email address: _	
Street Address:	
COVEDNMENT ASSISTED DDG IECT /	C. A. A. Dalinas Ballant INCORMATION.
GOVERNMENT-ASSISTED PROJECT (✓ which applies ☐ /	PRIVATE PROJECT
Solicitation NumberSolicitation Due Date:Agency :Total Dollar Amount of Contract: \$	District Subsidy: Agency Providing Subsidy: Amount of District Subsidy: Date District Subsidy Provided:
*Design-Build must include total contract amount for both design and build phase of project.	Project Name:
	Project Address:
35% of Total Dollar Amount of Contract: \$ Total Amount of All SBE/CBE subcontracts: \$	Total Development Project Budget: \$
(include every lower tier)	35% of Total Development Project Budget: \$
	Total Amount of All SBE/CBE subcontracts: \$



SBE/ CBE SUBCONTRACTORS (FOR EACH TIER):

submitted for preconstru	uction services; however, a ful-	I SBE Subcontracting	ts, the SBE Subcontracting Plan is not required to be g Plan (35% of the contract amount including total design steed maximum price or contract authorizing construction.)	
SBE/ CBE Company	Address/Telephone No./ Email	Subcontractor Tier (1 st , 2 nd , 3 rd , etc.)	Description of Subcontract scope of work to be PERFORMED WITH SBE/CBEs OWN ORGANIZATION & RESOURCES	
		Select Tier		
Period of subcontract:	_		SBE/ CBE Point of Contact	
Price to be paid to the SBE	C/CBE Subcontractor: \$		Name:	
✓all that applies, Subcontro	☐ CBE Certification #:	14-	Title:	
organization and res SBE/CBE will subco	m the ENTIRE subcontract with cources ntract a portion of the subcontr SBE/ CBE SUBCONTRACTS)		Telephone Number: Email Address:	
submitted for preconstru	uction services; however, a ful- uired be to submitted before e Address/Telephone No./	SBE Subcontracting ntering into a guarant Subcontractor Tier	ts, the SBE Subcontracting Plan is not required to be g Plan (35% of the contract amount including total design teed maximum price or contract authorizing construction.) Description of Subcontract scope of work to be PERFORMED	
	Email	(1 st , 2 nd , 3 rd , etc.) Select Tier	WITH SBE/CBEs OWN ORGANIZATION & RESOURCES	
-	M			
Period of subcontract:	_		SBE/ CBE Point of Contact	
Price to be paid to the SBE	/CBE Subcontractor: \$		Name:	
✓all that applies, Subcontra a SBE □ a CBE SBE/CBE will perfore		its own	Title: Telephone Number:	
organization and resources SBE/CBE will subcontract a portion of the subcontract (MUST LIST EACH LOWER TIER SBE/ CBE SUBCONTRACTS)			Email Address:	
(Name) (Title) Of(Prime	swear o	r affirm the above	is true and accurate	
Signature)	(Date)			

Complete additional copies as needed.



☐ AGENCY CONTRACTING OFFICER'S USE ONLY OR ☐ AGENCY PROJECT MANAGER'S USE ONLY (✓ which applies. Only one option should be selected.)

AGENCY CONTRACT AWARD	PRIVATE PROJECT SUBSIDY AWARD			
Agency: Prime Contractor: Contract Number: Date SBE Subcontracting Plan Accepted: Date agency contract signed:	Agency Providing Subsidy: District Subsidy: Developer: Amount of District Subsidy: Date District Subsidy Provided/ contract signed:			
Anticipated Start Date of Contract: Anticipated End Date of Contract:	Anticipated Start Date of Project: Anticipated End Date of Project:			
Total Dollar Amount of Contract: \$	Project Name: Project Address:			
*Design-Build must include total contract amount for both design and build phase of project.	Total Development Project Budget: \$(include pre-construction and construction costs)			
35% of Total Contract Amount: \$	35% of Total Development Project Budget: \$			
Total Amount of All SBE/CBE subcontracts: \$ (include every tier)	Total Amount of All SBE/CBE subcontracts: \$ (include every lower tier)			
(✓ if applies) □ Base Period Contract Option/Extension Period: □ Multi-year Contract □ First year (period) of Contract: □ Current year (period) of Contract: □ Design-BuildDate of Guaranteed Contract: □ Check if prime contractor is a CBE and will perform the ENTIRE government-assisted project (agency contract) with its own organization and resources and NOT subcontract any portion of services or goods.	Check if developer is a CBE and will perform the ENTIRE government-assisted project (private project) with its own organization and resources and NOT subcontract any portion of services or goods.			
☐ AGENCY CONTRACTING OFFICER'S AFFIRMATION OR ☐ AGENCY PROJECT MANAGER'S AFFIRMATION (✓ which applies)				
The Below Agency Contracting Officer or Agency Project Manag	er Affirms the following (v to affirm):			
☐ If the Beneficiary is a CBE, DSLBD was contacted to confirm	Beneficiary's CBE certification;			
☐ The fully executed Contract (Base or Option or Extension or Multi-Year) or subsidy document, between the Beneficiary and Agency, was emailed to DSLBD @ Compliance.Enforcement@dc.gov within five (5) days of signing;				
FOR AGENCY CONTRACT the SBE Subcontracting Plan, submitted by Beneficiary, was emailed to DSLBD @ Compliance.Enforcement@dc.gov within five (5) days of signing the contract between the Beneficiary and Agency.				
Name of Agency Contracting Officer or Agency Project Manager				
Title of Agency Contracting Officer or Agency Project Manager				
Signature Date				

Attachment F

2015 Living Wage Act Notice

"THE LIVING WAGE ACT OF 2006"

Title I, D.C. Law No. 16-118, (D.C. Official Code §§ 2-220.01-.11)

Recipients of new contracts or government assistance shall pay affiliated employees and subcontractors who perform services under the contracts no less than the current living wage.

Effective January 1, 2015, the living wage rate is \$13.80.

The requirement to pay a living wage applies to:

- All recipients of contracts in the amount of \$100,000 or more; and, all subcontractors of these recipients receiving \$15,000 or more from the funds received by the recipient from the District of Columbia, and,
- All recipients of government assistance in the amount of \$100,000 or more; and, all subcontractors of these recipients of government assistance receiving \$50,000 or more in funds from government assistance received from the District of Columbia.

"Contract" means a written agreement between a recipient and the District government.

"Government assistance" means a grant, loan or tax increment financing that result in a financial benefit from an agency, commission, instrumentality, or other entity of the District government.

"Affiliated employee" means any individual employed by a recipient who received compensation directly from government assistance or a contract with the District of Columbia government, including any employee of a contractor or subcontractor of a recipient who performs services pursuant to government assistance or contract. The term "affiliated employee" does not include those individuals who perform only intermittent or incidental services with respect to the contract or government assistance or who are otherwise employed by the contractor, recipient or subcontractor.

Certain exceptions apply where contracts are subject to higher wage level determinations required by federal law; contracts delivered by regulated utility; contracts for services needed immediately to prevent or respond to a disaster or imminent threat to the public health or safety declared by the Mayor; contracts awarded to recipients that provide trainees with additional services provided the trainee does not replace employees; tenants or retail establishments that occupy property constructed or improved by government assistance, provided there is no receipt of direct District government assistance; Medicaid provider agreements for direct care services to Medicaid recipients, however, a home care agency, a community residential facility or a group home for persons with intellectual disabilities shall not be required to pay a living wage until implementing regulations are published in the D.C. Register and any necessary state plan amendments are approved; and contracts or other agreements between managed care organizations and the Health Care Safety Net Administration or the Medicaid Assistance Administration to provide health services.

Exemptions are provided for employees under 22 years of age employed during a school vacation period, or enrolled as a full-time student who works less than 25 hours per week, and for employees of nonprofit organizations that employ not more than 50 individuals.

Each recipient and subcontractor of a recipient shall provide this notice to each affiliate employee covered by this notice, and shall also post this notice in a conspicuous site in its place of business.

All recipients and subcontractors shall retain payroll records created and maintained in the regular course of business under District of Columbia law for a period of at least 3 years.

For the complete text of the Living Wage Act of 2006 go to D.C. Official Code §§ 2-220.01-.11

To file a claim, visit: Department of Employment Services, Office of Wage-Hour, 4058 Minnesota Avenue, NE, Fourth Floor, Washington, D.C. 20019; call: (202) 671-1880; or file your claim on-line: does.dc.gov. Go to "File a Claim" tab.



LIVING WAGE ACT FACT SHEET

The "Living Wage Act of 2006," Title I of D.C. Law 16-18, (D.C. Official Code §§2-220.01-.11) became effective June 9, 2006. It provides that District of Columbia government contractors and recipients of government assistance (grants, loans, tax increment financing) in the amount of \$100,000 or more shall pay affiliated employees wages no less than the current living wage rate.

Effective January 1, 2015, the living wage rate is \$13.80 per hour.

Subcontractors of D.C. government contractors who receive \$15,000 or more from the contract and subcontractors of the recipients of government assistance who receive \$50,000 or more from the assistance are also required to pay their affiliated employees no less than the current living wage rate.

"Affiliated employee" means any individual employed by a recipient who receives compensation directly from government assistance or a contract with the District of Columbia government, including any employee of a contractor or subcontractor of a recipient who performs services pursuant to government assistance or a contract. The term "affiliated employee" does not include those individuals who perform only intermittent or incidental services with respect to the government assistance or contract, or who are otherwise employed by the contractor, recipient or subcontractor.

Exemptions – The following contracts and agreements are exempt from the Living Wage Act:

- 1. Contracts or other agreements that are subject to higher wage level determinations required by federal law (i.e., if a contract is subject to the Service Contract Act and certain wage rates are lower than the District's current living wage, the contractor must pay the higher of the two rates);
- 2. Existing and future collective bargaining agreements, provided that the future collective bargaining agreement results in the employee being paid no less than the current living wage;
- 3. Contracts for electricity, telephone, water, sewer or other services provided by a regulated utility;
- 4. Contracts for services needed immediately to prevent or respond to a disaster or imminent threat to public health or safety declared by the Mayor;
- 5. Contracts or other agreements that provide trainees with additional services including, but not limited to, case management and job readiness services, provided that the trainees do not replace employees subject to the Living Wage Act;
- 6. An employee, under 22 years of age, employed during a school vacation period, or enrolled as full-time student, as defined by the respective institution, who is in high school or at an accredited

institution of higher education and who works less than 25 hours per week; provided that he or she does not replace employees subject to the Living Wage Act;

- 7. Tenants or retail establishments that occupy property constructed or improved by receipt of government assistance from the District of Columbia; provided, that the tenant or retail establishment did not receive direct government assistance from the District of Columbia;
- 8. Employees of nonprofit organizations that employ not more than 50 individuals and qualify for taxation exemption pursuant to Section 501 (c) (3) of the Internal Revenue Code of 1954, approved August 16, 1954 (68A Stat. 163; 26. U.S.C. §501(c)(3);
- 9. Medicaid provider agreements for direct care services to Medicaid recipients, provided, that the direct care service is not provided through a home care agency, a community residence facility, or a group home for persons with intellectual disabilities as those terms are defined in section 2 of the Health-Care and Community Residence Facility, Hospice, and Home Care Licensure Act of 1983, effective February 24, 1984 (D.C. Law 5-48; D.C. Official Code §44-501); provided however, that a home care agency, a community residence facility, or a group home for persons with intellectual disabilities shall not be required to pay a living wage until implementing regulations are published in the D.C. Register and any necessary state plan amendments are approved; and
- 10. Contracts or other agreements between managed care organizations and the Health Care Safety Net Administration or the Medicaid Assistance Administration to provide health services.

Enforcement

The Department of Employment Services (DOES) and the D.C. Office of Contracting and Procurement (OCP) share monitoring responsibilities.

If you learn that a contractor subject to this law is not paying at least the current living wage you should report it to the Contracting Officer.

If you believe that your employer is subject to this law and is not paying you at least the current living wage, you may file a complaint with the DOES Office of Wage – Hour, located at 4058 Minnesota Avenue, NE, Fourth Floor, Washington, DC 20019, call (202) 671-1880, or file your claim on-line: does.dc.gov. Go to "File a Claim" tab.

For questions and additional information, contact the Office of Contracting and Procurement at (202) 727-0252 or the Department of Employment Services on (202) 671-1880.

Please note: This fact sheet is for informational purposes only as required by Section 106 of the Living Wage Act. It should not be relied on as a definitive statement of the Living Wage Act or any regulations adopted pursuant to the law.

Attachment G

First Source Agreement and Employment Plan



GOVERNMENT OF THE DISTRICT OF COLUMBIA FIRST SOURCE EMPLOYMENT AGREEMENT FOR NON CONSTRUCTION PROJECTS ONLY



GOVEKNIVIEN I-ASSISTED FRO		
CONTRACT/SOLICITATION NUM	/IBER:	
DISTRICT CONTRACTING AGEN	ICY:	
CONTRACTING OFFICER:		
TELEPHONE NUMBER:		
TOTAL CONTRACT AMOUNT:		
EMPLOYER CONTRACT AMOUN	VT:	
PROJECT NAME:		
PROJECT ADDRESS:		
CITY:	STATE:	ZIP CODE:
PROJECT START DATE:		PROJECT END DATE:
PROJECT START DATE: EMPLOYER START DATE:		EMPLOYER END DATE:
EMPLOYER INFORMATION		
EMPLOYER NAME:		
EMPLOYER ADDRESS:		
CITY:	STATE:	ZIP CODE:
TELEPHONE NUMBER:	FED	ZIP CODE: DERAL IDENTIFICATION NO.:
CONTACT PERSON:		
TITLE:		
E-MAIL:		TELEPHONE NUMBER:
LOCAL, SMALL, DISADVANTAC	ED BUSINES	S ENTERPRISE (LSDBE) CERTIFICATION
NUMBER:		
D.C. APPRENTICESHIP COUNCIL		
ARE YOU A SUBCONTRACTOR [☐ YES ☐ NO	O IF YES, NAME OF PRIME
CONTRACTOR:		
NONPROFIT ORGANIZATION	WITH 50 EN	MPLOYEES OR LESS: Yes No

This First Source Employment Agreement (Agreement), in accordance with Workforce Intermediary Establishment and Reform of the First Source Amendment Act of 2011 (D.C. Official Code §§ 2-219.01 – 2.219.05) and relevant provisions of the Apprenticeship Requirements Amendment Act of 2004 (D.C. Official Code § 2-219.03 and § 32-1431) for recruitment, referral, and placement of District of Columbia residents, is between the District of Columbia Department of Employment Services (DOES) and EMPLOYER. Pursuant to this Agreement, the EMPLOYER shall use DOES as its first source for recruitment, referral, and placement of new hires or employees for all new jobs created by the Government Assisted Project or Contract (Project). The Employer will hire 51% District of Columbia residents (DC residents) for all new jobs created by the Project and 35% of all apprenticeship hours worked in connection with the Project shall be worked by DC residents registered in programs approved by the District of Columbia Apprenticeship Council.

I. **DEFINITIONS**

The following definitions shall govern the terms used in this Agreement.

A. **Apprentice** means a worker who is employed to learn an apprenticeable occupation under the terms and conditions of approved apprenticeship standards.

B. Beneficiary means:

1. The signatory to a contract executed by the Mayor which involves any District of
Page 1 of 10 First Source Agreement. Revised September 2013

Columbia government funds or funds which, in accordance with a federal grant or otherwise, the District government administers and which details the number and description of all jobs created by a government-assisted project or contract for which the beneficiary is required to use the First Source Register.

- 2. A recipient of a District government economic development action, including contracts, grants, loans, tax abatements, land transfers for redevelopment, or tax increment financing that results in a financial benefit of \$300,000 or more from an agency, commission, instrumentality, or other entity of the District government, including a financial or banking institution which serves as the repository for \$1 million or more of District of Columbia funds.
- 3. A retail or commercial tenant that is a direct recipient of a District government economic development action, including contracts, grants, loans, tax abatements, land transfers for public redevelopment, or tax increment financing in excess of \$300,000.
- C. Contracting Agency means any District of Columbia agency that is awarded a government-assisted project or contract totaling \$300,000 or more.
- D. **Direct labor costs** means all costs, including wages and benefits, associated with the hiring and employment of personnel assigned to a process in which payroll expenses are traced to the units of output and are included in the cost of goods sold.
- E. **EMPLOYER** means any entity awarded a government-assisted project or contract totaling \$300,000 or more.
- F. **First Source Employer Portal** means the website consisting of a connected group of static and dynamic (functional) pages and forms on the World Wide Web accessible by Uniform Resource Locator (URL) and maintained by DOES to provide information and reporting functionality to EMPLOYERS.
- G. **First Source Register** means the DOES Automated Applicant Files, which consists of the names of District of Columbia residents registered with DOES.
- H. Good faith effort means an EMPLOYER has exhausted all reasonable means to comply with any affirmative action, hiring, or contractual goal(s) pursuant to the First Source law and Agreement.
- I. Government-assisted project or contract means any construction or non-construction project or contract receiving funds or resources from the District of Columbia or funds or resources which, in accordance with a federal grant or otherwise, the District of Columbia government administers, including contracts, grants, loans, tax abatements or exemptions, land transfers, land disposition and development agreements, tax increment financing, or any combination thereof, that is valued at \$300,000 or more.
- J. Hard to employ means a District of Columbia resident who is confirmed by DOES as:
 - 1. An ex-offender who has been released from prison within the last 10 years;
 - 2. A participant of the Temporary Assistance for Needy Families program;
 - 3. A participant of the Supplemental Nutrition Assistance Program;
 - 4. Living with a permanent disability verified by the Social Security Administration or

District vocational rehabilitation program;

- 5. Unemployed for six (6) months or more in the last 12-month period;
- 6. Homeless;
- 7. A participant or graduate of the Transitional Employment Program established by § 32-1331; or
- 8. An individual who qualified for inclusion in the Work Opportunity Tax Credit Program as certified by DOES.
- K. Indirect labor costs means all costs, including wages and benefits, that are part of operating expenses and are associated with the hiring and employment of personnel assigned to tasks other than producing products.
- L. Jobs means any union and non-union managerial, nonmanagerial, professional, nonprofessional, technical or nontechnical position, including: clerical and sales occupations; service occupations; processing occupations; machine trade occupations; bench work occupations; structural work occupations; agricultural, fishery, forestry, and related occupations; and any other occupations as DOES may identify in the Dictionary of Occupational Titles, United States Department of Labor.
- M. Journeyman means a worker who has attained a level of skill, abilities, and competencies recognized within an industry as having mastered the skills and competencies required for the occupation.
- N. **Revised Employment Plan** means a document prepared and submitted by the EMPLOYER that includes the following:
 - 1. A projection of the total number of new positions that will be created as a result of the project or contract, including the job title, number of positions available, indication of part-time or full-time status, salary range, union affiliation (if applicable) and the projected hire dates;
 - 2. A roster of all current employees to include the name, Social Security Number, and address of all current employees, including apprentices, trainees, and transfers from other projects, who will be employed on the project or contract;
 - 3. A projection of the total number of full-time and part-time salaried employees on an annual basis that will be utilized on the project or contract and the total number of full-time and part-time salaried employees that will be District residents;
 - 4. A projection of the total number of hours to be worked on the project or contract by full-time and part-time hourly wage employees on an annual basis and a projection of the total number of hours to be worked on the project or contract by full-time and part-time hourly wage employees who are District residents;
 - 5. A timetable outlining the total number of hours to be worked on the project or contract by full-time and part-time hourly wage employees by job category and the total number of full-time and part-time salaried employees by job category over the duration of the life of the hiring requirements set forth by DOES and an associated hiring schedule which predicts when specific job openings will be available;

- 6. Descriptions of the skill requirements by job title or position, including industry-recognized certifications required for the different positions;
- 7. A strategy to fulfill DC resident hiring percentage pursuant to this Agreement, including a component on communicating these requirements to contractors and subcontractors and a component on potential community outreach partnerships with the University of the District of Columbia, the University of the District of Columbia Community College, DOES, Jointly Funded Apprenticeship Programs, the District of Columbia Workforce Intermediary, or other government-approved, community-based job training providers;
- A remediation strategy to ameliorate any problems associated with meeting these hiring requirements, including any problems encountered with contractors and subcontractors;
- 9. The designation of a senior official from the EMPLOYER who will be responsible for implementing the hiring and reporting requirements;
- Descriptions of the health and retirement benefits that will be provided to DC residents working on the project or contract;
- 11. A strategy to ensure that DC residents who work on the project or contract receive ongoing employment and training opportunities after they complete work on the job for which they were initially hired and a review of past practices in continuing to employ DC residents from one project or contract to the next;
- A strategy to hire graduates of District of Columbia Public Schools, District of Columbia Public Charter Schools, and community-based job training providers, and hard-to-employ DC residents; and
- 13. A disclosure of past compliance with the Workforce Act and the Davis-Bacon Act, where applicable, and the EMPLOYER'S general DC resident hiring practices on projects or contracts completed within the last 2 years.
- O. **Tier Subcontractor** means any contractor selected by the primary subcontractor to perform portion(s) or all work related to the trade or occupation area(s) on a contract or project subject to this First Source Agreement.
- P. Washington Metropolitan Statistical Area means the District of Columbia; Virginia Cities of Alexandria, Fairfax, Falls Church, Fredericksburg, Manassas, and Manassas Park; the Virginia Counties of Arlington, Clarke, Fairfax, Fauquier, Loudon, Prince William, Spotsylvania, Stafford, and Warren; the Maryland Counties of Calvert, Charles, Frederick, Montgomery, and Prince Georges; and the West Virginia County of Jefferson.
- Q. Workforce Intermediary Pilot Program means the intermediary between employers and training providers to provide employers with qualified DC resident job applicants. See DC Official Code § 2-219.04b.

II. GENERAL TERMS

A. Subject to the terms and conditions set forth herein, DOES will receive the Agreement from the Contracting Agency no less than seven (7) calendar days in advance of the Project start date. No work associated with the relevant Project can begin until the Agreement has been accepted by DOES.

- B. The EMPLOYER will require all Project contractors and Project subcontractors with contracts or subcontracts totaling \$300,000 or more to enter into an Agreement with DOES.
- C. DOES will provide recruitment, referral, and placement services to the EMPLOYER, subject to the limitations in this Agreement.
- D. This Agreement will take effect when signed by the parties below and will be fully effective for as long as the benefit is being received, or for commercial and retail tenants only, for five (5) years following the commencement of the tenant's initial lease.
- E. DOES and the EMPLOYER agree that, for purposes of this Agreement, new hires and jobs created for the Project (both union and nonunion) include all of EMPLOYER'S job openings and vacancies in the Washington Metropolitan Statistical Area created for the Project as a result of internal promotions, terminations, and expansions of the EMPLOYER'S workforce, as a result of this Project, including loans, lease agreements, zoning applications, bonds, bids, and contracts.
- F. This Agreement includes apprentices as defined in D.C. Official Code §§ 32-1401- 1431.
- G. DOES will make every effort to work within the terms of all collective bargaining agreements to which the EMPLOYER is a party. The EMPLOYER will provide DOES with written documentation that the EMPLOYER has provided the representative of any collective bargaining unit involved with this Project a copy of this Agreement and has requested comments or objections. If the representative has any comments or objections, the EMPLOYER will promptly provide them to DOES.
- H. EMPLOYER with a contract with the District of Columbia government to perform construction, renovation work, or information technology work with a single contract, or cumulative contracts, of at least \$500,000, within a 12-month period will be required to register an apprenticeship program with the District of Columbia Apprenticeship Council as required by DC Code 32-1431.
- I. If, during the term of this Agreement, the EMPLOYER should transfer possession of all or a portion of its business concerns affected by this Agreement to any other party by lease, sale, assignment, merger, or otherwise this First Source Agreement shall remain in full force and effect and transferee shall remain subject to all provisions herein. In addition, the EMPLOYER as a condition of transfer shall:
 - 1. Notify the party taking possession of the existence of this EMPLOYER'S First Source Employment Agreement.
 - 2. Notify DOES within seven (7) business days of the transfer. This notice will include the name of the party taking possession and the name and telephone of that party's representative.
- J. The EMPLOYER and DOES may mutually agree to modify this Agreement. Any modification shall be in writing, signed by the EMPLOYER and DOES, and attached to the original Agreement.
- K. To the extent that this Agreement is in conflict with any federal labor laws or governmental regulations, the federal laws or regulations shall prevail.

III. TRAINING

A. DOES and the EMPLOYER may agree to develop skills training and on-the-job training

programs as approved by DOES; the training specifications and cost for such training will be mutually agreed upon by the EMPLOYER and DOES and will be set forth in a separate Training Agreement.

IV. RECRUITMENT

- A. The EMPLOYER will post all job vacancies with the Job Bank Services of DOES at http://does.dc.gov within seven (7) days of executing the Agreement. Should you need assistance posting job vacancies, please contact Job Bank Services at (202) 698-6001.
- B. The EMPLOYER will notify DOES of all new jobs created for the Project within at least seven (7) business days (Monday Friday) of the EMPLOYER'S identification/creation of the new jobs. The Notice of New Job Creation shall include the number of employees needed by job title, qualifications and specific skills required to perform the job, hiring date, rate of pay, hours of work, duration of employment, and a description of the work to be performed. This must be done before using any other referral source.
- C. Job openings to be filled by internal promotion from the EMPLOYER'S current workforce shall be reported to DOES for placement and referral, if the job is newly created. EMPLOYER shall provide DOES a Notice of New Job Creation that details such promotions in accordance with Section IV.C.
- D. The EMPLOYER will submit to DOES, prior to commencing work on the Project, a list of current employees that includes the name, Social Security Number, and residency status of all current employees, including apprentices, trainees, and laid-off workers who will be employed on the Project. All EMPLOYER information reviewed or gathered, including Social Security Numbers, as a result of DOES' monitoring and enforcement activities will be held confidential in accordance with all District and federal confidentiality and privacy laws and used only for the purposes that it was reviewed or gathered.

V. REFERRAL

- A. DOES will screen applicants through carefully planned recruitment and training events and provide the EMPLOYER with a list of qualified applicants according to the number of employees needed by job title, qualifications and specific skills required to perform the job, hiring date, rate of pay, hours of work, duration of employment, and a description of the work to be performed as supplied by the EMPLOYER in its Notice of New Job Creation set forth above in Section IV.C.
- B. DOES will notify the EMPLOYER of the number of applicants DOES will refer, prior to the anticipated hiring dates.

VI. PLACEMENT

- A. The EMPLOYER shall in good faith, use reasonable efforts to select its new hires or employees from among the qualified applicants referred by DOES. All hiring decisions are made by the EMPLOYER.
- B. In the event that DOES is unable to refer qualified applicants meeting the EMPLOYER'S established qualifications, within seven (7) business days (Monday Friday) from the date of notification from the EMPLOYER, the EMPLOYER will be free to directly fill remaining positions for which no qualified applicants have been referred. The EMPLOYER will still be required to meet the hiring or hours worked percentages for all new jobs created by the Project.

C. After the EMPLOYER has selected its employees, DOES is not responsible for the employees' actions and the EMPLOYER hereby releases DOES, and the Government of the District of Columbia, the District of Columbia Municipal Corporation, and the officers and employees of the District of Columbia from any liability for employees' actions.

VII. REPORTING REQUIREMENTS

- A. EMPLOYER with Projects valued at a minimum of \$300,000 shall hire DC residents for at least 51% of all new jobs created by the Project and 35% of all apprenticeship hours worked in connection with the Project shall be worked by DC residents registered in programs approved by the District of Columbia Apprenticeship Council.
- B. EMPLOYER with Projects valued at a minimum of \$5,000,000 shall hire DC residents for at least 51% of all new jobs created by the Project and 35% of all apprenticeship hours worked in connection with the Project shall be worked by DC residents registered in programs approved by the District of Columbia Apprenticeship Council; the EMPLOYER will complete the attached Revised Employment Plan that will include the information outlined in Section I.N. above and meet with DOES personnel for an orientation and introduction to personnel responsible for training resources offered by the agency.
- C. EMPLOYER shall have a user name and password for the First Source Employer Portal for electronic submission of all monthly Contract Compliance Forms, weekly certified payrolls and any other documents required by DOES for reporting and monitoring.
- D. EMPLOYER with Projects valued at a minimum of \$300,000 shall provide the following monthly and cumulative statistics on the Contract Compliance Form:
 - 1. Number of new job openings created/available;
 - 2. Number of new job openings listed with DOES, or any other District Agency;
 - 3. Number of DC residents hired for new jobs;
 - 4. Number of employees transferred to the Project;
 - 5. Number of DC residents transferred to the Project;
 - 6. Direct or indirect labor cost associated with the project;
 - 7. Each employee's name, job title, Social Security Number, hire date, residence, and referral source;
 - 8. Number of apprenticeship hours worked;
 - 9. Number of apprenticeship hours worked by DC residents; and
 - 10. Workforce statistics throughout the entire project tenure.
- E. Monthly, EMPLOYER must electronically submit the Contract Compliance Form to DOES.. EMPLOYER is also required to make payroll and employment records available to DOES as a part of compliance monitoring, upon request.

VIII. FINAL REPORT AND GOOD FAITH EFFORTS

- A. With the submission of the final request for payment from the Contracting Agency, the EMPLOYER shall:
 - Document in a report to DOES its compliance with the hiring or hours worked percentage requirements for all new jobs created by the Project and the percentages of DC residents employed in all Trade Classifications, for each area of the Project; or
 - 2. Submit to DOES a request for a waiver of the hiring or hours worked percentage

requirements for all new jobs created by the Project that will include the following documentation:

- a. Documentation supporting EMPLOYER'S good faith effort to comply;
- b. Referrals provided by DOES and other referral sources; and
- c. Advertisement of job openings listed with DOES and other referral sources.
- B. DOES may waive the hiring or hours worked percentage requirements for all new jobs created by the Project, and/or the required percentages of DC residents in all Trade Classifications areas on the Project, if DOES finds that:
 - EMPLOYER demonstrated a good faith effort to comply, as set forth in Section C, below; or
 - 2. EMPLOYER is located outside the Washington Metropolitan Statistical Area and none of the contract work is performed inside the Washington Metropolitan Statistical Area; or
 - 3. EMPLOYER entered into a special workforce development training or placement arrangement with DOES or with the District of Columbia Workforce Intermediary; or
 - 4. DOES certified that there are insufficient numbers of DC residents in the labor market possessing the skills required by the EMPLOYER for the positions created as a result of the Project. No failure by Employer to request a waiver under any other provision hereunder shall be considered relevant to a requested waiver under this Subsection.
- C. DOES shall consider documentation of the following when making a determination of a good-faith effort to comply:
 - 1. Whether the EMPLOYER posted the jobs on the DOES job website for a minimum of ten (10) calendar days;
 - 2. Whether the EMPLOYER advertised each job opening in a District newspaper with city-wide circulation for a minimum of seven (7) calendar days;
 - 3. Whether the EMPLOYER advertised each job opening in special interest publications and on special interest media for a minimum of seven (7) calendar days;
 - 4. Whether the EMPLOYER hosted informational/recruiting or hiring fairs;
 - 5. Whether the EMPLOYER contacted churches, unions, and/or additional Workforce Development Organizations;
 - 6. Whether the EMPLOYER interviewed employable candidates;
 - 7. Whether the EMPLOYER created or participated in a workforce development program approved by DOES;
 - 8. Whether the EMPLOYER created or participated in a workforce development program approved by the District of Columbia Workforce Intermediary;
 - 9. Whether the EMPLOYER substantially complied with the relevant monthly reporting requirements set forth in this section;
 - 10. Whether the EMPLOYER has submitted and substantially complied with its most

11. Any additional documented efforts.

IX. MONITORING

- A. DOES is the District agency authorized to monitor and enforce the requirements of the Workforce Intermediary Establishment and Reform of the First Source Amendment Act of 2011 (D.C. Official Code §§ 2 219.01 2.219.05), and relevant provisions of the Apprenticeship Requirements Amendment Act of 2004 (D.C. Official Code § 2-219.03 and § 32-1431). As a part of monitoring and enforcement, DOES may require and EMPLOYER shall grant access to Project sites, employees, and documents.
- B. EMPLOYER'S noncompliance with the provisions of this Agreement may result in the imposition of penalties.
- C. All EMPLOYER information reviewed or gathered, including Social Security Numbers, as a result of DOES' monitoring and enforcement activities will be held confidential in accordance with all District and federal confidentiality and privacy laws and used only for the purposes that it was reviewed or gathered.
- D. DOES shall monitor all Projects as authorized by law. DOES will:
 - 1. Review all contract controls to determine if EMPLOYER and Subcontractors are subject to DC Law 14-24.
 - 2. Notify stakeholders and company officials and establish meetings to provide technical assistance involving the First Source process.
 - 3. Make regular site visits to determine if the EMPLOYER or Subcontractor's workforce is in concurrence with the submitted Agreement and Monthly Compliance Reports.
 - 4. Inspect and copy certified payroll, personnel records and any other records or information necessary to ensure the required workforce utilization is in compliance with the First Source Law.
 - 5. Conduct desk reviews of *Monthly Compliance Reports*.
 - 6. Educate EMPLOYERS about additional services offered by DOES, such as On-the-Job Training programs and tax incentives for EMPLOYERS who hire from certain categories.
 - 7. Monitor and complete statistical reports that identify the overall project, contractor, and subcontractors' hiring or hours worked percentages.
 - 8. Provide formal notification of non-compliance with the required hiring or hours worked percentages or any alleged breach of the First Source Law to all contracting agencies, and stakeholders. (Please note: EMPLOYERS are granted 30 days to correct any alleged deficiencies stated in the notification.)

X. PENALTIES

A. Willful breach of the Agreement by the EMPLOYER, failure to submit the Contract Compliance Reports, deliberate submission of falsified data, or failure to reach specific hiring or hours worked requirements may result in DOES imposing a fine of 5% of the total amount

of the direct and indirect labor costs of the contract for the positions created by EMPLOYER.

- B. EMPLOYERS who have been found in violation two (2) times or more over a 10-year period may be debarred and/or deemed ineligible for consideration for Projects for a period of five (5) years.
- C. Appeals of violations or fines are to be filed with the Contract Appeals Board.

I hereby certify that I have the authority to bind	d the EMPLOYER to this Agreement.
By:	
EMPLOYER Senior Official	_
Name of Company	_
Address	_ _
Telephone	
Email	_
Associate Director for First Source Department of Employment Services 4058 Minnesota Avenue, NE Third Floor Washington, DC 20019 202-698-6284 firstsource@dc.gov	Date

EMPLOYMENT PLAN

NAME OF EMPLOYER:	
ADDRESS OF EMPLOYER:	
TELEPHONE NUMBER:	FEDERAL IDENTIFICATION NO.:
CONTACT PERSON:	TITLE:
E-MAIL:	_TYPE OF BUSINESS:
DISTRICT CONTRACTING AGENCY: _	
CONTRACTING OFFICER:	TELEPHONE NUMBER:
TYPE OF PROJECT:	CONTRACT AMOUNT:
EMPLOYER CONTRACT AMOUNT:	
PROJECT START DATE:	PROJECT END DATE:
EMPLOYER START DATE:	EMPLOYER END DATE:

NEW JOB CREATION PROJECTIONS: Please indicate ALL new position(s) your firm will create as a result of the Project. If the firm WILL NOT be creating any new employment opportunities, please complete the attached justification sheet with an explanation. Attach additional sheets as needed.

JOB TITLE	# OF JOBS F/T P/T	SALARY RANGE	UNION MEMBERSHIP REQUIRED NAME LOCAL#	PROJECTED HIRE DATE
A				
В				
С				
D				
Е				
F				
G				
Н				
Ι				
J				
K				

CURRENT EMPLOYEES: Please list the names, residency status and ward information of all current employees, including apprentices, trainees, and transfers from other projects, who will be employed on the Project. Attach additional sheets as needed.

NAME OF EMPLOYEE	CURRENT DISTRICT RESIDENT √Please Check	WARD

JUSTIFICATION SHEET: Please provide a detailed explanation of why the Employer will not have any new hires on the Project.			
K.			

Attachment H

Davis-Bacon Wage Determination

General Decision Number: DC150002 10/09/2015 DC2

Superseded General Decision Number: DC20140002

State: District of Columbia

Construction Type: Building

County: District of Columbia Statewide.

BUILDING CONSTRUCTION PROJECTS (does not include single family homes or apartments up to and including 4 stories).

Note: Executive Order (EO) 13658 establishes an hourly minimum wage of \$10.10 for 2015 that applies to all contracts subject to the Davis-Bacon Act for which the solicitation is issued on or after January 1, 2015. If this contract is covered by the EO, the contractor must pay all workers in any classification listed on this wage determination at least \$10.10 (or the applicable wage rate listed on this wage determination, if it is higher) for all hours spent performing on the contract. The EO minimum wage rate will be adjusted annually. Additional information on contractor requirements and worker protections under the EO is available at www.dol.gov/whd/govcontracts.

Modification	Number	Publication	Date
0	TTORIDOL	01/02/2015	2466
1		01/09/2015	
2		02/20/2015	
3		03/06/2015	
4		04/03/2015	
5		05/08/2015	
6		05/22/2015	
7		06/26/2015	
8		07/03/2015	
9		07/17/2015	
10		08/07/2015	
11		08/14/2015	
12		09/11/2015	
13		09/18/2015	
14		10/09/2015	

ASBE0024-007 10/01/2013

1	Rates	Fringes
ASBESTOS WORKER/HEAT & FROST		
INSULATOR\$	33.13	13.76

Includes the application of all insulating materials, protective coverings, coatings and finishes to all types of mechanical systems

Rates Fringes

ASBESTOS WORKER: HAZARDOUS

MATERIAL HANDLER.....\$ 20.86 5.46

Includes preparation, wetting, stripping, removal, scrapping, vacuuming, bagging and disposing of all insulation materials, whether they contain asbestos or not, from mechanical systems

ASBE0024-014 10/01/2013

Rates Fringes

FIRESTOPPER.....\$ 26.06 5.90

Includes the application of materials or devices within or around penetrations and openings in all rated wall or floor assemblies, in order to prevent the pasage of fire, smoke of other gases. The application includes all components involved in creating the rated barrier at perimeter slab edges and exterior cavities, the head of gypsum board or concrete walls, joints between rated wall or floor components, sealing of penetrating items and blank openings.

BRDC0001-002 05/03/2015

Rates Fringes

BRICKLAYER.....\$ 30.36 9.69

CARP0132-008 05/01/2015

Rates Fringes

CARPENTER, Includes Drywall
Hanging, Form Work, and Soft
Floor Laying-Carpet.....\$ 27.56 9.08
PILEDRIVERMAN.....\$ 26.79 8.85

CARP1831-002 04/01/2013

Rates Fringes
MILLWRIGHT....\$31.59 8.58

Rates Fringes

ELEC0026-016 06/01/2015

ELECTRICIAN, Includes
Installation of
HVAC/Temperature Controls.....\$ 42.80 15.33

ELEC0026-017 09/01/2014

Rates Fringes

ELECTRICAL INSTALLER (Sound

& Communication Systems).....\$ 27.05

8.58

SCOPE OF WORK: Includes low voltage construction, installation, maintenance and removal of teledata facilities (voice, data and video) including outside plant, telephone and data inside wire, interconnect, terminal equipment, central offices, PABX, fiber optic cable and equipment, railroad communications, micro waves, VSAT, bypass, CATV, WAN (Wide area networks), LAN (Local area networks) and ISDN (Integrated systems digital network).

WORK EXCLUDED: The installation of computer systems in industrial applications such as assembly lines, robotics and computer controller manufacturing systems. The installation of conduit and/or raceways shall be installed by Inside Wiremen. On sites where there is no Inside Wireman employed, the Teledata Technician may install raceway or conduit not greater than 10 feet. Fire alarm work is excluded on all new construction sites or wherever the fire alarm system is installed in conduit. All HVAC control work.

ELEV0010-001 01/01/2015

Rates

Fringes

ELEVATOR MECHANIC.....\$ 41.09

28.385+a+b

- a. PAID HOLIDAYS: New Year's Day, Memorial Day, Independence Day, Labor Day, Veterans' Day, Thanksgiving Day, Christmas Day and the Friday after Thanksgiving.
- b. VACATIONS: Employer contributes 8% of basic hourly rate for 5 years or more of service; 6% of basic hourly rate for 6 months to 5 years of service as vacation pay credit.

IRON0005-005 06/01/2015

Rates

Fringes

IRONWORKER, STRUCTURAL AND

ORNAMENTAL....\$ 30.65

18.135

IRON0201-006 05/01/2015

Rates Fringes

IRONWORKER, REINFORCING.....\$ 27.50

18.58

LABO0657-015 06/01/2015

Rates Fringes

LABORER: Skilled......\$ 22.63 7.31

FOOTNOTE: Potmen, power tool operator, small machine operator, signalmen, laser beam operator, waterproofer, open caisson, test pit, underpinning, pier hole and ditches, laggers and all work associated with lagging that is not expressly stated, strippers, operator of hand derricks, vibrator operators, pipe layers, or tile layers, operators of jackhammers, paving breakers, spaders or any machine that does the same general type of work, carpenter tenders, scaffold builders, operators of towmasters, scootcretes, buggymobiles and other machines of similar character, operators of tampers and rammers and other machines that do the same general type of work, whether powered by air, electric or gasoline, builders of trestle scaffolds over one tier high and sand blasters, power and chain saw operators used in clearing, installers of well points, wagon drill operators, acetylene burners and licensed powdermen, stake jumper, demolition.

MARB0002-004 05/03/2015

Rates Fringes

MARBLE/STONE MASON.....\$ 35.19

15.72

INCLUDING pointing, caulking and cleaning of All types of masonry, brick, stone and cement EXCEPT pointing, caulking, cleaning of existing masonry, brick, stone and cement (restoration work)

MARB0003-006 05/03/2015

Rates Fringes

TERRAZZO WORKER/SETTER....\$ 26.75

10.28

MARB0003-007 05/03/2015

Rates Fringes

TERRAZZO FINISHER.....\$ 21.96 9.35

MARB0003-008 05/03/2015

Rates Fringes

TILE SETTER....\$ 26.75

MARB0003-009 05/03/2015

Rates

Fringes

TILE FINISHER		9.35
PAIN0051-014 06/01/2014		
	Rates	Fringes
GLAZIER		
Glazing Contracts \$2 million and under	.\$ 24.77	9.85
million		9.85
PAIN0051-015 06/01/2014		
	Rates	Fringes
PAINTER Brush, Roller, Spray and Drywall Finisher	\$ 24.89	9.05
PLAS0891-005 07/01/2013		
	Rates	Fringes
PLASTERER	\$ 28.33	5.85
PLAS0891-006 02/01/2014		
	Rates	Fringes
CEMENT MASON/CONCRETE FINISHER		9.61
PLAS0891-007 08/01/2014		
	Rates	Fringes
FIREPROOFER		
Handler		4.24
Mixer/Pump		4.24
Sprayer	\$ 23.00	4.24
Spraying of all Fireproofing ma Fireproofing materials. This in soft. Intumescent fireproofing including, but not limited to,	cludes wet or d and refraction	ry, hard or work,

including, but not limited to, all steel beams, columns, metal decks, vessels, floors, roofs, where ever fireproofing is required. Plus any installation of thermal and acoustical insulation. All that encompasses setting up for Fireproofing, and taken down. Removal of fireproofing materials and protection. Mixing of all materials either by hand or machine following manufactures standards.

PLUM0005-010 08/01/2015

Rates Fringes

PLUMBER	.\$ 39.67	16.60+a
a. PAID HOLIDAYS: Labor Day, and the day after Thanksgiving Day, Martin Luther King's Birt Fourth of July.	, Christmas Day	New Year's
* PLUM0602-008 08/01/2015		
	Rates	Fringes
PIPEFITTER, Includes HVAC Pipe Installation	.\$ 38.89	19.97+a
a. PAID HOLIDAYS: New Year's D Birthday, Memorial Day, Indepe Veterans' Day, Thanksgiving Da Thanksgiving and Christmas Day	endence Day, Labo y and the day as	or Day,
ROOF0030-016 05/01/2015		
	Rates	Fringes
ROOFER	.\$ 28.50	11.04
SFDC0669-002 04/01/2015		
	Rates	Fringes
SPRINKLER FITTER (Fire Sprinklers)	.\$ 32.40	18.12
SHEE0100-015 07/01/2015		
	Rates	Fringes
SHEET METAL WORKER (Including HVAC Duct Installation)	.\$ 39.79	16.77+a
a. PAID HOLIDAYS: New Year's D Birthday, Memorial Day, Indepe Veterans Day, Thanksgiving Day	ndence Day, Labo and Christmas I	or Day, Day
SUDC2009-003 05/19/2009		
	Rates	Fringes
LABORER: Common or General	\$ 13.04	2.80
LABORER: Mason Tender - Cement/Concrete	.\$ 15.40	2.85
LABORER: Mason Tender for pointing, caulking, cleaning		

of existing masonry, brick, stone and cement structures (restoration work); excludes pointing, caulking and cleaning of new or replacement masonry, brick, stone and cement............\$ 11.67

POINTER, CAULKER, CLEANER,
Includes pointing, caulking,
cleaning of existing masonry,
brick, stone and cement
structures (restoration
work); excludes pointing,
caulking, cleaning of new or
replacement
masonry, brick, stone or
cement.....\$ 18.88

WELDERS - Receive rate prescribed for craft performing operation to which welding is incidental.

Unlisted classifications needed for work not included within the scope of the classifications listed may be added after award only as provided in the labor standards contract clauses (29CFR 5.5 (a) (1) (ii)).

The body of each wage determination lists the classification and wage rates that have been found to be prevailing for the cited type(s) of construction in the area covered by the wage determination. The classifications are listed in alphabetical order of "identifiers" that indicate whether the particular rate is a union rate (current union negotiated rate for local), a survey rate (weighted average rate) or a union average rate (weighted union average rate).

Union Rate Identifiers

A four letter classification abbreviation identifier enclosed in dotted lines beginning with characters other than "SU" or "UAVG" denotes that the union classification and rate were prevailing for that classification in the survey. Example: PLUM0198-005 07/01/2014. PLUM is an abbreviation identifier of the union which prevailed in the survey for this classification, which in this example would be Plumbers. 0198 indicates the local union number or district council number where applicable, i.e., Plumbers Local 0198. The next number, 005 in the example, is an internal number used in processing the wage determination. 07/01/2014 is the effective date of the

most current negotiated rate, which in this example is July 1, 2014.

Union prevailing wage rates are updated to reflect all rate changes in the collective bargaining agreement (CBA) governing this classification and rate.

Survey Rate Identifiers

Classifications listed under the "SU" identifier indicate that no one rate prevailed for this classification in the survey and the published rate is derived by computing a weighted average rate based on all the rates reported in the survey for that classification. As this weighted average rate includes all rates reported in the survey, it may include both union and non-union rates. Example: SULA2012-007 5/13/2014. SU indicates the rates are survey rates based on a weighted average calculation of rates and are not majority rates. LA indicates the State of Louisiana. 2012 is the year of survey on which these classifications and rates are based. The next number, 007 in the example, is an internal number used in producing the wage determination. 5/13/2014 indicates the survey completion date for the classifications and rates under that identifier.

Survey wage rates are not updated and remain in effect until a new survey is conducted.

Union Average Rate Identifiers

Classification(s) listed under the UAVG identifier indicate that no single majority rate prevailed for those classifications; however, 100% of the data reported for the classifications was union data. EXAMPLE: UAVG-OH-0010 08/29/2014. UAVG indicates that the rate is a weighted union average rate. OH indicates the state. The next number, 0010 in the example, is an internal number used in producing the wage determination. 08/29/2014 indicates the survey completion date for the classifications and rates under that identifier.

A UAVG rate will be updated once a year, usually in January of each year, to reflect a weighted average of the current negotiated/CBA rate of the union locals from which the rate is based.

WAGE DETERMINATION APPEALS PROCESS

- 1.) Has there been an initial decision in the matter? This can be:
- * an existing published wage determination
- * a survey underlying a wage determination
- * a Wage and Hour Division letter setting forth a position on a wage determination matter

* a conformance (additional classification and rate) ruling

On survey related matters, initial contact, including requests for summaries of surveys, should be with the Wage and Hour Regional Office for the area in which the survey was conducted because those Regional Offices have responsibility for the Davis-Bacon survey program. If the response from this initial contact is not satisfactory, then the process described in 2.) and 3.) should be followed.

With regard to any other matter not yet ripe for the formal process described here, initial contact should be with the Branch of Construction Wage Determinations. Write to:

Branch of Construction Wage Determinations Wage and Hour Division U.S. Department of Labor 200 Constitution Avenue, N.W. Washington, DC 20210

2.) If the answer to the question in 1.) is yes, then an interested party (those affected by the action) can request review and reconsideration from the Wage and Hour Administrator (See 29 CFR Part 1.8 and 29 CFR Part 7). Write to:

Wage and Hour Administrator U.S. Department of Labor 200 Constitution Avenue, N.W. Washington, DC 20210

The request should be accompanied by a full statement of the interested party's position and by any information (wage payment data, project description, area practice material, etc.) that the requestor considers relevant to the issue.

3.) If the decision of the Administrator is not favorable, an interested party may appeal directly to the Administrative Review Board (formerly the Wage Appeals Board). Write to:

Administrative Review Board U.S. Department of Labor 200 Constitution Avenue, N.W. Washington, DC 20210

4.) All decisions by the Administrative Review Board are final.

Attachment I

Bid Bond Form

Attachment I

GOVERNMENT OF THE DISTRICT OF COLUMBIA

PROPOSAL BOND	Date Bond Executed:					
(See Instructions on 2 nd page)	(Must Not be Later Than Bid Opening Date)					
PRINCIPAL (Legal Name and Address)	TYPE OF ORGANIZATION ("X")					
	[] INDIVIDUAL [] PARTNERSHIP					
	[] JOINT VENTURE [] CORPORATION					
	STATE OI	INCORI	PORATIO	ON		
	PENAL SU	JM OF BO	OND			
SURETY(IES) (Name(s) and Address(es))	AMOUNT	NOT TO	EXCEEI)		5% OF BID
	MILLION(S)	THOUSAND	P(S)	HUNDRED(S)	CENTS	
	DDODOG	AL IDE	NUTTOIL	CATION	1	
	PROPOS	AL IDE				
	PROPOSAL		REQUEST FOR PROPOSAL NO.			SAL NO.
	CLOSING DAT	'E				
KNOW ALL MEN BY THESE PRESENTS, that we,	the Principal and Surety	(ies) hereto	are firmly	bound to the Distri	ict of Col	umbia Government, a
municipal corporation, hereinafter called "the Distric						
successors, jointly and severally; Provided that, where "jointly" and "severally" only for the purpose of allow						
and severally with the Principal, for the payment of su						
the limit of liability shall be the full amount of the pena		. оррожие и		saci saretj, sat n		induity is indicated,
THE COMPLETION OF THE OPLICATION IS SHO	TI died element de Dite				NOW	THEREFORE 1641.
THE CONDITION OF THIS OBLIGATION IS SUC Principal shall not withdraw said bid within the period						
days after said receipt, and shall within the period spec						
do so, furnish Performance & Payment Bonds with go	od and sufficient surety, a	s may be re	quired, for	the faithful perform	nance and	l proper fulfillment of
the Contract, and for the protection of all persons su						
event of withdrawal of said bid, within the period sp						
District the difference between the amount specified in said bid and the amount for which the District may procure the required work and/or supplies, if the latter amount be in excess of the former, then the above obligations shall be void and of no effect, otherwise to remain in full force and virtue. Each						
Surety executing this bond hereby agrees that its obligation shall not be impaired by extension(s) of time for acceptance of the bid that the Principal may						
grant to the District, notice of which extension(s) to Surety (ies) being hereby waived: Provided that such waiver of notice shall apply only with respect to extensions aggregating not more than sixty (60) calendar days in addition to the period originally allowed for acceptance of the bid.						
extensions aggregating not more than sixty (60) calenda	ar days in addition to the p	erioa origin	any anowed	for acceptance of t	ne bid.	
IN WITNESS WHEREOF, the Principal and Surety (id	es) have executed this bid	bond and ha	ve affixed th	neir seals on the dat	e set forth	above.
PRINCIPAL						
1. SIGNATURE		1. AT	TEST			Corporate
		1			- 1	Seal
Seal		1			- 1	
Name & Title (typed)		Name	& Title	(typed)		
Name & Title (typed)		Name	& Thic	(typeu)	- 1	
2. SIGNATURE		2. AT	TEST			Corporate
						Seal
Cost						
Seal						
Name & Title (typed)						
		Name	& Title	(typed)		
		Name	& Title	(typed)		

CERTIFICATE AS TO CORPORATION

I,							
Secretary of Corporation							
SURETY(IES)							
1. Name & Address (typed)	State of Inc.	Liability Limit	Corporate Seal				
Signature of Attorney-in-Fact	Attest (Signature)	Attest (Signature)					
Name & Address (typed)	Name & Addr	Name & Address (typed)					
1. Name & Address (typed)	State of Inc.	Liability Limit	Corporate Seal				
Signature of Attorney-in-Fact	Attest (Signature)	Attest (Signature)					
Name & Address (typed)	Name & Addre	Name & Address (typed)					
INSTRUCTIONS							

- 1. This form shall be used whenever a bid guaranty is required in connection with construction, alteration and repair work.
- 2. Corporations name should appear exactly as it does on Corporate Seal and inserted in the space designated "Principal" on the face of this form. If practicable, bond should be signed by the President or Vice President; if signed by other official, evidence of authority must be furnished. Such evidence should be in the form of an Extract or Minutes of a Meeting of the Board of Directors, or Extract of Bylaws, certified by the Corporate Secretary, or Assistant Secretary and Corporate Seal affixed thereto. CERTIFICATE AS TO CORPORATION must be executed by Corporate Secretary or Assistant Secretary.
- 3. Corporations executing the bond as sureties must be among those appearing on the U. S. Treasury Department's List of approved sureties and must be acting within the limitations set forth therein, and shall be licensed by the Insurance Administration, Department of Consumer and Regulatory Affairs, to do business in the District of Columbia. The surety shall attach hereto an adequate Power-Of-Attorney for each representative signing the bond.
- 4. Corporations executing the bond shall affix their Corporate Seals. Individuals shall sign full first name, middle initial and last name opposite the word "seal", two witnesses must be supplied, and their addresses, under the word "attest". If executed in Maine or New Hampshire, an adhesive seal shall be affixed.
- 5. Names of all partners must be set out in body of bond form, with the recital that they are partners composing a firm, naming it, and all members of the firm shall execute the bond as individuals. Each signature must be witnessed by two persons and addresses supplied.

Attachment J

Bid Guaranty Certification

Attachment J

Certification Letter for Cashier's Check or Irrevocable Letter of Credit

Offerors who submit a cashier's check or an irrevocable letter of credit ("Alternate Bid Security") in lieu of a bid bond must also submit this certification, properly notarized, with their proposal. By executing this document, Offeror acknowledges that, if awarded this contract, Offeror shall be required to post promptly a payment and performance bond equal to the full value of the contract. In the event Offeror fails to post such payment and performance bond, the Offeror understands and agrees that; (i) the Department shall draw upon the Alternate Bid Security as liquidated damages; (ii) the award and or contract shall be terminated; (iii) for a period of two (2) years thereafter, the Department will not accept from such Offeror Alternate Bid Security in lieu of a bid bond; and (iv) the Offeror hereby waives the right to protest the termination of any such award or contract. The Offeror further acknowledges and agrees that the damages the Department would experience in the event such award or contract are terminated due to the Offeror's failure to post a payment and performance bond are difficult to determine and that the value of the Alternate Bid Security represents a reasonable estimate of the damages the Department would incur.

By:	
Name:	
Title:	,
Date:	
(District of Columbia):	
On the day of, 20	015, before me, a notary public in and for the District
of Columbia, personally appeared	, who acknowledged
himself/herself to be	of , and
	so, executed the foregoing instrument for the purposes
therein contained.	
IN WITNESS WHEREOF, I have hereunt	o set my hand and official seal.
	Notary Public
	My Commission Expires:

Attachment K

Award/Signature Page

ANA DDICONTDACT		1. Ca	Caption Page of Pages		age of Pages		
	AWARD/CONTRACT			Renovation of DYRS	. 1	70	
				mnasium and Courtya	rd	70	
2. Solicitation/C	Contract Number	3. Effective Dat	e 4. Re	equisition/Purchase Requ	uest/Project No.		
DCAM-16-NC-0	0040	See Block 18	C				
5. Issued By:			6. Ac	Iministered by (If other th	nan line 5)		
Department of General Services Contracts and Procurement Division 2000 14 th Street, 8 th Floor				·			
Washington, D							
7. Name and Address of Contractor				8. Delivery ☐FOB Origin ☐Other			
			9. RE	9. RESERVED			
				10. Submit invoices as described in Section I.3.			
11. RESERVED				12. Payment will be made by			
			Depa Office 2000	Government of the District of Columbia Department of General Services Office of the Chief Financial Officer 2000 14 th Street, 5 th Floor Washington, DC 20009			
42. A - lun avula da				Amanda and Na		Data	
	gement of Amendments ledges receipt of amendments t	to the	-	Amendment No.		Date	
SOLICITATION	louges recorpt or amenaments						
14. Supplies/Ser	vices/Price						
	Scope Of Work and Bid Form	m (Attachment A)					
		15.	Table of	Contents			
Section	1 1 1 1	Description				ages	
Α		Cover Page/Sig		nge		age 1- Page 3	
В		Scope of				Page 4- Page 18	
С		Economic I				Page 19- Page 26	
D		Lump Sur			Pag	Page 27 – Page 29	
	E Evaluation and Award Criteria Page 30						
	F Bid Organization and Submission Page 31 – Page 32						
	G Bidding Procedures and Protests Page 33 – Page 35						
H	H Insurance and Bond Requirements				Page 36 - Page 37		
	Department's Responsibilities				Page 38 - Page 44		
	J Contract Changes				Page 45 – Page 49		
K Miscellaneous Provisions				Page 50 - Page 67			
L Definitions Page 68 - Page 70 Contracting Officer will complete Item 16					je 68 - Page 70		
16. AWARD Your bid for the above referenced Solicitation including your Bid and Offer Letter and Bid Form is hereby accepted. Contractor agrees to furnish and deliver all items, perform all the services set forth or otherwise identified above and on any continuation sheets, for the consideration stated herein.							
17A. Name and Title of Signer (Type or print)			18A, Name of Contracting Officer				
17B.		17C. Date	Signed	18B.		18C. Date Signed	
	(Signature of person authorized	I to sign)		(Sign	nature of Contracting Officer)		



